

Implementation of the Erosion Sediment Pollution Control Plan

The foregoing procedures and all requirements of the specifications are contractual obligations of the CONTRACTOR performing the actual construction work. Said requirements also apply to any and all subcontractors working on the project. This plan will be implemented throughout the course of construction.

The requirements relative to temporary control measures, early permanent restoration and minimizing work areas, are the most important factors affecting construction performance. In view of these circumstances, it is believed that this particular plan, on this particular project, will be implemented throughout the course of work.

Use of the Erosion Sediment Pollution Control Plan

As previously stated herein, the "Erosion and Sediment Pollution Control Plan" has been prepared in response to the requirements of the Pennsylvania Department of Environmental Protection. The handling of storm water, the topographic and geological features described, the types and classifications of soils, the sloping of earthwork, the temporary and permanent erosion control and the resulting control devices used for the purpose of eliminating, minimizing, and/or controlling pollution of the streams and waterways from materials anticipated to be eroded from the earthwork to be disturbed as a result of construction of the work.

Project Description

The Waste Water Treatment Plant (WWTP) Expansion Project required the authority to obtain adjacent property with the development of a new WWTP Head Works Building and Sequential Batch Reactor tanks. This project also includes the construction of a new Process Air Building, Digester Air Building, Chlorine Building and UV Disinfection Channel. Also included in this work is interconnection of Process piping, Utility Piping, New Asphalt Driveway, Stone Driveway and Repairing of Plant Roads.

Wetlands

There are no wetlands within the site construction area.

Sequencing And Staging Of Construction

General

The intent of the sequence of construction is to ensure that adequate control measures are provided for the areas in which construction activities are occurring at all times. Under no circumstances will earth moving activities begin until the erosion control devices (BMP's) for the areas involved are installed.

Sequence Of Construction

Refer to the **Utility Line Trench Excavation Procedure** for limits on trench excavation before following this sequence.

Clear and grub areas shown on the plans where filter fabric is proposed to be installed. install filter fabric fencing, super filter fabric fencing, rock construction entrance, sand inlet filter baffle protection at locations illustrated on the construction drawings. Not all planned filter fabric fencing may not be limited to these areas. Filter fabric fencing maybe used in combination with seed/mulching to stabilize areas disturbed by unforeseen construction.

Mobile equipment to site. Deliniate project boundary limits, clearly marking all pertinent features in the field.

After BMP's are installed and functioning properly, topsoil will be stripped from site in areas designated for grading/excavation or hauled offsite. Contractor's erosion and sediment control measures are installed at the opposite ends. Topsoil Tapped shall be temporarily seeded immediately after all topsoil is stripped as per the temporary seeding specifications on the E&S Plan.

Earthwork shall commence after all previously installed BMP's are checked and operational. Earthwork shall consist of cut and fill operations, including excavation for tank and building foundations as well as storm water, water, gas, air, sewer, and electrical lines. Excess excavated material shall be hauled off site to the contractor's approved stockpile site. During earthmoving activity, immediate control measures will be taken to limit excessive erosion to work area (i.e. filter fabric fence), as soon as any portion of the site is brought up to final design grade permanent slopes shall be permanently seeded as per seeding specifications on this plan.

Contractor's site superintendent will be responsible for the inspection of all erosion and sediment pollution control measures weekly and immediately after any run-off event. Corrective procedures shall be taken with in 24 hours in the event an inspection should reveal the need for maintenance of existing measures or the placement of additional control measures to the site prior to any continued earthmoving or site improvement activities.

Upon completion of earth moving activities and the establishment of a uniform 70% perennial vegetative cover, all temporary BMP's may be removed.

General Notes

1. Earthwork for the project shall consist of the necessary excavation and grading for the construction of new tankage as well as the construction of a new driveway, buildings, and the digging of trenches in which the proposed pipelines shall be installed.

2. Natural vegetation shall be preserved whenever possible throughout the project area. Vegetative cover will be established as soon as possible by seeding and mulching all disturbed areas. Disturbed areas will be limited to as small a section as possible on any one time.

3. Silt fence shall be installed prior to any construction activities. Silt fence shall be installed temporarily along toe of slope adjacent to trenches as required to filter run-off from exposed fill slope. Silt fence shall be removed upon establishment of a uniform 70% perennial vegetative cover.

4. Storm inlet Filter Protection shall be applied where noted, prior to excavation and removed upon site stabilization (uniform 70% perennial vegetative cover).

5. The CONTRACTOR shall inspect and maintain all BMP's on a weekly basis and after every run-off event during construction. Any repairs shall be made with in 24 hours.

6. For utility line excavation, spoil piles shall be placed upside of trench. Filter fabric fence shall be placed across graded trench on steeper slopes to retard run-off. All disturbed paved areas shall be restored in kind unless otherwise noted.

7. All excavation and grading shall be accomplished in a manner that complies with all the requirements and standards set forth in the Soil Erosion and Sedimentation Control Manual, Pennsylvania DEP.

8. The contractor working on site shall be responsible for all items of soil erosion and sedimentation control pertaining to his specific phase of work. Control measures shall be protected and maintained at all times to completion of project.

9. Contractor shall remove all accumulated sediment and dispose of the material at a DEP and Allegheny County Conservation District approved waste site.

10. Contractor will be responsible in submitting an erosion and sediment pollution control plan and obtaining appropriate permits by the DEP for the waste material disposal areas. Contractor shall not dispose of any soil to any area until the site is approved.

11. After final site stabilization has been achieved (final stabilization is defined as uniform 70% perennial vegetation), temporary erosion and sedimentation controls must be removed. Areas disturbed during the removal of the controls must be stabilized immediately.

12. Contractor shall be responsible for performing environmental due diligence on oil fill material imported to or exported from the site to certify that oil material is "clean fill".

13. Contractor shall be required to obtain approval from Allegheny County Conservation District for all offsite waste/borrow areas.

Utility Line Trench Excavation Procedure

General:

Except where trench excavations have high potential for accelerated erosion and sediment pollution. Since these excavations are usually located at lower elevations along or across earth disturbance sites, open trenches serve to concentrate sediment laden runoff and convey it to site boundaries or waterways. The most important erosion and sediment pollution control consideration for trench construction is the limiting and specific scheduling of work activities.

Construction Requirements:

a. Limit advance clearing and grubbing operations to a distance equal to two times the length of pipe installation that can be completed in one day.

b. Work crews and equipment for trenching, placement of pipe, plug construction and backfilling will be self contained and separate from clearing and grubbing and site restoration and stabilization operations.

c. Limit direct trench excavation to the length of pipe, plug assembly, plug installation and backfilling that can be completed in one day.

d. Water which accumulates in the open trench will be completely removed by pumping as shown on the PUMPED DISCHARGE SEDIMENT TRAP DETAIL before pipe placement and/or backfilling begins.

e. On the day following pipe placement and trench backfilling, the disturbed area will be graded to final contours and appropriate temporary erosion and sediment pollution control measures/facilities will be installed. Seeding and mulching of all disturbed areas will be done at the end of each week.

Exceptions:

In certain cases trenches cannot be backfilled until the pipe is hydrostatically tested, or anchors and other permanent features are installed. In these cases, ALL temporary requirements listed under CONSTRUCTION REQUIREMENTS will remain in effect with the following exceptions:

(1) Daily backfilling of the trench may be delayed for six (6) days. All pressure testing and the complete backfilling of the open trench must be completed by the seventh (7) working day.

(2) If daily backfilling is delayed, the disturbed area will be graded to final contours, appropriate temporary erosion and sediment control measures/facilities will be installed, and the areas seeded and mulched within the next two (2) calendar days.

Vegetation

General: All grounds disturbed by any of the operations necessary to complete the work for this project are to be permanently seeded, unless occupied by structures or paved. This is to be accomplished as soon as possible after construction and not later than ten (10) days.

If seeding cannot be completed within the ten day period due to weather conditions, the disturbed area shall be mulched with straw at the rate of 3 ton per acre. This straw shall be anchored with mulch netting according to the manufacturer's recommendations or other appropriate means.

Temporary seeding will be used to protect exposed land surfaces which will not be permanently protected for a period more than two months, but less than twelve months. Temporary vegetation will provide short-term rapid cover until permanent vegetation or other protection can be established.

Temporary Seeding Specifications: The purpose of temporary cover is to provide short-term rapid cover for the control of runoff and erosion until vegetation or old stable soil material can be established. Temporary cover shall be applied on all seed producing areas where the period of exposure will be more than two months, but less than twelve months. Mulch cover shall be provided for less than two month's exposure.

The utility line construction is to be progressive with backfilling followed immediately. If it is necessary to stockpile soil, temporary grass cover shall be established where soil stockpiles are to be exposed for a period greater than thirty (30) days. When the backfilling is re-exposed for a period greater than twenty (20) days, but less than thirty (30) days, the stockpile shall be covered with mulch or protective erosion control fabric.

The site preparation and establishment of temporary cover shall be conducted according to the following guidelines:

- Install needed surface water control measures.
- Perform all cultural operations at right angles to the slope.
- Apply ground limestone according to test or at the rate of 180 lb./1000 sq. ft.
- Apply uniformly recommended analysis fertilizer according to soil test or 10-20-20 at the rate of 23 lb./1000 sq. ft.
- Work in lime and fertilizer to a depth of 4 in. using any suitable equipment.
- Temporary cover seed mixture shall consist of 100% annual rye grass. Seed shall be applied uniformly at the rate of 1 lb./1000 sq. ft. during the recommended planting dates of March 1 to June 15 and August 15 to October 15.
- Cover grass seed with ½ in. of soil with suitable equipment.

Permanent Seeding Specifications:

All areas will have permanent vegetation established. Areas along the pipelines shall have permanent vegetation established immediately upon completion of the pipeline. Sediment control devices will be removed only when the final vegetative cover and permanent facilities are completed. Completed areas will be covered with a minimum 4 inches of topsoil.

After the topsoil has been properly distributed, lime in the form of raw ground limestone shall be applied in an amount to be determined from an analysis of the soil by a qualified soil sampling service; then one week after lime is applied, spring fertilizer will be added. Fertilizer in the amount of 5-10-10, nitrogen-phosphorus and potash respectively, shall be spread at the rate of 30 lb. per 1000 sq. ft. after which mulch shall be added. The entire area shall then be properly tilled and rotted - raked to a smooth grade. Stone shall be removed from the site and the original seedling area (approximately 10%) shall consist of a mixture of 48% Kentucky 31 tall fescue and 12% red top, sown at the rate of 2 pounds per 1000 square foot. The area shall then be lightly brushed or raked to provide slight covering over the seed, after which it shall be gently rolled at a rate of 6 lbs. per square foot. Fertilizer should be applied at a rate of 100 lbs. of N, 200 lbs. of P_2O_5 and 200 lbs. K₂O per acre (eg. 1,000 lbs. of 10-20-20 per acre).

Sowing may be done mechanically, by hand, or by an approved method of hydroseeding. In the latter case, alternate means of fertilizing combined with seeding will be permitted upon approval of methods by the OWNER's representative. Mulching material shall be in accordance with the recommendations of a local recognized nurseryman approved by the OWNER's representative.

Mulching:

The purpose of mulch is to reduce erosion, prevent surface compaction, crusting, conserve moisture and aid in establishing plant cover and control weeds. Mulch shall be applied on any area subject to erosion, or which has unfavorable conditions for plant establishment and growth. The practice may be used along or in conjunction with other stabilizing and vegetative conservation practices such as waterways, ponds, sedimentation traps or critical area planting. On sediment producing areas where the period of exposure is less than two months, mulch materials shall be applied according to the following guidelines:

- For areas subject to critical erosion, temporary erosion control measures shall be installed within or adjacent to area to be mulched shall be installed.
- Straw or hay mulch shall be applied at the rate of 3 tons per acre. Chemically treated or salted straw or hay is not acceptable as mulch.
- Straw or hay mulch shall be anchored by either peg or twine or mulch netting.
- Mulched areas shall be checked periodically and immediately after severe storms for damage until the desired purpose of the mulching is achieved. Damaged portions of the mulch or tie-down material shall be repaired as soon as discovered.

Type of Soil Disturbed by Construction

The soil information for the project was obtained from the Soil Survey Interpretation for Allegheny County prepared by the U.S. Department of Agriculture Soil Conservation Service. The CONTRACTOR shall make his own interpretation of the information when necessary as to how it may or may not affect any or all work under this project, and shall be responsible for all construction activities resulting hereto and resulting therefrom. Soil within construction limits are as follows:

URB – Urban land-Rainsboro complex, gently sloping.

This mapping unit is on terraces. Slopes are 0 to 8 percent.

The composition of this mapping unit is more variable and areas are generally much larger than those of most other mapping units in the county. Mapping is adequate, however, for the anticipated uses of the soils.

Included in mapping area small areas of Allegheny varient and Ernest soils and small areas of soils that have slopes of more than 8 percent. Also included, mostly in the suburbs, are soils that are mainly Rainsboro soils. In other areas, including much of Pittsburgh, the Rainsboro soils are minor extent.

Seasonal wetness is generally a limitation.

The intense urban development precludes most other land uses in the undeveloped areas, onsite investigation is required to determine the kind and degree of limitations. Not assigned a capability unit.

According to the Soil Survey of Allegheny County, Pennsylvania conducted by the USDA Soil Conservation Service, Urban Land-Rainsboro Complex is composed of Hybrid soils, some talus and limestone being its major components. This unit will be addressed using the following BMP's: Filter Fabric Fence, Intel Filter Bags, Super Filter Fabric Fence and Rock Construction Entrance. A Pump Discharged Sediment Trap will also be used in dewatering all excavations.

No	Date	Revisions	Date	Revisions
Scale:	1:1250		Scale:	1:1250
Date:	February 2009		Date:	February 2009
Drawn By:	DHS		Drawn By:	DHS
Checked By:	HOF		Checked By:	HOF
Approved By:	ME		Approved By:	ME
Sheet No.	5		Sheet No.	5

KLH ENGINEERS, INC.

**MUNICIPAL AUTHORITY OF THE CITY OF MCKEESEPORT
ALLEGHENY COUNTY, PENNSYLVANIA
CONTRACT NUMBER 2010-01 AND 2010-02
WASTEWATER TREATMENT PLANT EXPANSION**

EROSION AND SEDIMENT POLLUTION CONTROL PLAN SHEET 5 OF 6

220-WPS

Well vegetated area 5% slope or less.

NOTES:

- The filter bag shall trap particles larger than 130 microns.
- The pumping rate for the filter bag shall not exceed 750 gpm or ½ the maximum specified by the manufacturer, whichever is less. Pump intake shall be floating or screened.
- Once half full, the filter bag and trapped sediment shall be disposed by the contractor at the contractors dump site.
- Pump filter bag shall be inspected regularly and repaired within 24 hours if found defective. Pumping will cease upon any problem with the filter bag and must be resumed until the problem is corrected.

FILTER BAG SPECIFICATIONS

Typical Properties	
Weight	ASTM D3776 8.3 oz/yd
Thickness	ASTM D1777 120 mils
Gross Tensile	ASTM D4632 240 lbs.
Gross Elongation	ASTM D4632 50%
Breathability	
Puncture Resistance	ASTM D4633 115 lbs.
Trapezoidal Tear	ASTM D4533 100 lbs.
Mullen Burst Water	ASTM D3786 350 lbs.
Flow	ASTM D4491 1.7 sec. -1
Permeability	ASTM D4491 0.56 str. rel.
UV Resistance	ASTM D4355 36° str. rel.
Bog Dimensions	15'ft x 13.25ft

PLAN VIEW

TYPICAL SECTION:

MINIMUM 6" - 5" ASHTO No. 57

Well vegetated area 5% slope or less.

Super Silt Fence

Design Standards/Restrictions

- The maximum slope length above any super silt fence should not exceed that shown in Table C. The slope length shown is the distance from the fence to the drainage divide or the nearest upslope channel.
- Super silt fence should not be used in areas where rock or rocky soils prevent full and uniform anchoring of the fence or proper installation of the fence posts. It should be used only when access exists or can be made for the construction equipment required to install and remove the chain link fencing.
- Super silt fence should be installed at grade level. Both ends of fence section should be extended at least 8 feet upslope at 45 degrees to the main fence alignment to allow for pooling of water.
- The formation of concentrated flows on the drainage slope above a super silt fence is not permitted. If concentrated flows do occur, direct slope stabilization measures must be employed to prevent such conditions.
- Silt fences will not be placed in any area of concentrated flows such as ditches, swales, channels, etc.
- Silt fences will not be used in areas where rock or rocky soils prevent full and uniform anchoring of the fence toe.
- Silt fences material will not be placed across the entrance to pipes or culverts and will not be wrapped around the principal spillway structures of sediment traps or basins.

Illustration Filter Fabric Fence Detail

NTB.

STANDARD 18" MAX FENCE HEIGHT

REINFORCED SECTION 30" MAX FENCE HEIGHT

JOINED FENCE SECTIONS

NOTE: STANDARD 18" FILTER FABRIC SHALL BE INSTALLED AS SHOWN ON SITE PLAN UNLESS OTHERWISE NOTED

Standard Silt Fence Details

NTB.

PLAN VIEW

SECTION A-A

Maintenance

Rock construction entrance thickness shall be constantly monitored to the specified dimensions by adding rock. A stocking shall be maintained on site for this purpose. At the end of each construction day, all sediment deposited on paved roadways shall be removed and returned to the construction site.

Rock Construction Entrance

NTB.

UP SLOPE FACE

OUTLET CROSS-SECTION

Rock Filter Outlet

Maintenance

- Sediment must be removed when the accumulations reach ½ height of the outlet and disposed by the Contractor at a DEP and Allegheny County Conservation District approved waste site.

Rock Filter Outlet

NTB.

Super Filter Fabric Fence

Design Standards/Restrictions

- The maximum slope length above any super silt fence should not exceed that shown in Table C. The slope length shown is the distance from the fence to the drainage divide or the nearest upslope channel.
- Super silt fence should not be used in areas where rock or rocky soils prevent full and uniform anchoring of the fence or proper installation of the fence posts. It should be used only when access exists or can be made for the construction equipment required to install and remove the chain link fencing.
- Super silt fence should be installed at grade level. Both ends of fence section should be extended at least 8 feet upslope at 45 degrees to the main fence alignment to allow for pooling of water.
- The formation of concentrated flows on the drainage slope above a super silt fence is not permitted. If concentrated flows do occur, direct slope stabilization measures must be employed to prevent such conditions.
- Silt fences will not be placed in any area of concentrated flows such as ditches, swales, channels, etc.
- Silt fences will not be used in areas where rock or rocky soils prevent full and uniform anchoring of the fence toe.
- Silt fences material will not be placed across the entrance to pipes or culverts and will not be wrapped around the principal spillway structures of sediment traps or basins.

Maintenance

The contractor shall appoint an inspector who is experienced and qualified in E&S controls to conduct regular inspections of Best Management Practices (BMPs) and perform any required maintenance. Inspector shall maintain weekly inspection records.

Installation

- An 8' deep trench should be excavated, minimizing the disturbance on the downslope side. The bottom of the trench should be at level grade. Maximum deviation from level grade should be 5%, and not extend for more than 50 ft.
- A chain link fence shall be installed in the downslope side of the trench. Posts on the up-slope side of the poles. Posts should be 2 ½" diameter galvanized or aluminum posts set at 10' minimum spacing. Support posts must be installed by a post hole drill a minimum 36" below the ground surface and extend a minimum of 33" above ground surface. Poles do not need to be set in concrete.
- Filter fabric should be stretched and securely fastened to the fence with wire fasteners, staples, or preformed clips. It should extend a minimum 33" above ground surface.
- At fabric ends, both ends should be overlapped a minimum 6", folded, and secured to the fence. The fabric toe should be placed in the bottom of the trench, backfilled and compacted.

Maintenance

- The contractor shall appoint an inspector who is experienced and qualified in E&S controls to conduct regular inspections of Best Management Practices (BMPs) and perform any required maintenance. Inspector shall maintain weekly inspection records.
- Regular inspection and maintenance of BMPs shall begin immediately upon installation and continue until its removal. Any necessary repairs will be made within 24 hours. The fence installation should be inspected weekly and after every run-off event.
- Accumulated sediment will be removed as required to keep the fence functional. In all cases remove deposits where accumulations reach ½ the above ground height of the fence.
- Any section of Filter fabric fence which has been undermined or topped must be replaced by the end of the workday with a Rock Filter Outlet. See Rock Filter Outlet Detail.
- Adhere to any manufacturer's recommendations for replacing silt fence due to weathering.
- All trapped sediment shall be disposed by the Contractor at a DEP and Allegheny County Conservation District approved waste site.

Support Posts

- No. 7 Ga. Tension Wire
- Fabric Fence
- Chain Link Fence (2" Woven Mesh Fabric)
- No. 7 Ga. Tension Wire

SECTION A-A

JOINED FENCE SECTIONS

* Posts spaced @ 10' Max. Use 2 ½" dia. galvanized or aluminum posts
** Chain Link to Post Fasteners spaced @ 14' max. Use No. 6 Ga aluminum wire or No. 9 galvanized steel pre-formed clip. Chain Link to Tension Wire Fasteners spaced @ 60" max. Use No. 10 galvanized steel wire. Fabric to Chain Fasteners spaced @ 24" max. C to C.

Super Filter Fabric Fence

NTB.

INSTALLATION DETAIL

BAG DETAIL

Maintenance

Storm inlet Filter Bags shall be inspected weekly and after every runoff event. Any torn or damaged bag shall be replaced with 24 hours. Filter Bags shall be emptied when ½ full, with the debris properly disposed of.

Storm Inlet Filter Bag Protection Detail


NTB.

Scale: Not Scale
Date: February 2010
Drawn By: DRD
Checked By: HOF
Approved By: ME
Sheet No.: 6
Drawing No.: 220-WP6

MUNICIPAL AUTHORITY OF THE CITY OF MCKEESEPORT
ALLEGHENY COUNTY, PENNSYLVANIA
CONTRACT NUMBER 2010-L-01 AND 2010-02
WASTEWATER TREATMENT PLANT CONTROL PLAN SHEET 6 OF 6

\$173 Cambria Run Road
Mt. Pleasant, PA 15328
Phone: 412-239-4426
Fax: 412-239-4427
Email: info@klhinc.com

KLH
ENGINEERS, INC.

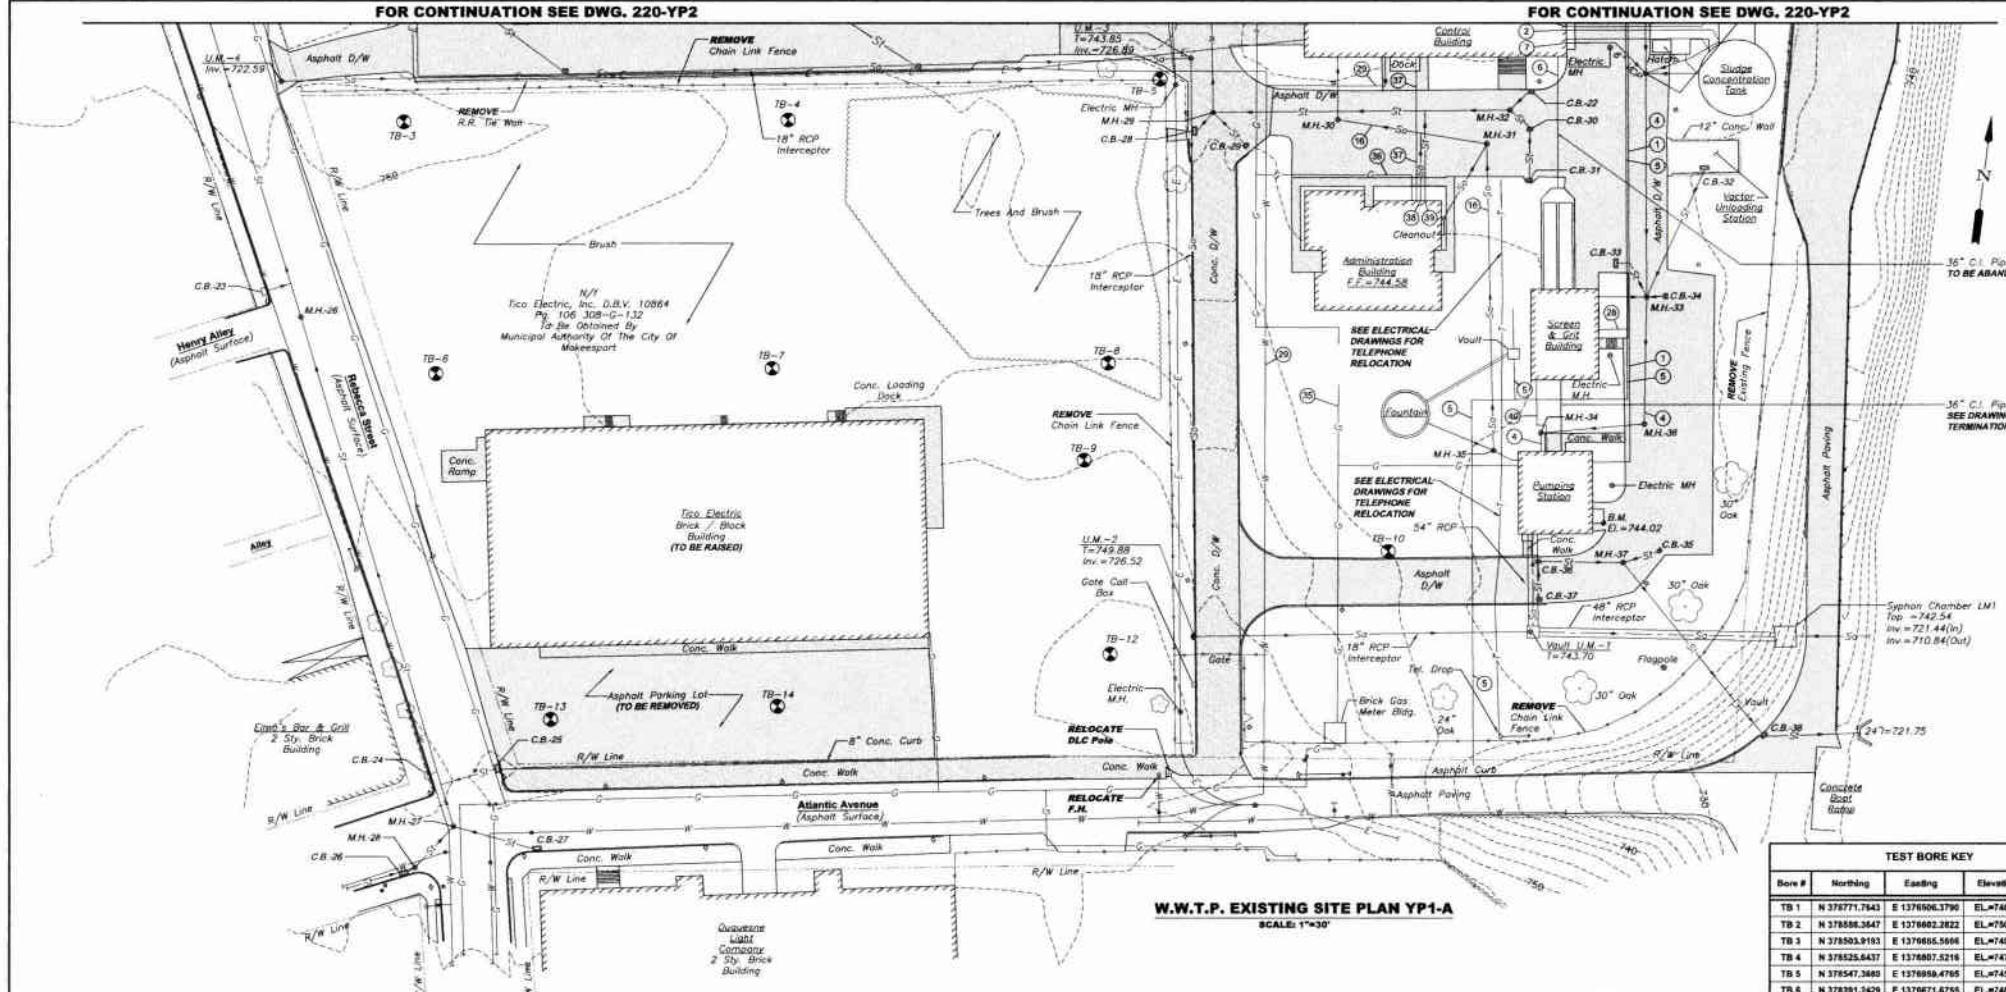

Existing Piping Key	
(1) (PW) 1 1/4" Potable Water	22) Drain
(2) (TS) 4" C.I. Thickened Sludge @ E.L. 730.50	24) Drain
(3) (TS) 6" C.I. Thickened Sludge @ E.L. 730.50	25) 1" Tank Drain
(4) 12" VCP Sewer To Pump Station	26) 12" C.I. Plant Water
(5) (EW) 2" Effluent Water	27) 36" RCCP Plant Outfall
(6) 36" C.I. From Grate Chamber @ E.L. 734.00	28) 1 1/4" Effluent Water
(7) (RD) 6" C.I. Recycle / Drains @ E.L. 737.54	29) Potable Water
(8) (PW) 3" Final Water To Concentration Tanks @ E.L. 737.54	30) 36" C.I. Final Tank Effluent
(9) 8" C.I. Primary & Waste Secondary Sludge @ E.L. 737.54	31) 36" C.I. Final Tank Influent
(10) (PW) 12" Galvanized Steel Air To Flotation Tanks @ E.L. 738.00	32) 24" C.I. Return Sludge
(11) (BD) 6" C.I. Scum Drain @ E.L. 733.50	33) 12" Waste Activated Sludge
(12) (BD) 6" C.I. Sludge From Settling Tanks @ E.L. 730.87	34) 8" Tank Drain
(13) (BD) 6" C.I. Scum Drain @ E.L. 733.50	35) 8" Natural Gas
(14) (CS) 3" Steel Chlorine Solution @ E.L. 739.00	36) 2" Natural Gas
(15) (CS) 3" Steel Chlorine Solution @ E.L. 739.00	37) 1 1/2" Potable Water
(16) (RD) 12" C.I. Recycle / Drain	38) Sanitary
(17) (SS) 6" C.I. Sludge Suction @ E.L. 736.67	39) 8" Road Drain
(18) (SS) 6" C.I. Sludge Suction @ E.L. 736.67	40) 1 1/2" Natural Gas
(19) (SS) 6" C.I. Sludge Suction @ E.L. 736.67	
(20) (SorD) 8" C.I. Scrubber Drain	
(21) 8" Supernatent	
(22) 8" Supernatent	

Existing Catch Basins		
C.B. No.	Top El.	Inv. El. (In/Out)
C.B.-1	741.97	739.37
C.B.-2	742.70	733.10
C.B.-3	742.67	732.77
C.B.-4	741.99	738.59
C.B.-5	744.09	740.59
C.B.-6	742.93	739.13
C.B.-7	742.78	739.18
C.B.-8	742.98	738.85
C.B.-9	743.57	738.67
C.B.-10	743.37	739.07
C.B.-11	743.04	741.04
C.B.-12	743.14	739.54
C.B.-13	742.50	740.40
C.B.-14	743.08	740.88
C.B.-15	743.10	740.10(8")
C.B.-16	741.65	739.20
C.B.-17	740.13	737.03
C.B.-18	739.82	736.32
C.B.-19	740.44	737.84
C.B.-20	742.62	740.12
		739.82

Existing Catch Basins		
C.B. No.	Top El.	Inv. El. (In)
C.B.-21	742.81	740.21
C.B.-22	742.70	739.87
C.B.-23	748.92	742.96
C.B.-24	749.79	748.92
C.B.-25	748.95	744.85
C.B.-26	749.91	745.83
C.B.-27	740.38	746.96
C.B.-28	743.27	738.47
C.B.-29	743.31	739.81
C.B.-30	742.57	*
C.B.-31	742.28	738.72
C.B.-32	742.26	735.48
C.B.-33	742.03	738.73
C.B.-34	743.02	740.32
C.B.-35	742.48	737.78
C.B.-36	742.23	738.23
C.B.-37	742.12	738.43
C.B.-38	737.59	724.08

* Filled with Debris

Existing Manholes				
M.H. No.	Top El.	Inv. El. (In)	Inv. El. (Out)	Inv. El. (In/Out)
M.H.-1	742.23	726.15	726.72	
M.H.-2	742.34	729.39 (38")	729.00 (38")	
M.H.-3	743.47			
M.H.-4	BURIED			
M.H.-5	743.34			
M.H.-6	750.09			
M.H.-7	746.23			
M.H.-8	742.58			
M.H.-9	743.04			
M.H.-10	740.72			
M.H.-11	740.55	735.92(8")		729.64
M.H.-12	743.71			
M.H.-13	743.25			
M.H.-14	743.89	737.99(8") (West)		738.60(8")
M.H.-15	743.30	740.25(8") (North West)		739.55(8") (South East)
M.H.-16	741.84			
M.H.-17	740.26			
M.H.-18	741.16			
M.H.-19	741.97			
M.H.-20	743.04			

Existing Manholes				
M.H. No.	Top El.	Inv. El. (In)	Inv. El. (Out)	Inv. El. (In/Out)
M.H.-21	742.37			737.72
M.H.-32	743.16	738.89 (South West)		738.27 (South)
M.H.-34				737.54 (North East)
M.H.-25	742.70	724.82	724.48	
M.H.-34	743.11	724.32(10") (East)		724.31
M.H.-25	741.06	725.54(8") (North West)		724.11
M.H.-10	740.72	728.35(8") (North East)		724.28(10") (East)
M.H.-26	748.50			738.84
M.H.-27	743.71			735.85
M.H.-28	740.83	745.75 (South East)	740.83	
M.H.-29	743.51			738.23
M.H.-30	743.50			719.41
M.H.-31	743.11	738.09 (8")		717.68 (12")
M.H.-32	743.10			726.84
M.H.-33	743.30	739.52 (East)		723.86
M.H.-34		739.41 (West)		738.13 (North West)
M.H.-35		738.33 (South)		738.17 (East)
M.H.-36				722.85
M.H.-37	743.20	737.19 (East)	736.92	
M.H.-38		737.57 (West)		

NOTE:
ITEMS IDENTIFIED WITH UPPER CASE TEXT ARE PROPOSED.
Items identified with Mixed Case Text are Existing.

MUNICIPAL AUTHORITY OF THE CITY OF MCKEESPORT
ALLENTOWN COUNTY, PENNSYLVANIA
CONTRACT NUMBER 2010-01 AND 2010-02
WASTEWATER TREATMENT PLANT EXPANSION
EXISTING YARD PIPE PLAN SHEET 1 OF 2

Drawing No. 220 - YP1
Sheet No. 1

Approved By: [Signature]

Checked By: [Signature]

Date: July 2009

Drawn By: [Signature]

Revised: [Signature]

Reviewed: [Signature]

Submitted: [Signature]

Date: 7-24-09

Phone: 1-218-410-5110

Fax: 1-218-410-4448

E-mail: info@klh-engineers.com

URL: www.klh-engineers.com

KLH
ENGINEERS, INC.

Address: 5173 CAMPBELL RUN ROAD
MCKEESPORT, PA 16159
PHOTO: 1-218-410-5110
FAX: 1-218-410-4448
E-MAIL: info@klh-engineers.com
URL: www.klh-engineers.com

TEST BORE KEY

Bore #	Northing	Easting	Elevation	Set
TB 1	N 378771.7843	E 137650.1179	EL=748.49	HUB
TB 2	N 378588.3647	E 137460.2322	EL=750.71	HUB
TB 3	N 378503.9193	E 137685.5696	EL=749.63	MAG HUB
TB 4	N 378525.6437	E 137480.5216	EL=747.78	HUB
TB 5	N 378547.3680	E 137689.4765	EL=745.40	HUB
TB 6	N 378591.3420	E 137671.6755	EL=748.79	MAG HUB
TB 7	N 378413.3746	E 137482.3694	EL=747.48	MAG HUB
TB 8	N 378434.8919	E 137697.3545	EL=747.71	HUB
TB 9	N 378356.1989	E 137693.2685	EL=750.88	HUB
TB 10	N 378265.3590	E 137711.3217	EL=745.79	HUB
TB 11	N 378259.4403	E 137651.7510	EL=751.26	MAG NAIL
TB 12	N 378311.2963	E 137693.2243	EL=752.26	MAG HUB
TB 13	N 378247.0480	E 137674.1660	EL=750.88	MAG NAIL

LEGEND

- UE EXISTING UNDERGROUND ELECTRIC
- Su EXISTING SANITARY SEWER
- SM EXISTING SANITARY MANHOLE
- SL EXISTING STORM SEWER
- FL EXISTING FENCE LINE
- TL EXISTING CONTOUR
- K 711.63 EXISTING CATCH BASIN
- G WATER LINE
- T TELEPHONE
- TB TEST BORE
- H HYDRANT
- EXISTING ASPHALT PAVING
- EXISTING CONCRETE / CONCRETE WALK

Sheet No.

Date:

Revised:

Reviewed:

Approved By:

Checked By:

Date:

Drawn By:

Revised:

Reviewed:

Submitted:


Date:

Phone:

Fax:


E-mail:

URL:

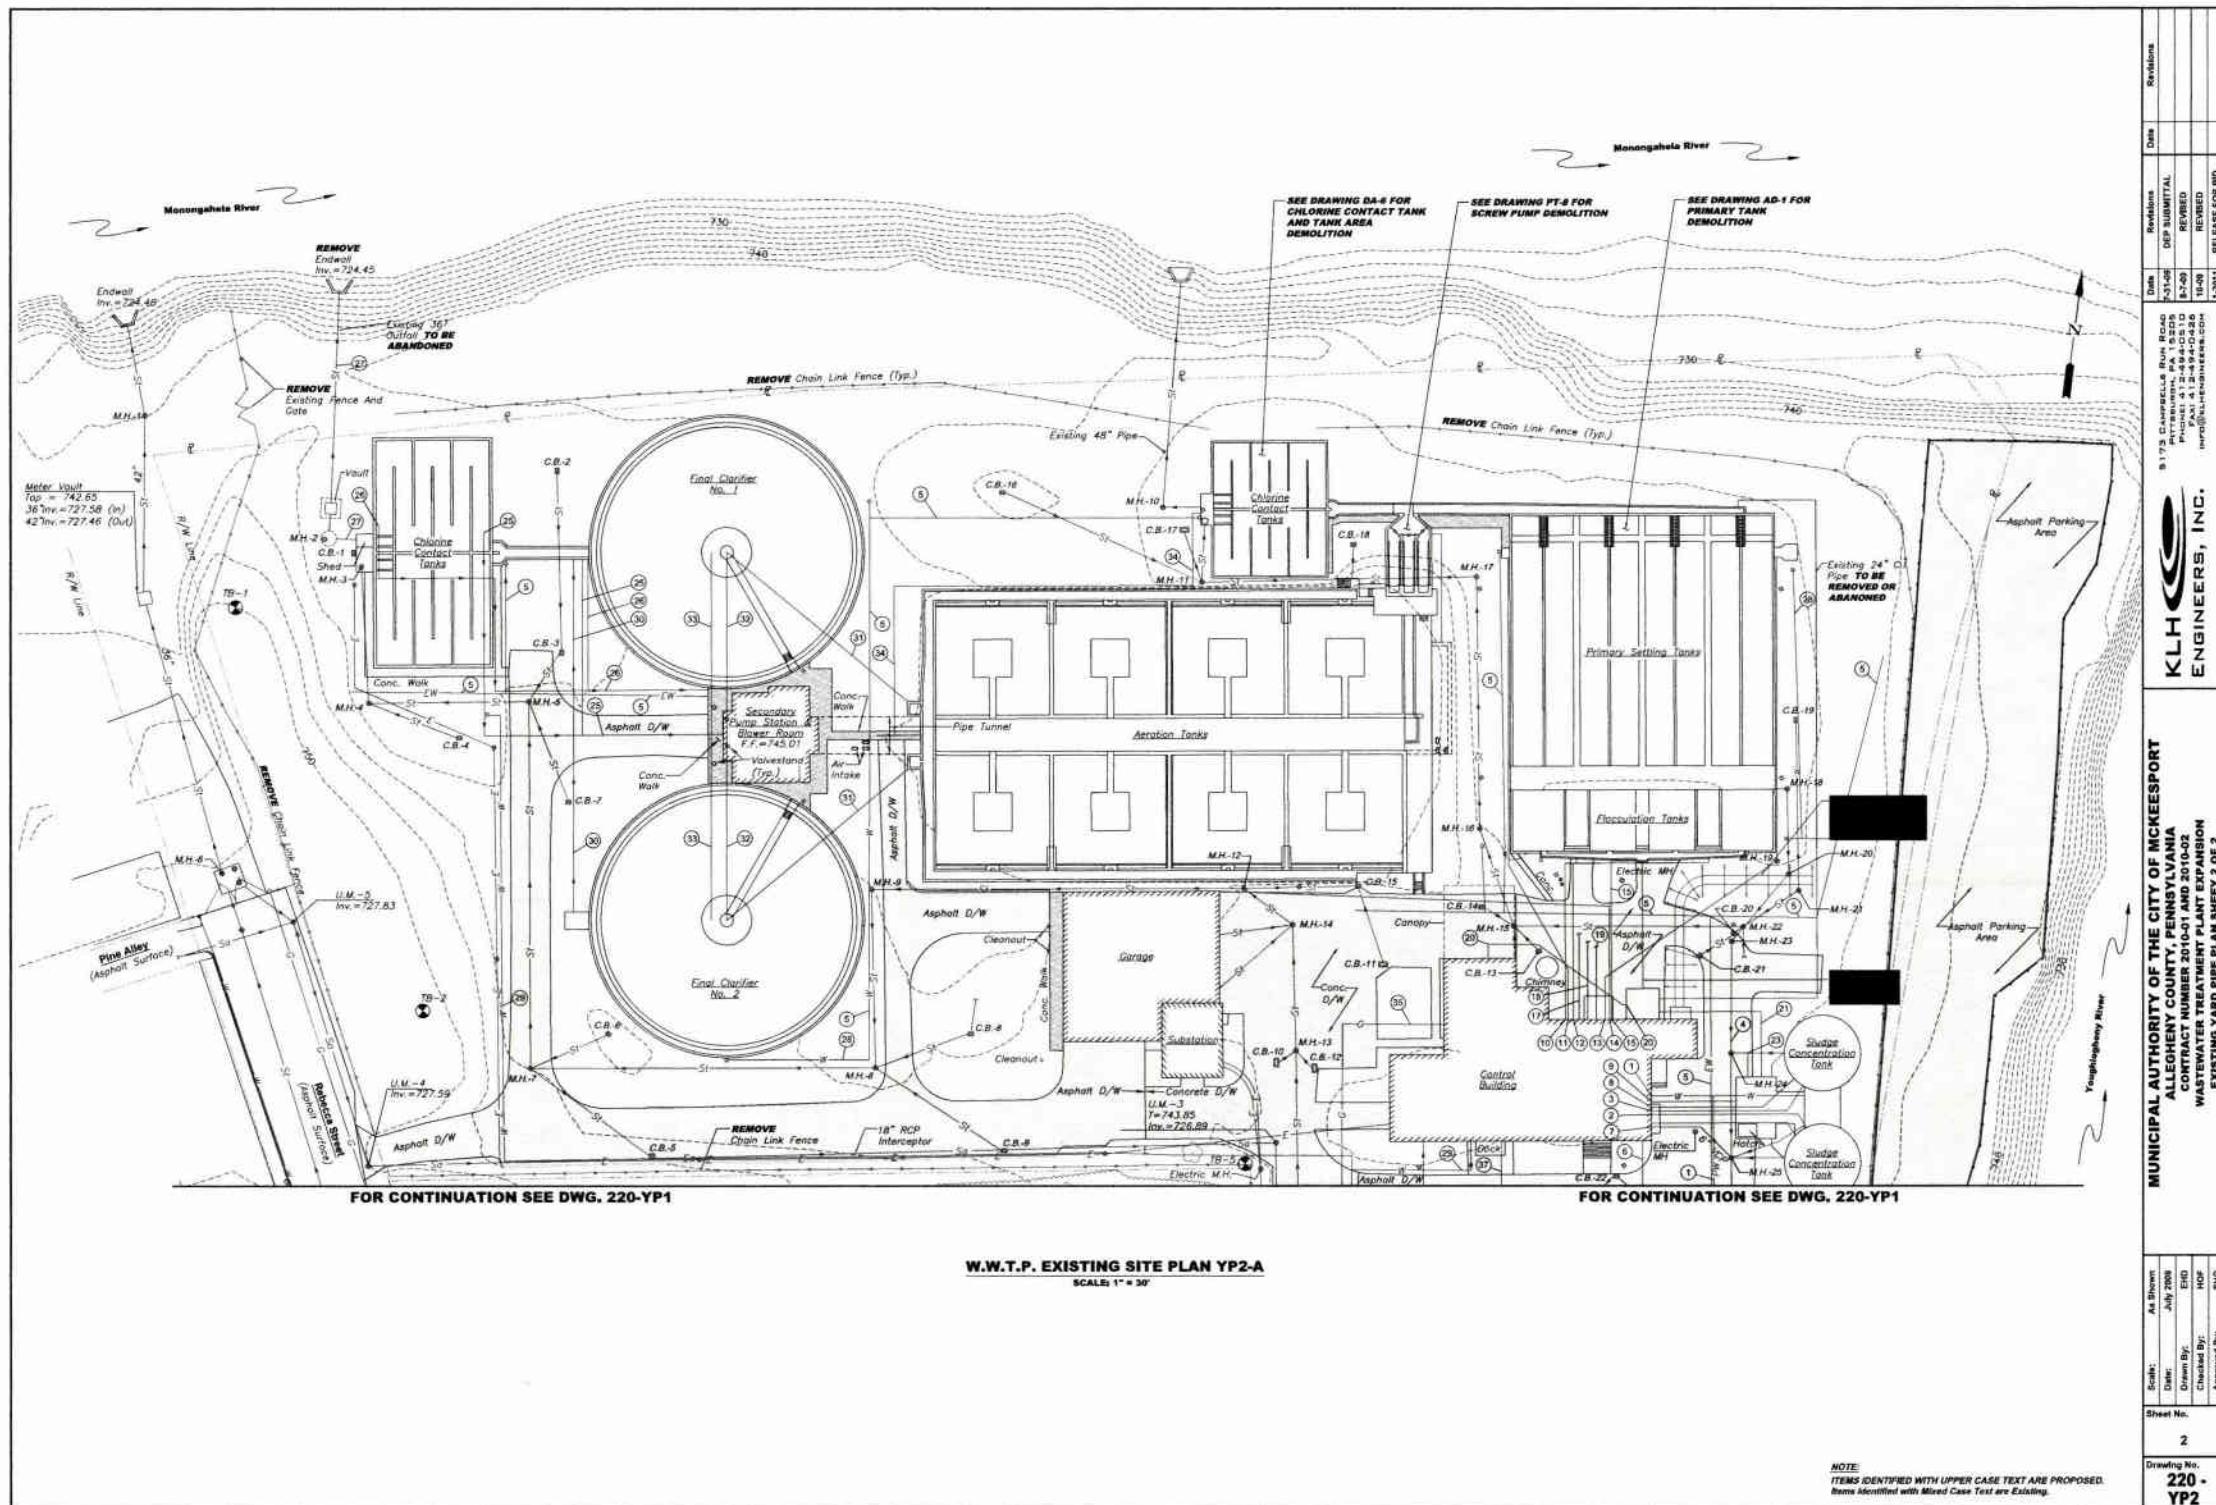

**FOR PLAN CONTINUATION SEE WWTP YARD PIPING PLAN
DRAWING 220-YP6**

**FOR PLAN CONTINUATION SEE WWTP YARD PIPING PLAN
DRAWING 220-YPA**

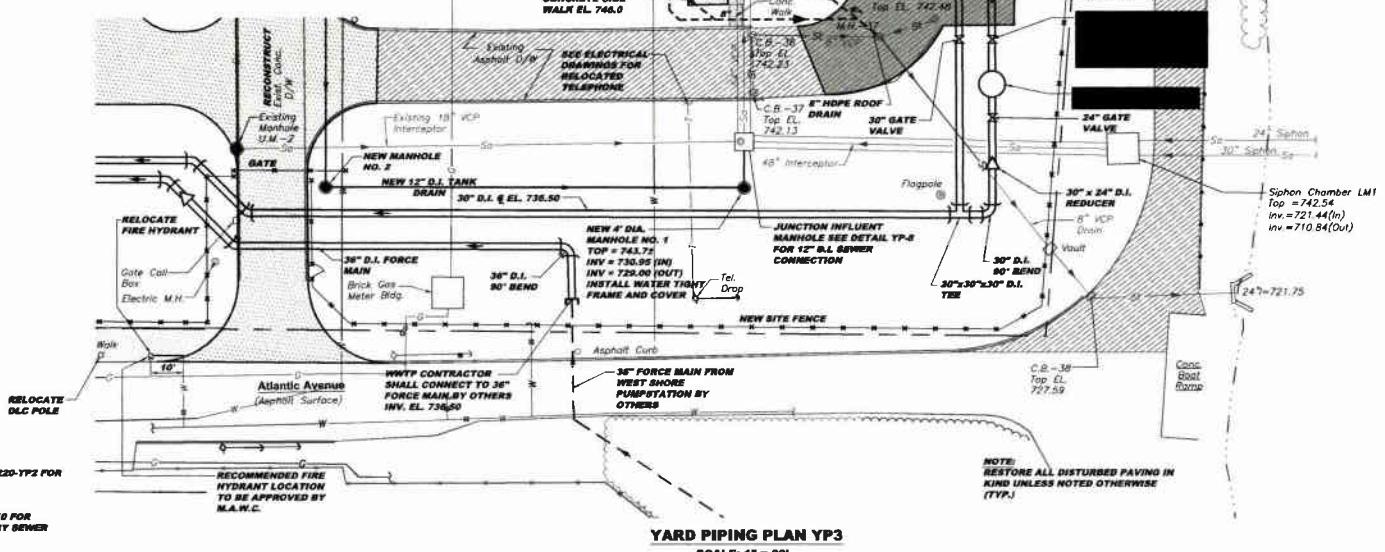

**SEE DRAWING 220-YP1 AND 220-YP2 FOR
EXISTING PIPING SIZES AND
IDENTIFICATION**

**SEE DRAWING YP-9 AND YP-10 FOR
STORM SEWER AND SANITARY SEWER
PROFILES**


RD PIPING PLAN YP3

ANGLE 1° = 20'

DRAWING IDENTIFICATION KEY

PROPOSED SANITARY GRAVITY SEWER	
PROPOSED SANITARY FORCEMAIN SEWER	
EXISTING SANITARY SEWER	
EXISTING STORM SEWER	
PROPOSED STORM SEWER	
EXISTING WATERLINE	
EXISTING WATER HYDRANT	
EXISTING WATER VALVE	
EXISTING GASLINE	
LIMITS OF WATER	
PROPOSED CHAIN LINK FENCE	
EXISTING FENCE	
EXISTING QUADRILATERAL	
TREE	
TREELINE	
EXISTING MANHOLE	
PROPOSED MANHOLE	
EXISTING CATCH BASIN	
EXISTING ASPHALT PAVING	
EXISTING CONCRETE / CONCRETE WALK	
PROPOSED ASPHALT PAVING	
PROPOSED CONCRETE PAVING	
PROPOSED STONE DRIVEWAY	
PROPOSED STRUCTURE	
EXISTING POLE	
EXISTING LIGHT	


MUNICIPAL AUTHORITY OF THE CITY OF MCKEEESPORT
ALLENTOWN COUNTY, PENNSYLVANIA
CONTRACT NUMBER 2010-01 AND 2010-02
WASTEWATER TREATMENT PLANT EXPANSION
PROPOSED YARD PIPING PLAN SHEET 1 OF 4

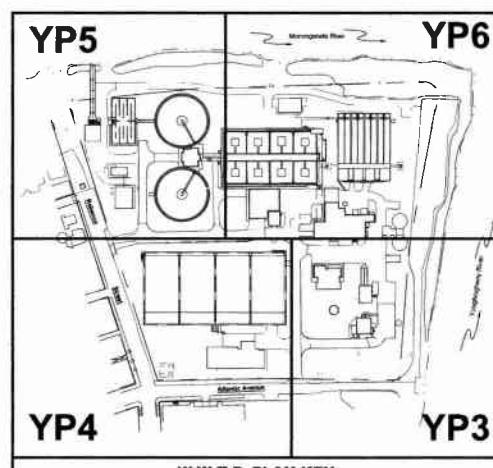

W.W.T.P. PLAN KEY

NOTE:
ITEMS IDENTIFIED WITH UPPER CASE TEXT ARE PROPOSED.
Items identified with Mixed Case Text are Existing.

MUNICIPAL AUTHORITY OF THE CITY OF MCKEELESSPORT	
ALLENTOWN, PENNSYLVANIA	
CONTRACT NUMBER 201C01 AND 201D02	
WASTEWATER TREATMENT PLANT EXPANSION	
PROPOSED YARD PIPING PLAN SHEET 1 OF 4	
State:	1" = 20'
Date:	July 2008
Drawn By:	DRG
Cheated By:	HOF
Approved By:	BHD
Sheet No.:	4
Drawing No.	220 - VP3

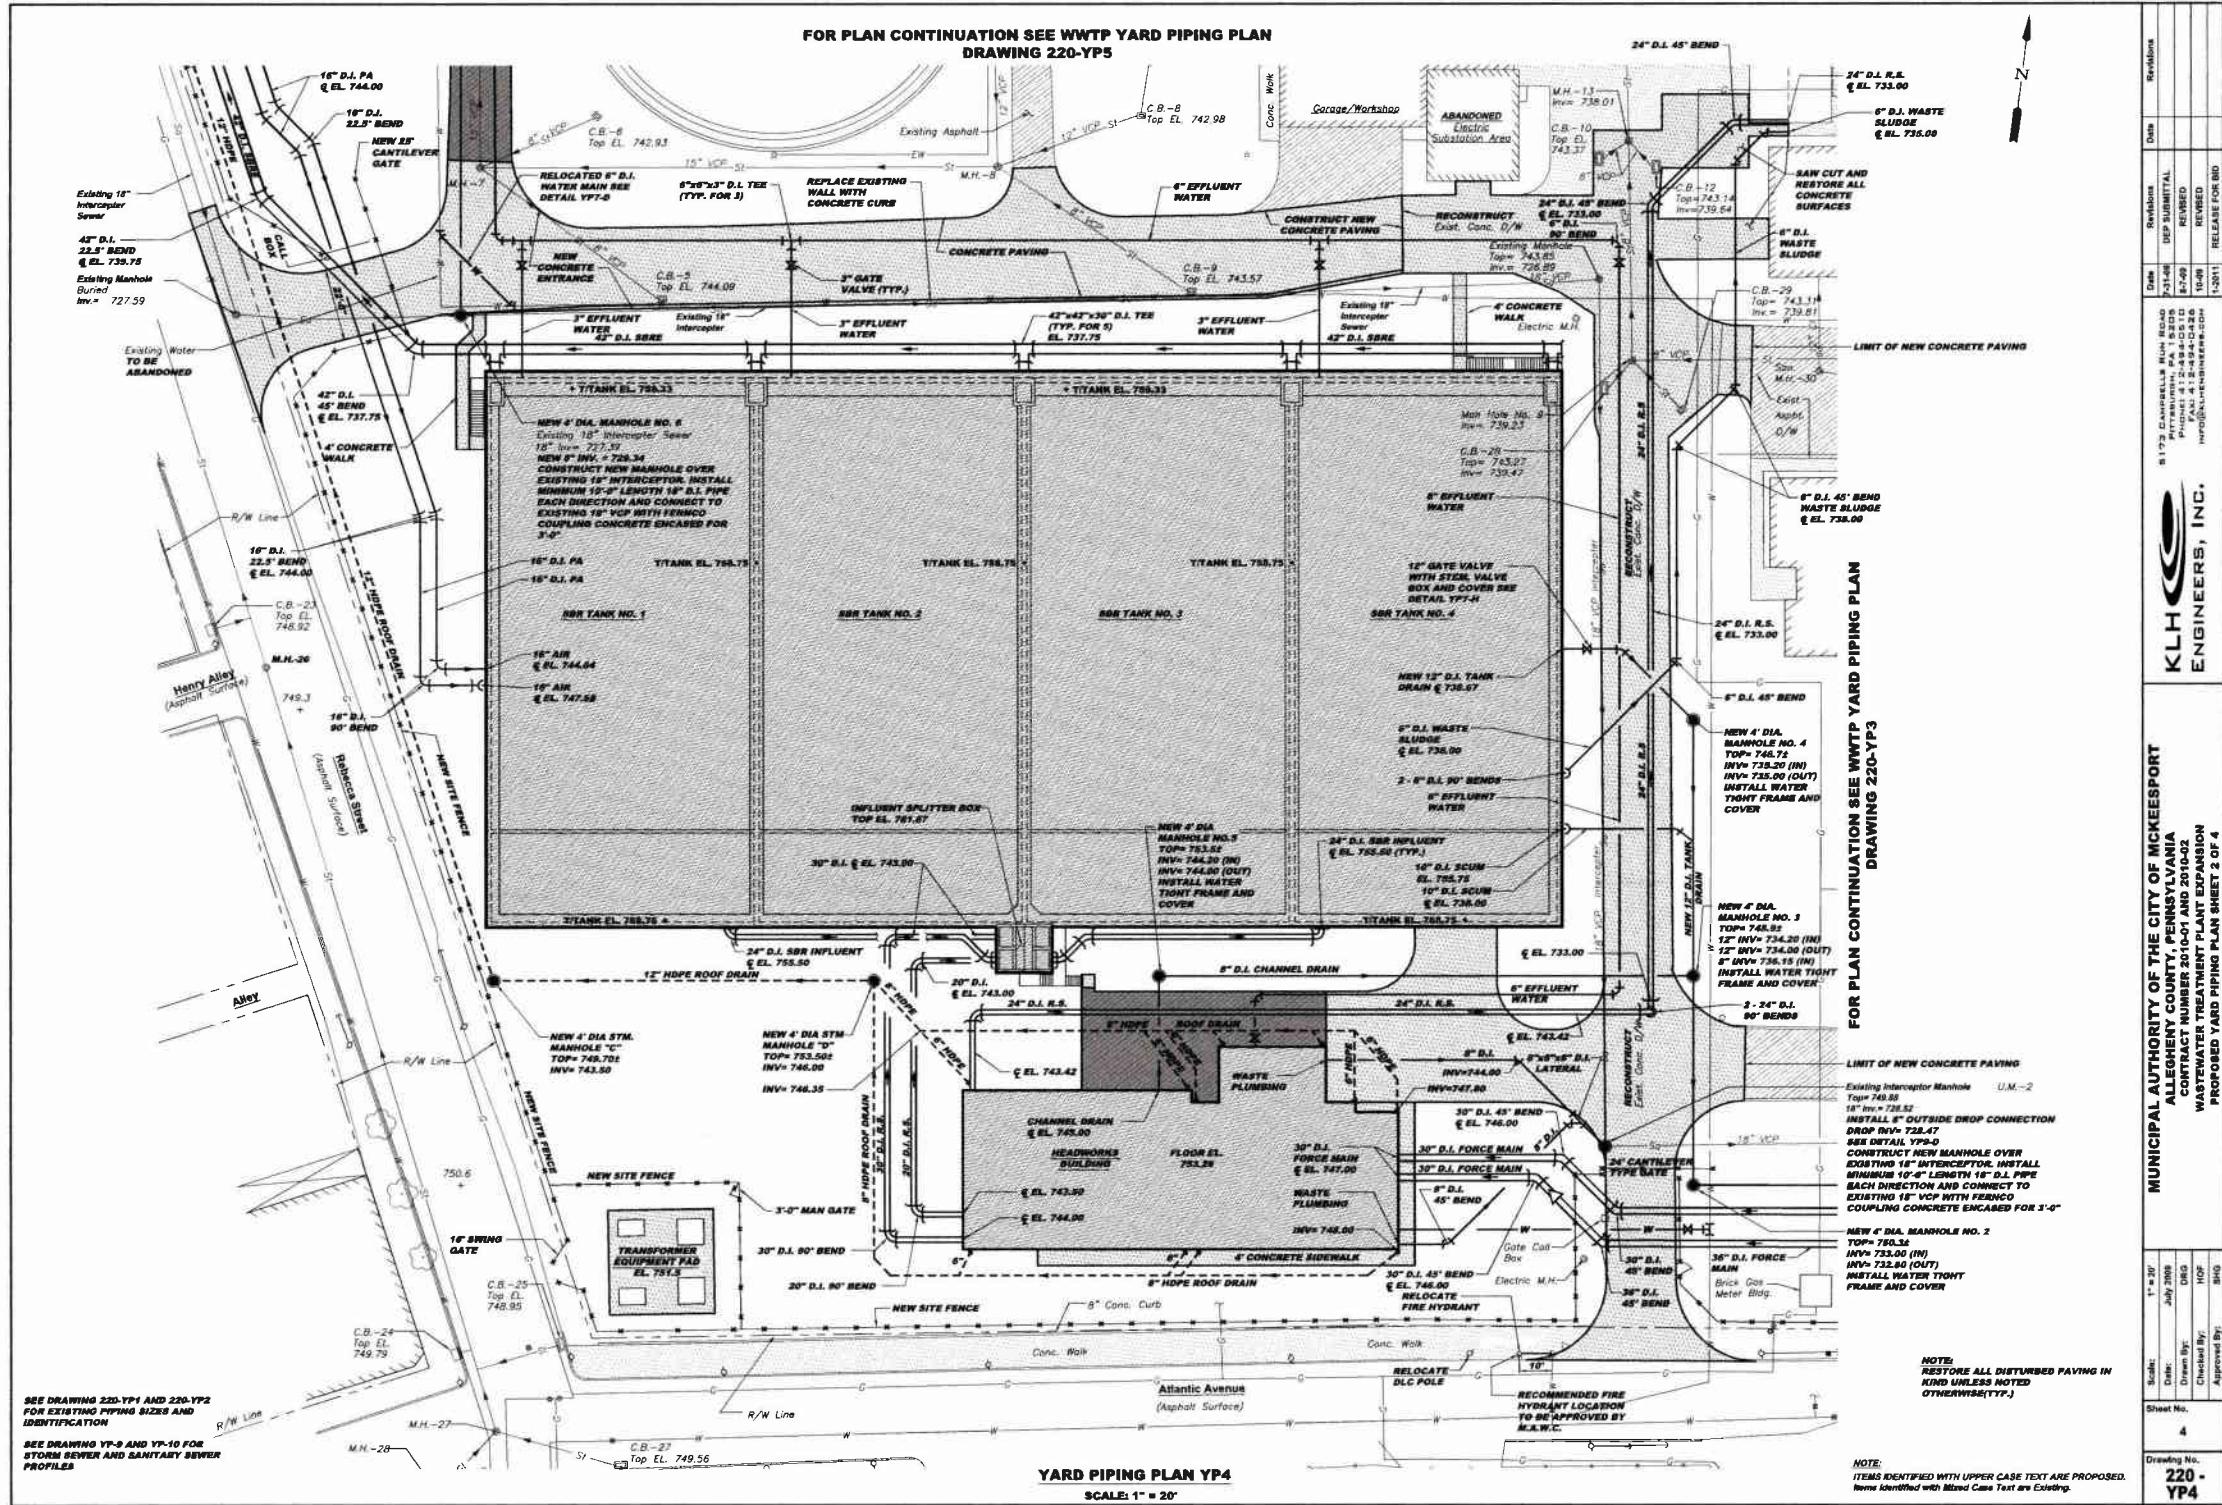


Existing Manholes				
M.H. No.	Top El.	Inv. El. (In)	Inv. El. (Out)	Inv. El. (In / Out)
M.H.-1	742.23	726.16	725.72	
M.H.-2	742.34	729.29 (36")	729.00 (36")	
M.H.-3	743.47			
M.H.-4 BURIED				
M.H.-5	743.84			733.60
M.H.-6	750.00			735.65
M.H.-7	746.23			734.32
M.H.-8	742.58			734.87
M.H.-9	743.04			735.87
M.H.-10	740.72			
M.H.-11	740.90	735.82(6")		729.64
M.H.-12	743.71			735.85
M.H.-13	743.35			736.01
M.H.-14	743.89	737.99(6") (West) 734.69(6") (South West)		736.66(6")
M.H.-15	743.30	740.25(6") (North West) 739.56(4") (South East)		
		737.81(6") (South)	736.88(12")	
		736.50(6")		
M.H.-16	741.84			734.53
M.H.-17	740.26			732.34
M.H.-18	741.16			725.11
M.H.-19	741.07			731.83
M.H.-20	743.04			724.74
M.H.-21	742.87			737.72
M.H.-22	743.10	739.80 (South West) 738.27 (South)		
		737.54 (North East)	737.54	
M.H.-23	742.70	724.62		724.45
M.H.-24	743.11	740.32(16") (East)		724.31
M.H.-25	743.08	729.54(6") (North West) 728.36(6") (North East)		724.11
		724.26(16") (East)		
M.H.-26	746.80			738.64
M.H.-27	780.01	741.88 (12")		741.89(15")
M.H.-28	748.93	745.70 (South East)	740.83	
M.H.-29	743.51	738.23		
M.H.-30	743.50			718.41
M.H.-31	743.11	738.06 (8")		717.88 (12")
M.H.-32	743.10			739.84
M.H.-33	743.30	738.52 (East)		723.86
		739.41 (West)		
		738.13 (North West)		
		738.76 (Front D.S.)		
M.H.-34	743.51	723.09		722.86
M.H.-35	743.13	738.38 (4")		715.42
M.H.-36	743.84	723.77		723.59
M.H.-37	743.26	737.19 (East)	736.82	
		737.07 (West)		

PROPOSED PIPE LINES	
PIPE CONTENTS	DESIGNATION
SBR EFFLUENT	<i>BBE</i>
RAW SEWAGE	<i>RS</i>
SANITARY SEWAGE	<i>SA</i>
PROCESS AIR	<i>PA</i>
POTABLE WATER	<i>W</i>
EFFLUENT WATER	<i>EW</i>
STORM SEWER	<i>SM</i>

**SEE DRAWING 220-YP1 AND 220-YP2 FOR
EXISTING PIPING SIZES AND
IDENTIFICATION**

**SEE DRAWING YP-9 AND YP-10 FOR
STORM SEWER AND SANITARY SEWER
PROFILES**

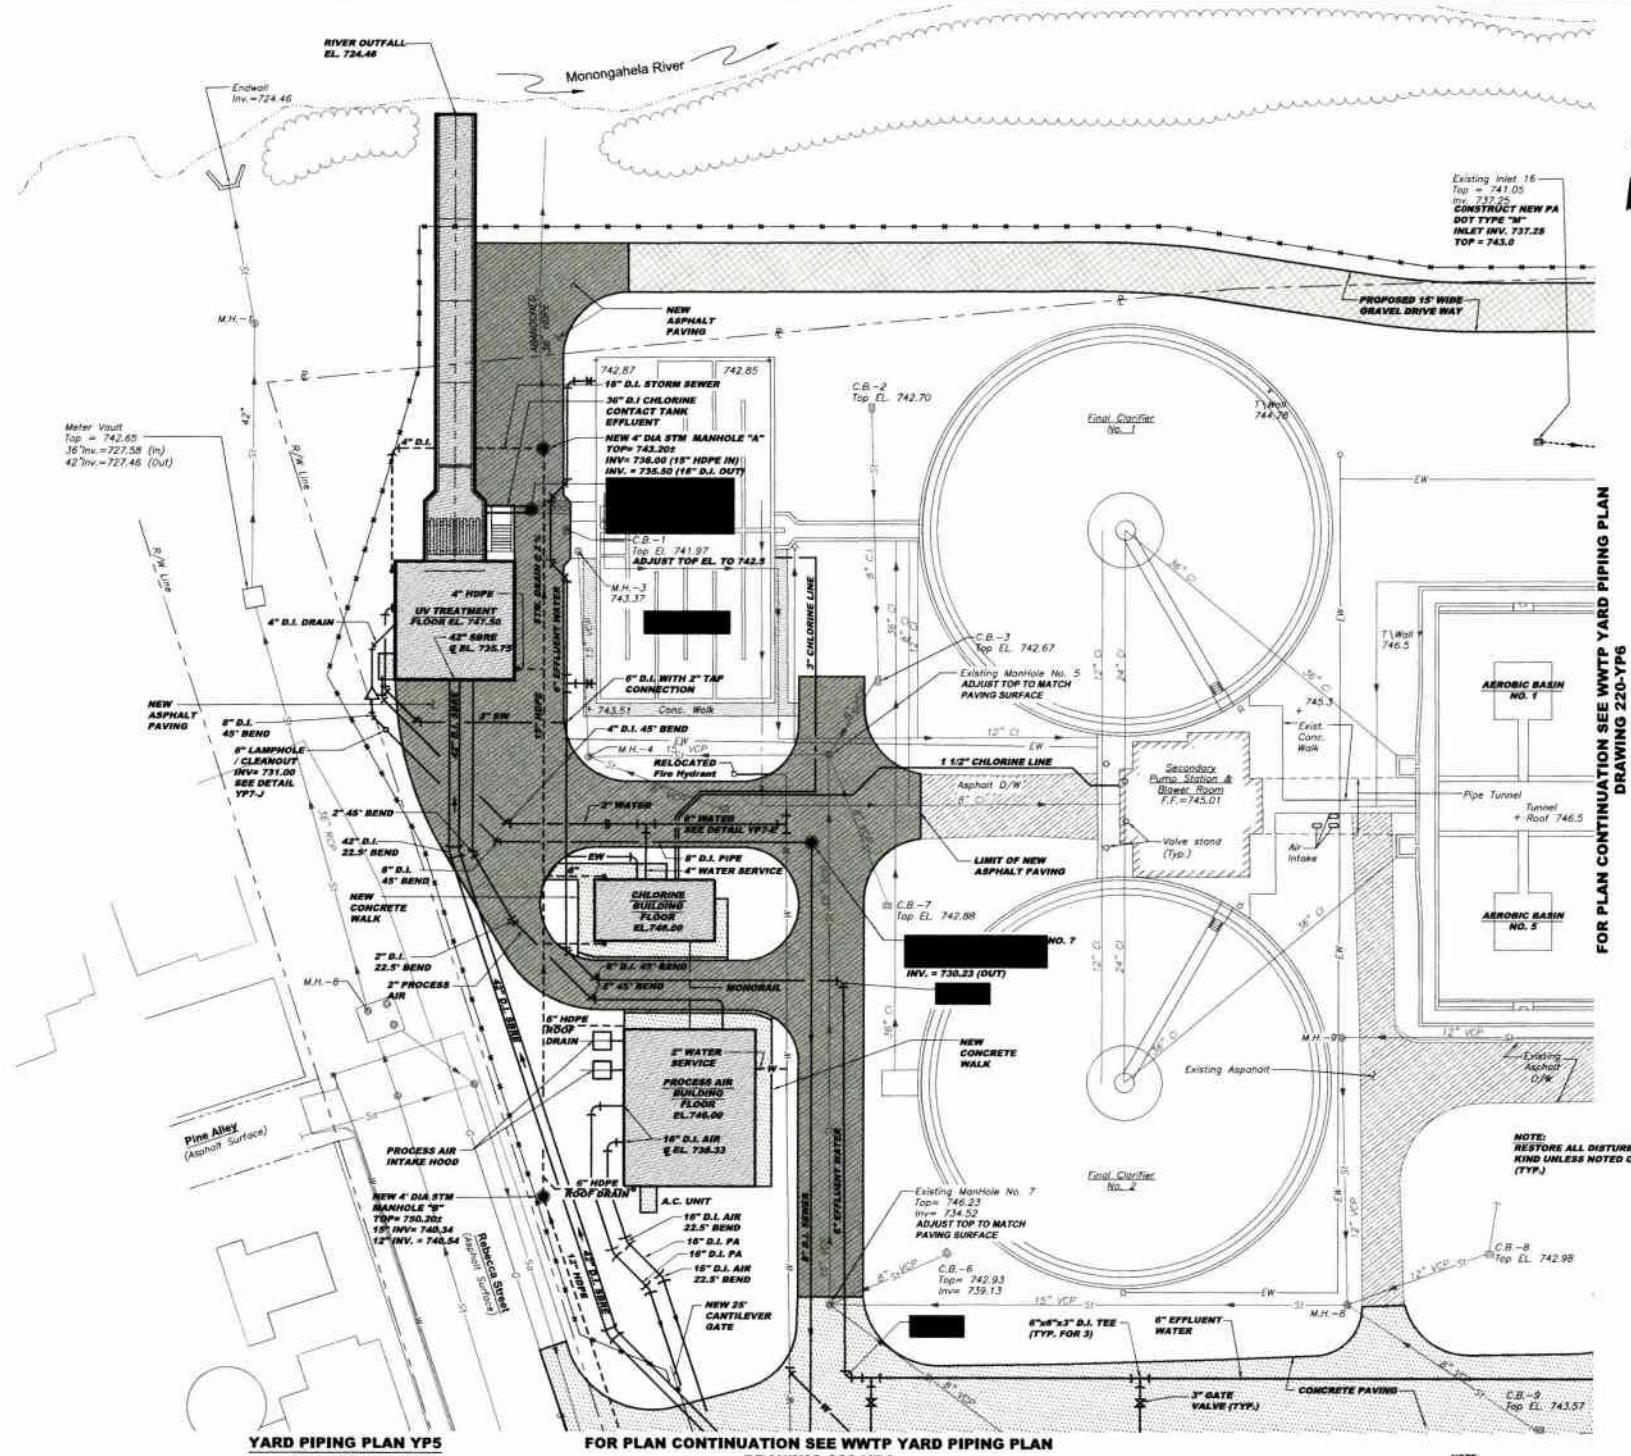

SCALE E: 1" = 30'

SCALE: 1" = 20'


**FOR PLAN CONTINUATION SEE WWTP YARD PIPING PLAN
DRAWING 220-YP4**


NOTE: ITEMS IDENTIFIED WITH UPPER CASE TEXT ARE PROPOSED.
Items identified with Mixed Case Text are Existing.


**MUNICIPAL AUTHORITY OF THE CITY OF MCKEEESPORT
ALLENTY COUNTY, PENNSYLVANIA
CONTRACT NUMBER 2010-01 AND 2010-A2
WASTEWATER TREATMENT PLANT EXPANSION
PROPOSED YARD PIPING PLAN SHEET 3 OF 4**

KLH

KLH ENGINEERS, INC. • 1713 DANIELLE HOBSON ROAD • SUITE 2015 • FORT WORTH, TEXAS 76137-4015 • (817) 245-0425 • FAX: (817) 245-0426 • E-MAIL: info@klh.com • URL: <http://www.klh.com>

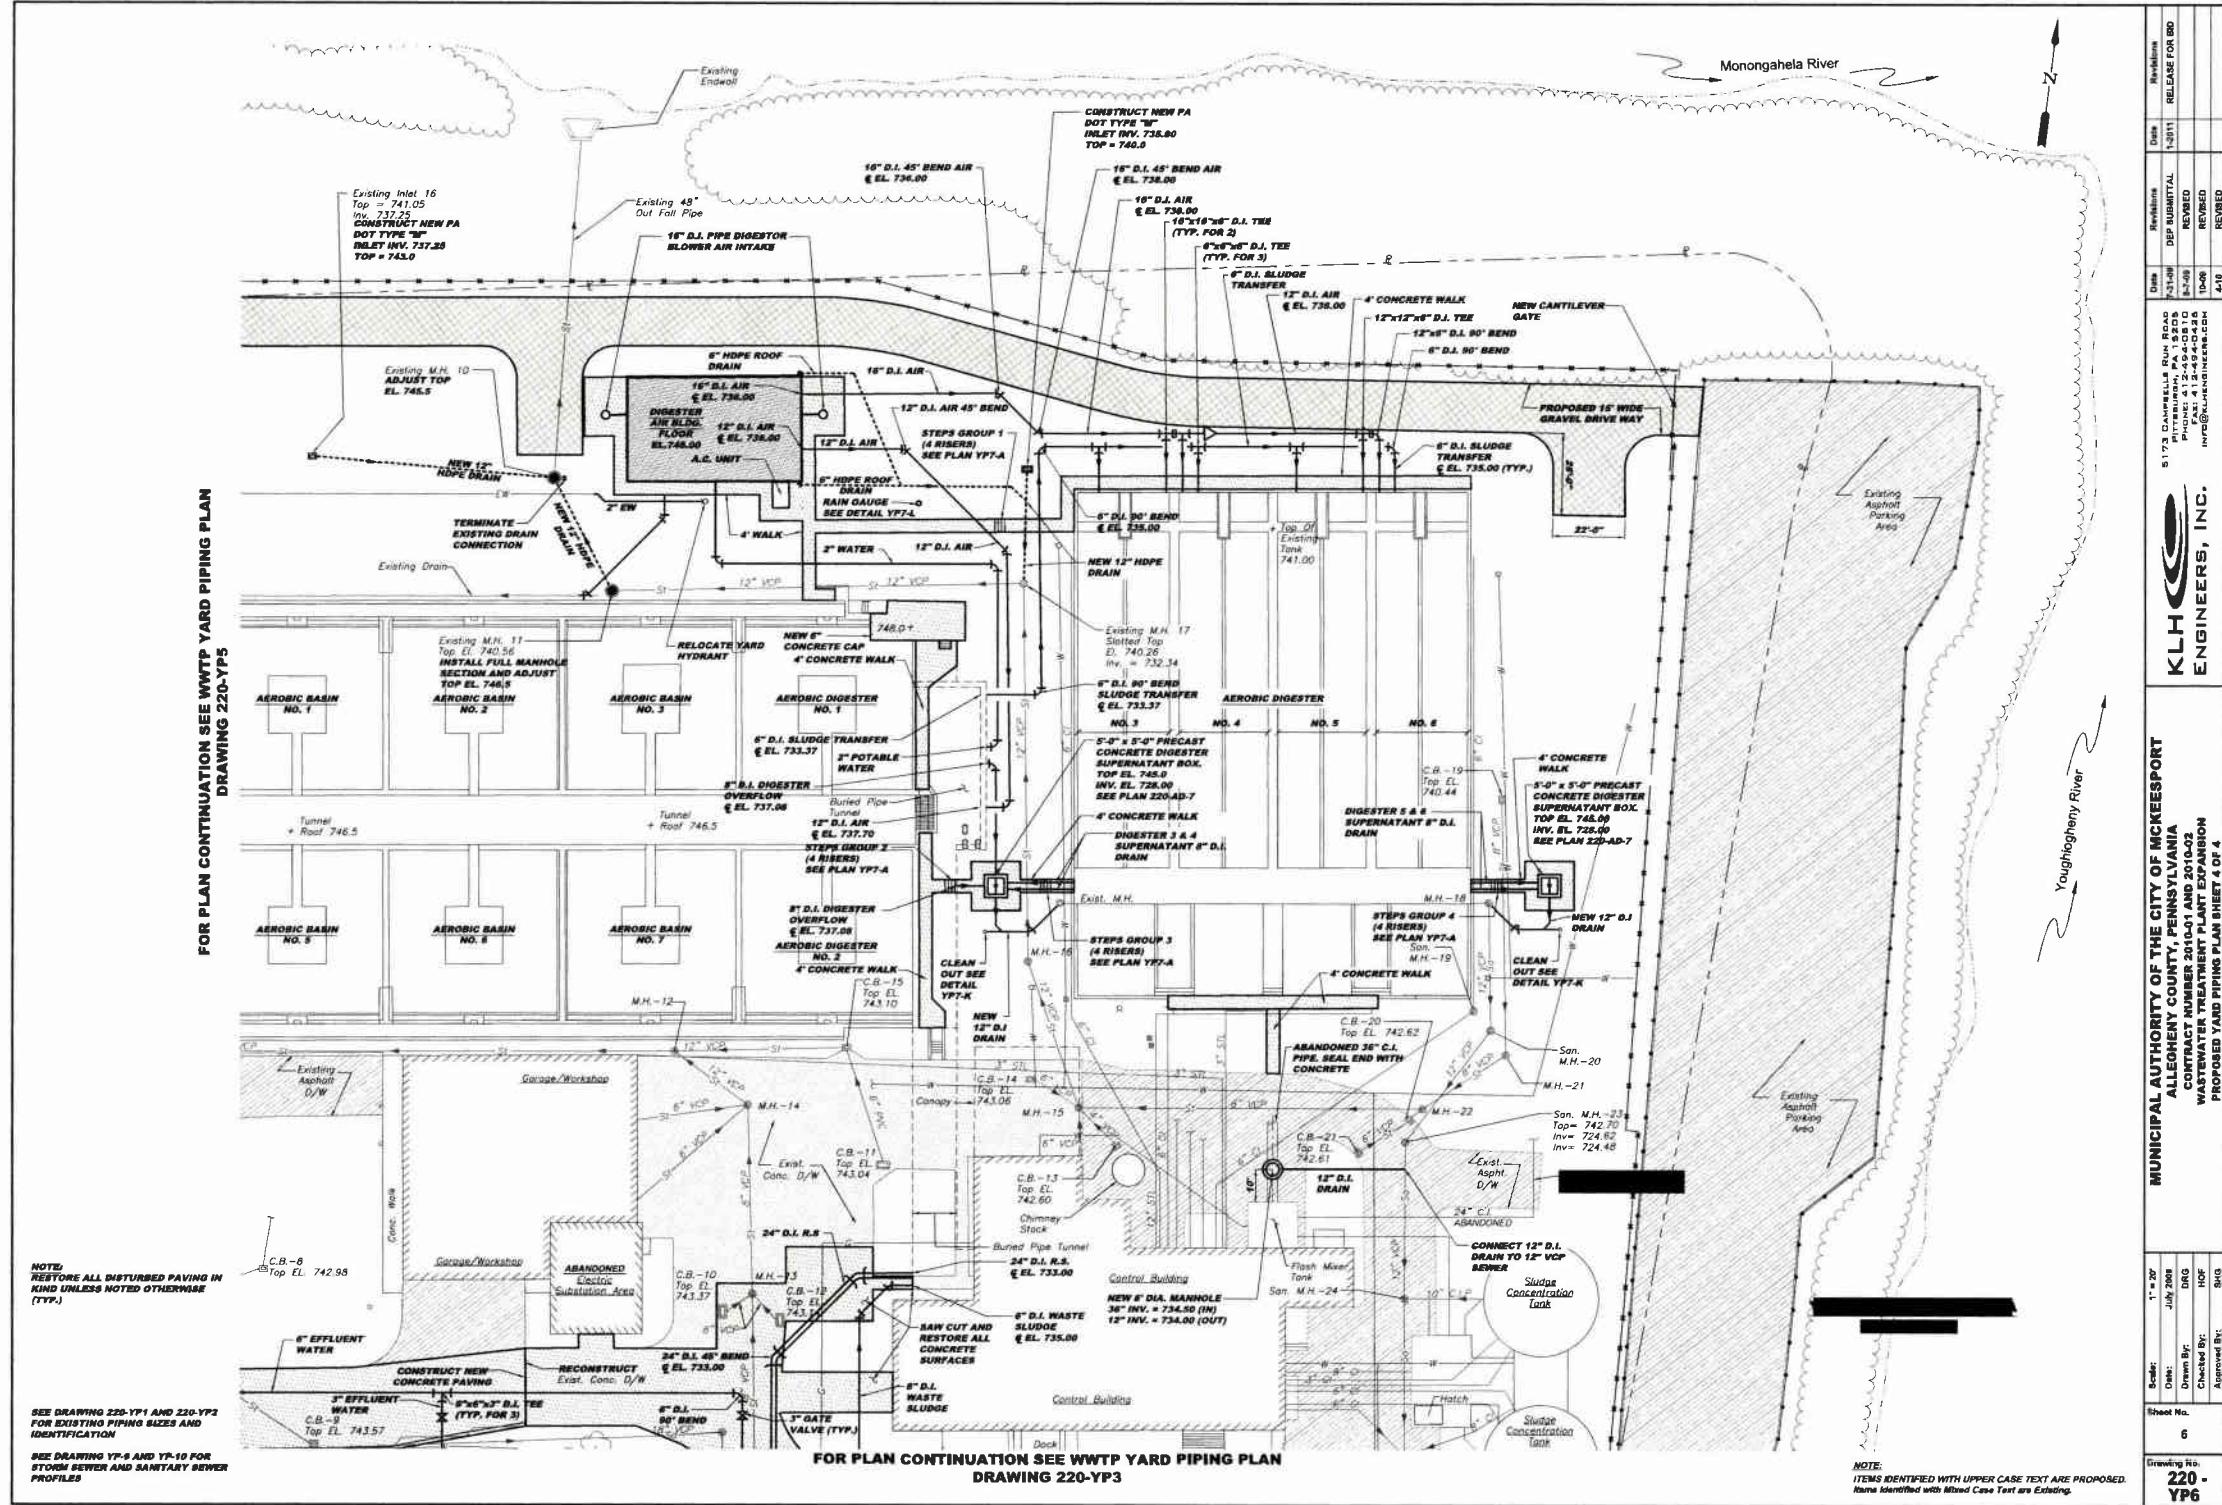


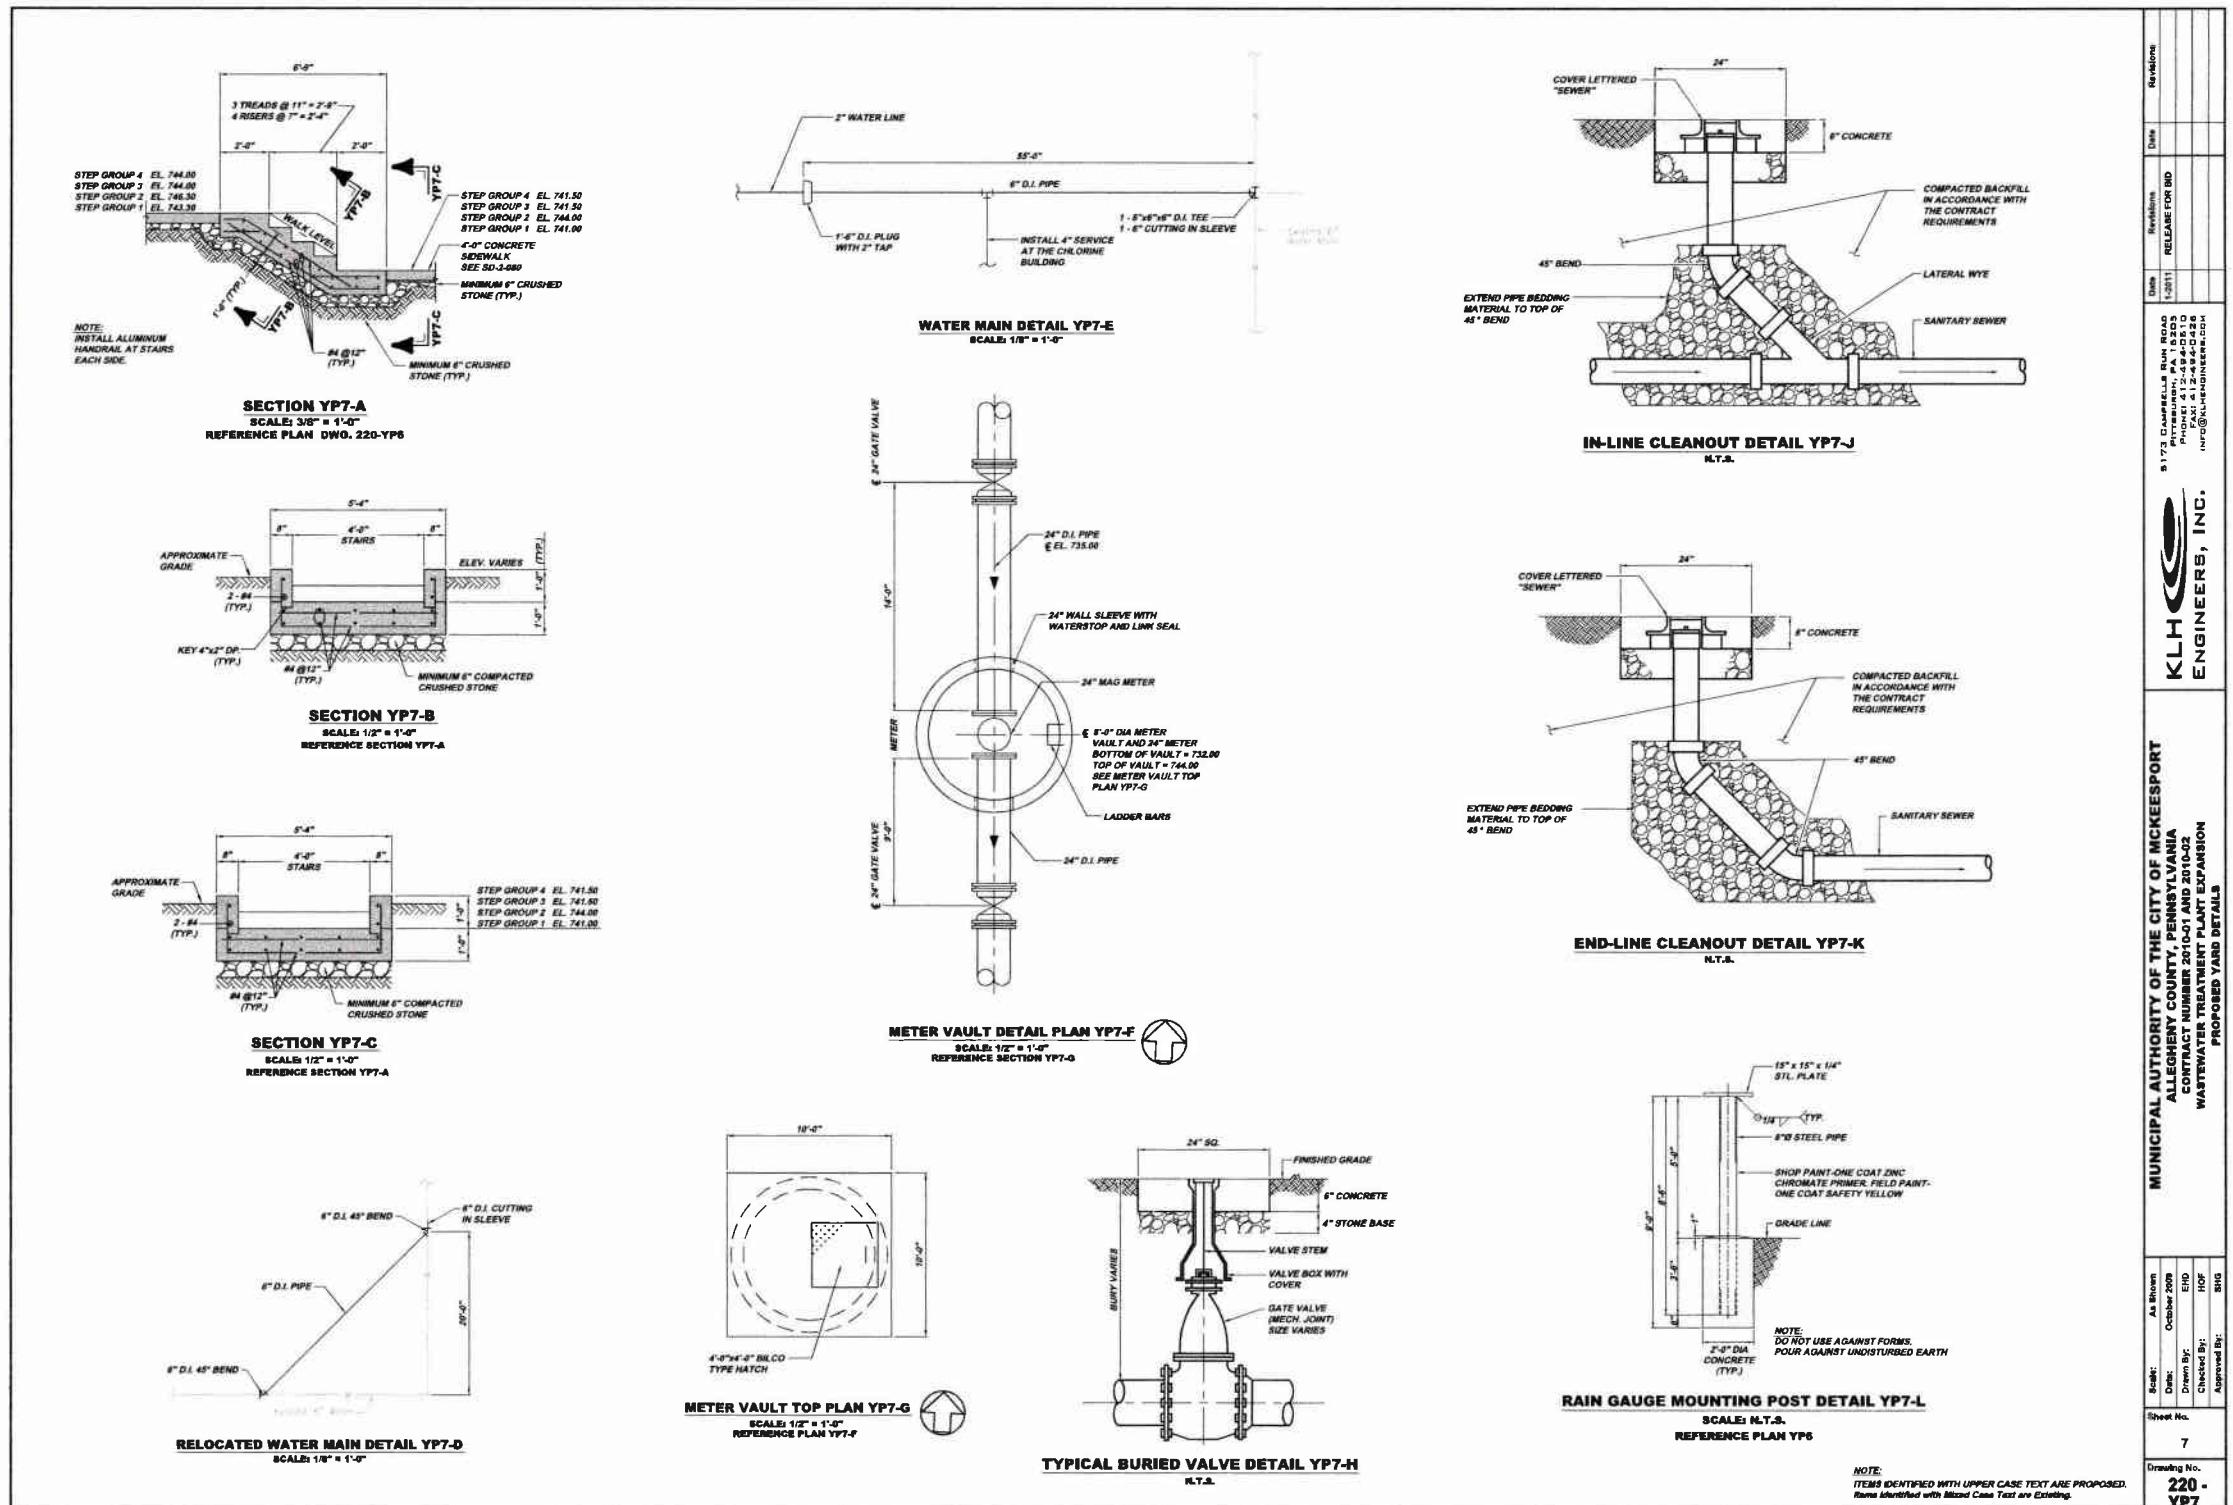

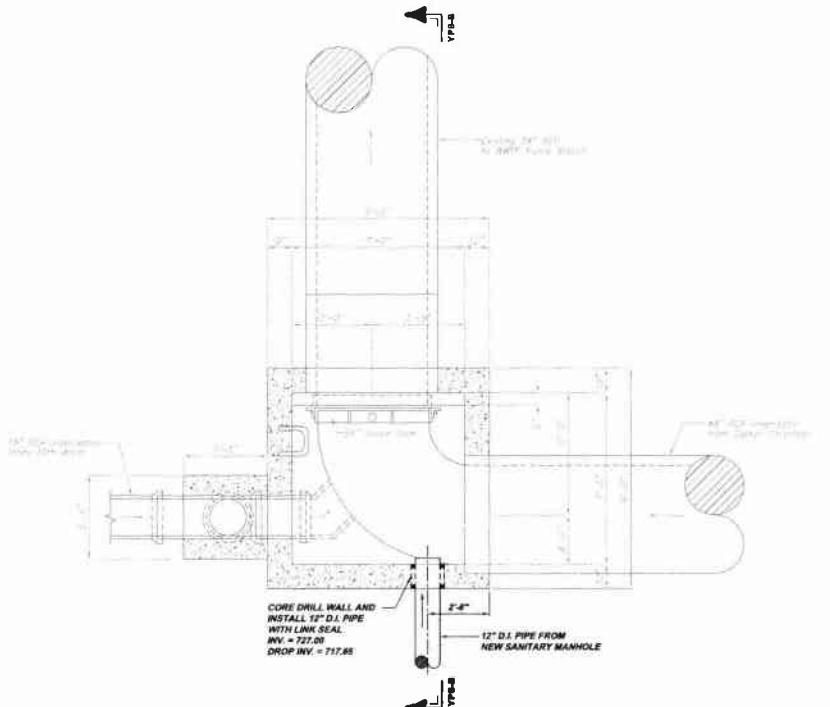


EXISTING WWTP / JUNCTION INFLUENT MANHOLE INVERT PLAN YPS-A

SCALE 30° =

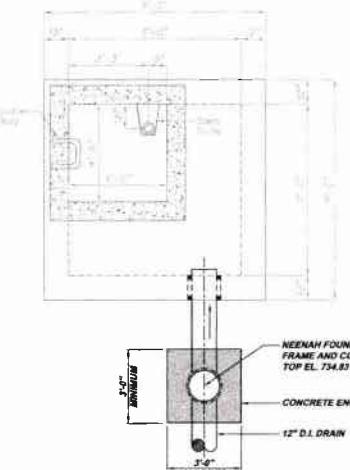


EXISTING WWTP JUNCTION INFLUENT MANHOLE TOP PLAN YP8-C

SCALE 3 FT = 1'-5"

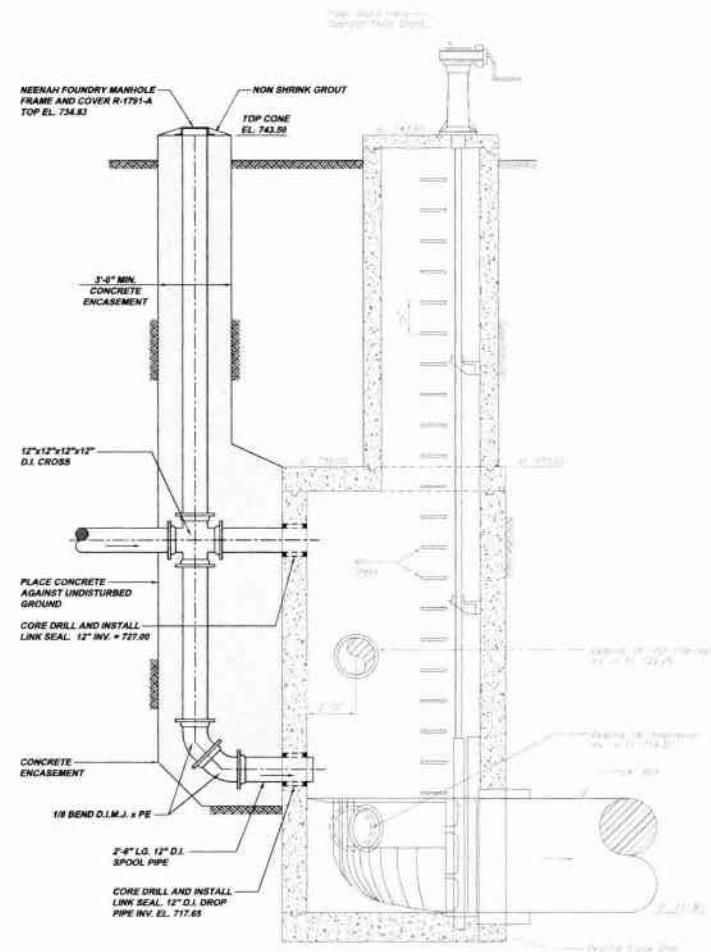

SECTION YPB-B


SCALE: 30' = 1'

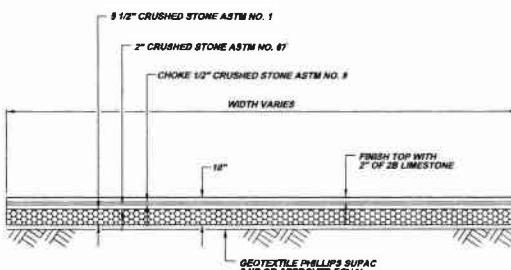


STONE DRIVEWAY DETAIL YP8-D

SCALE: N.T.S.
REFERENCE PLATE 54-1


Building No.	220 - VDR
Sheet No.	8
Drawn By:	As Brown
Date:	October 2006
Drawn By:	DJB
Clinical By:	HBF
Approved By:	8410
MUNICIPAL AUTHORITY OF THE CITY OF MCKEESPORT ALLENTOWN COUNTY, PENNSYLVANIA CONTRACT NUMBER 201-01 AND 2010-02 WASTEWATER TREATMENT PLANT EXPANSION PROPOSED YARD EXPANSION PROPOSED YARD EXPANSION	
 KLH ENGINEERS, INC.	
<i>5173 Chappelle Run Road Pittsburgh, PA 15241 Phone: 412-244-0110 Fax: 412-244-0255 info@klhengineers.com</i>	
<i>1-2011 RELEASE FOR BID</i>	

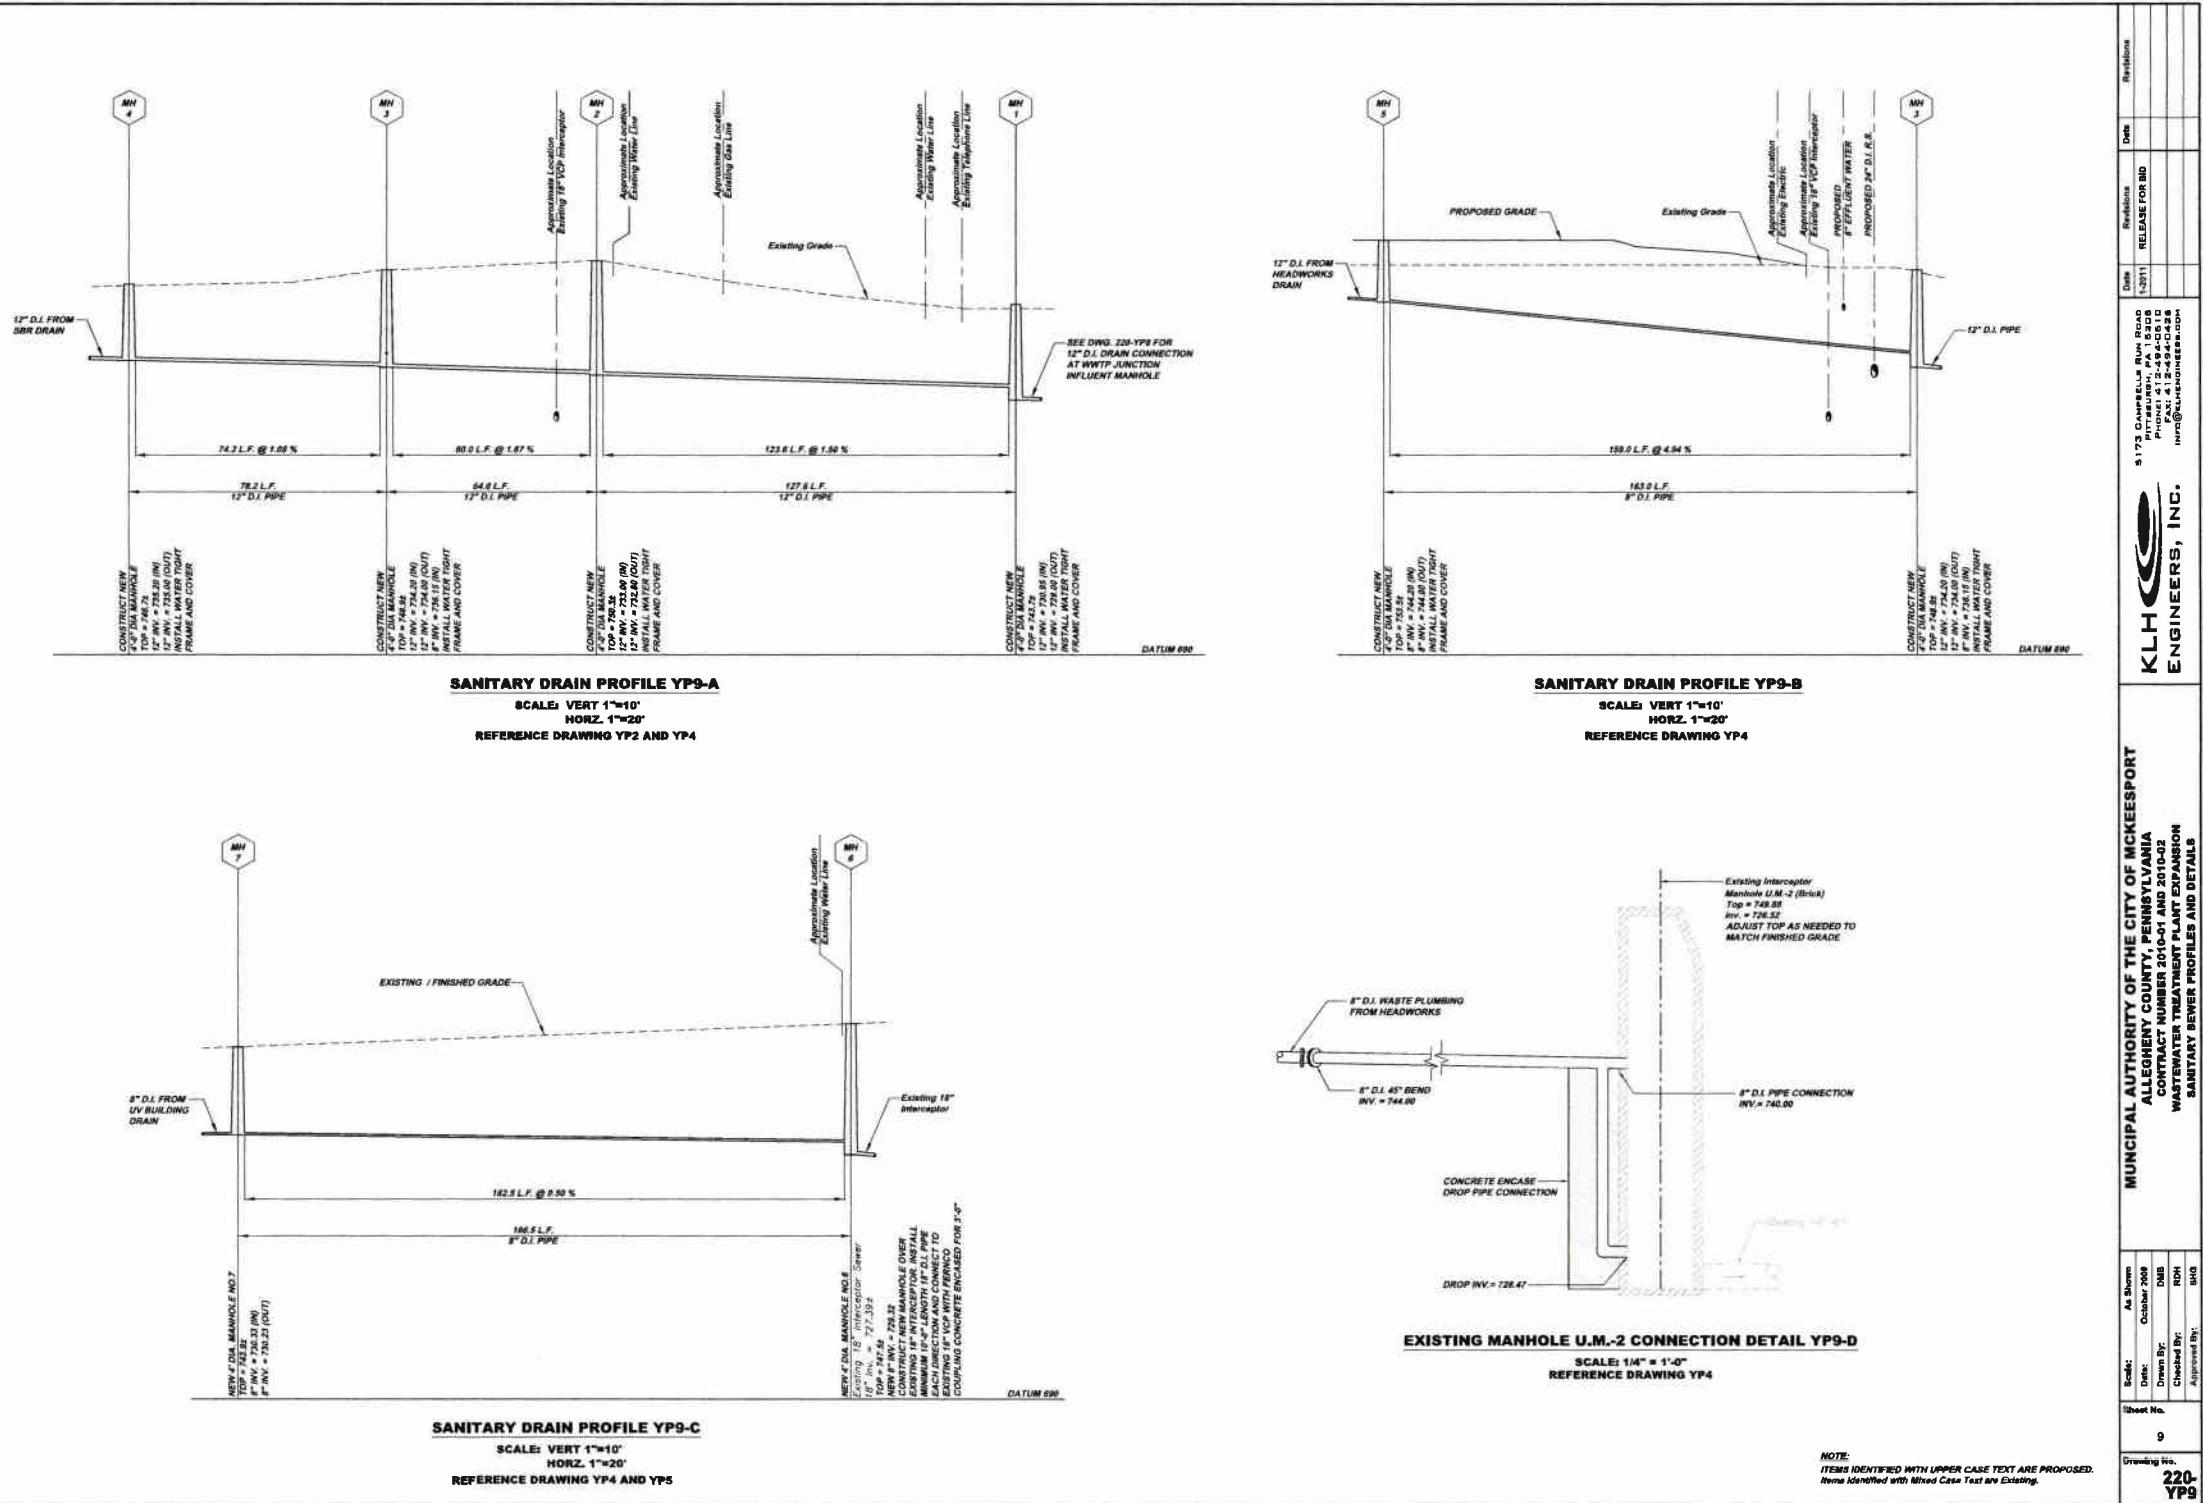

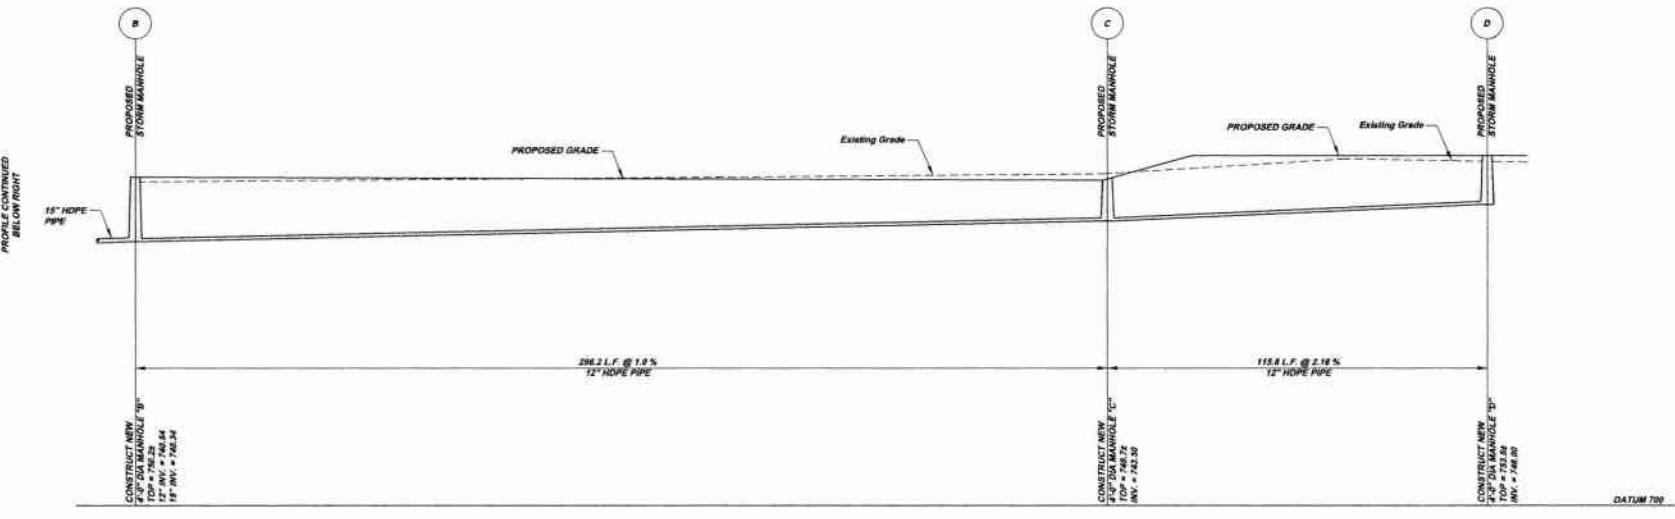


STORM SEWER PROFILE YP10-A

SCALE: VERT 1"=10'
HORZ. 1"=20'
REFERENCE DRAWING YP4 AND YP5

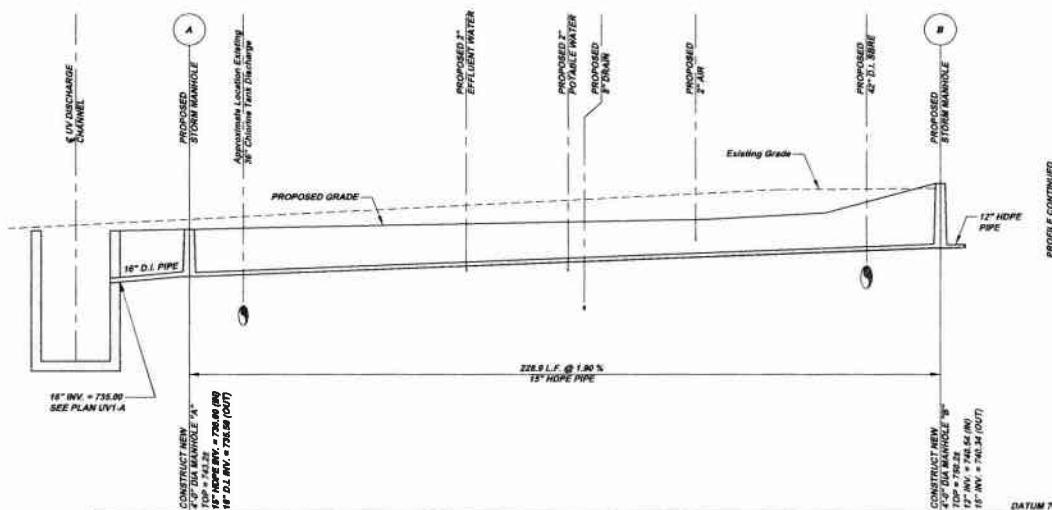

STORM SEWER PROFILE YP10-A CONTINUED


SCALE: VERT 1"=10'
HORZ. 1"=20'
REFERENCE DRAWING YPS

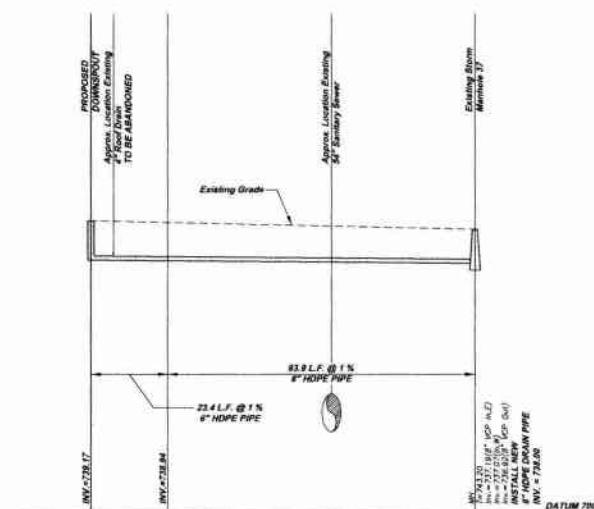


STORM SEWER PROFILE YP10-B

SCALE: VERT 1"-=10'
HORZ. 1"-=20'
REFERENCE DRAWING YP3 AND WP1

MUNICIPAL AUTHORITY OF THE CITY OF MCKEEESPORT ALLENTOWN COUNTY, PENNSYLVANIA		RELEASE FOR BID		Date	Revisions
Bidder:	As Shown	5173 CAMBRELLA RUN ROAD	1-2111		
Date:	October 2009	PIKEVILLE, OHIO 45660			
Driver No.:	DWB	PHONE: 1-234-944-1010			
Drive By:	RWH	FAX: 1-234-944-1010			
Charged By:		INFO: 1-234-944-1010			
Project No.:		KLH ENGINEERS, INC.			
Comments:					
MUNICIPAL AUTHORITY OF THE CITY OF MCKEEESPORT ALLENTOWN COUNTY, PENNSYLVANIA					
CONTRACT NUMBER: 201-C-01 AND 201-C-02					
WASTEWATER TREATMENT PLANT EXPANSION					
SEE DRAWINGS					

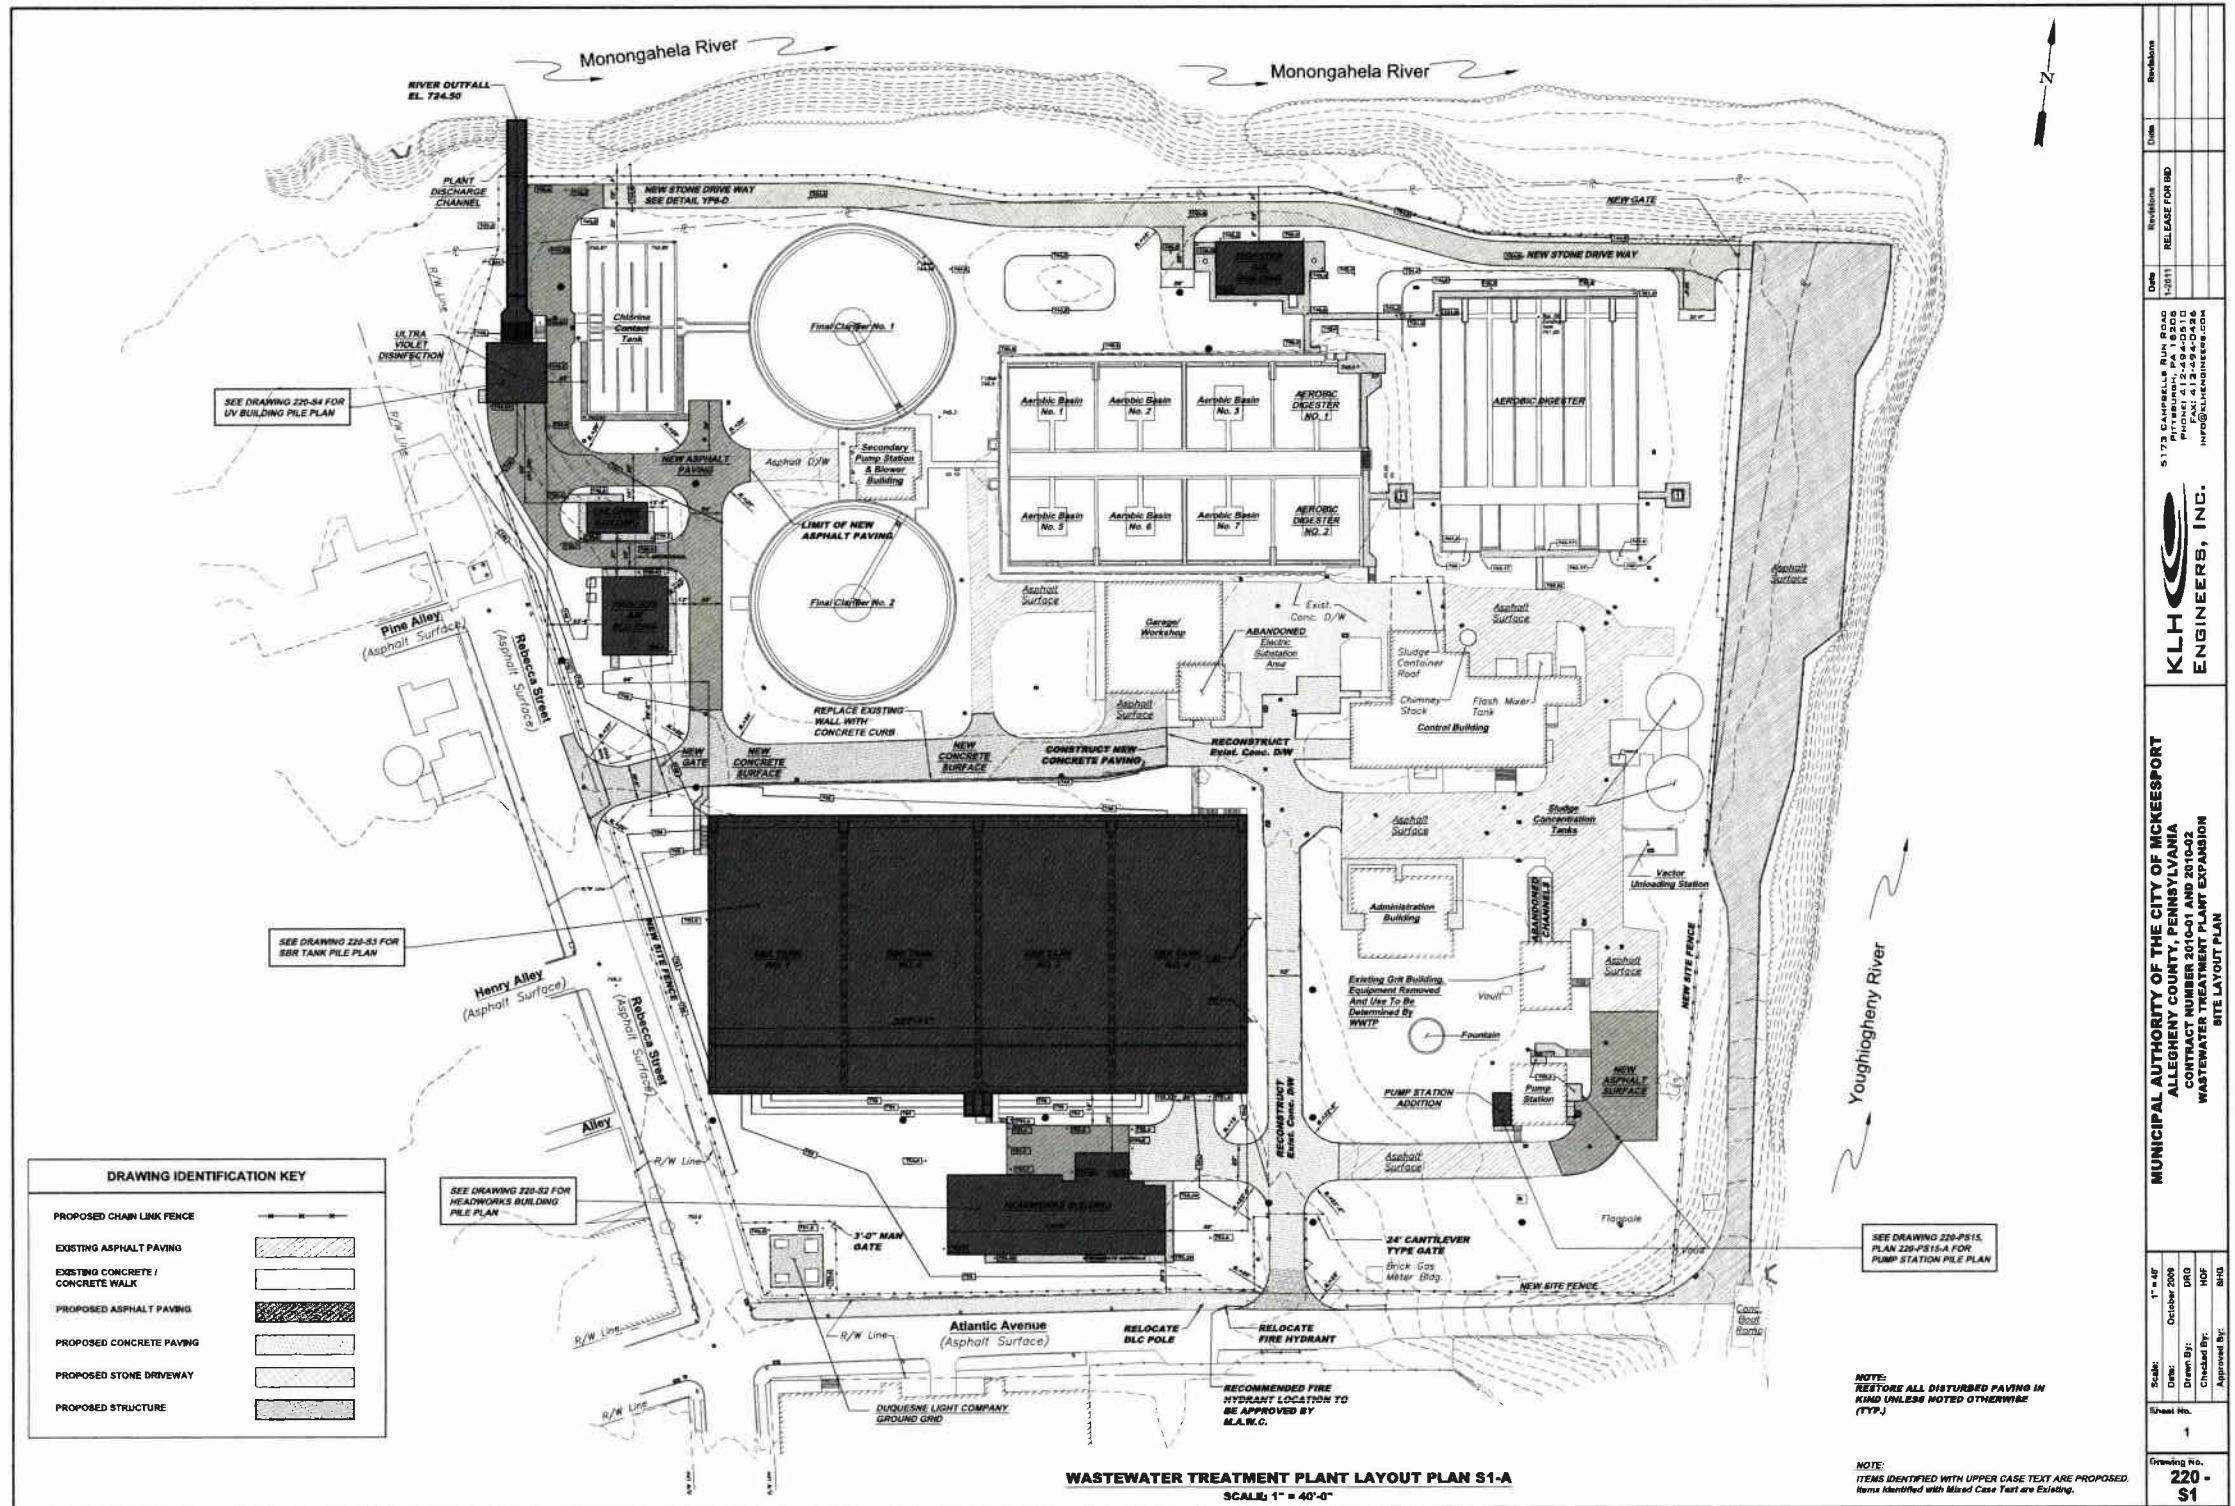

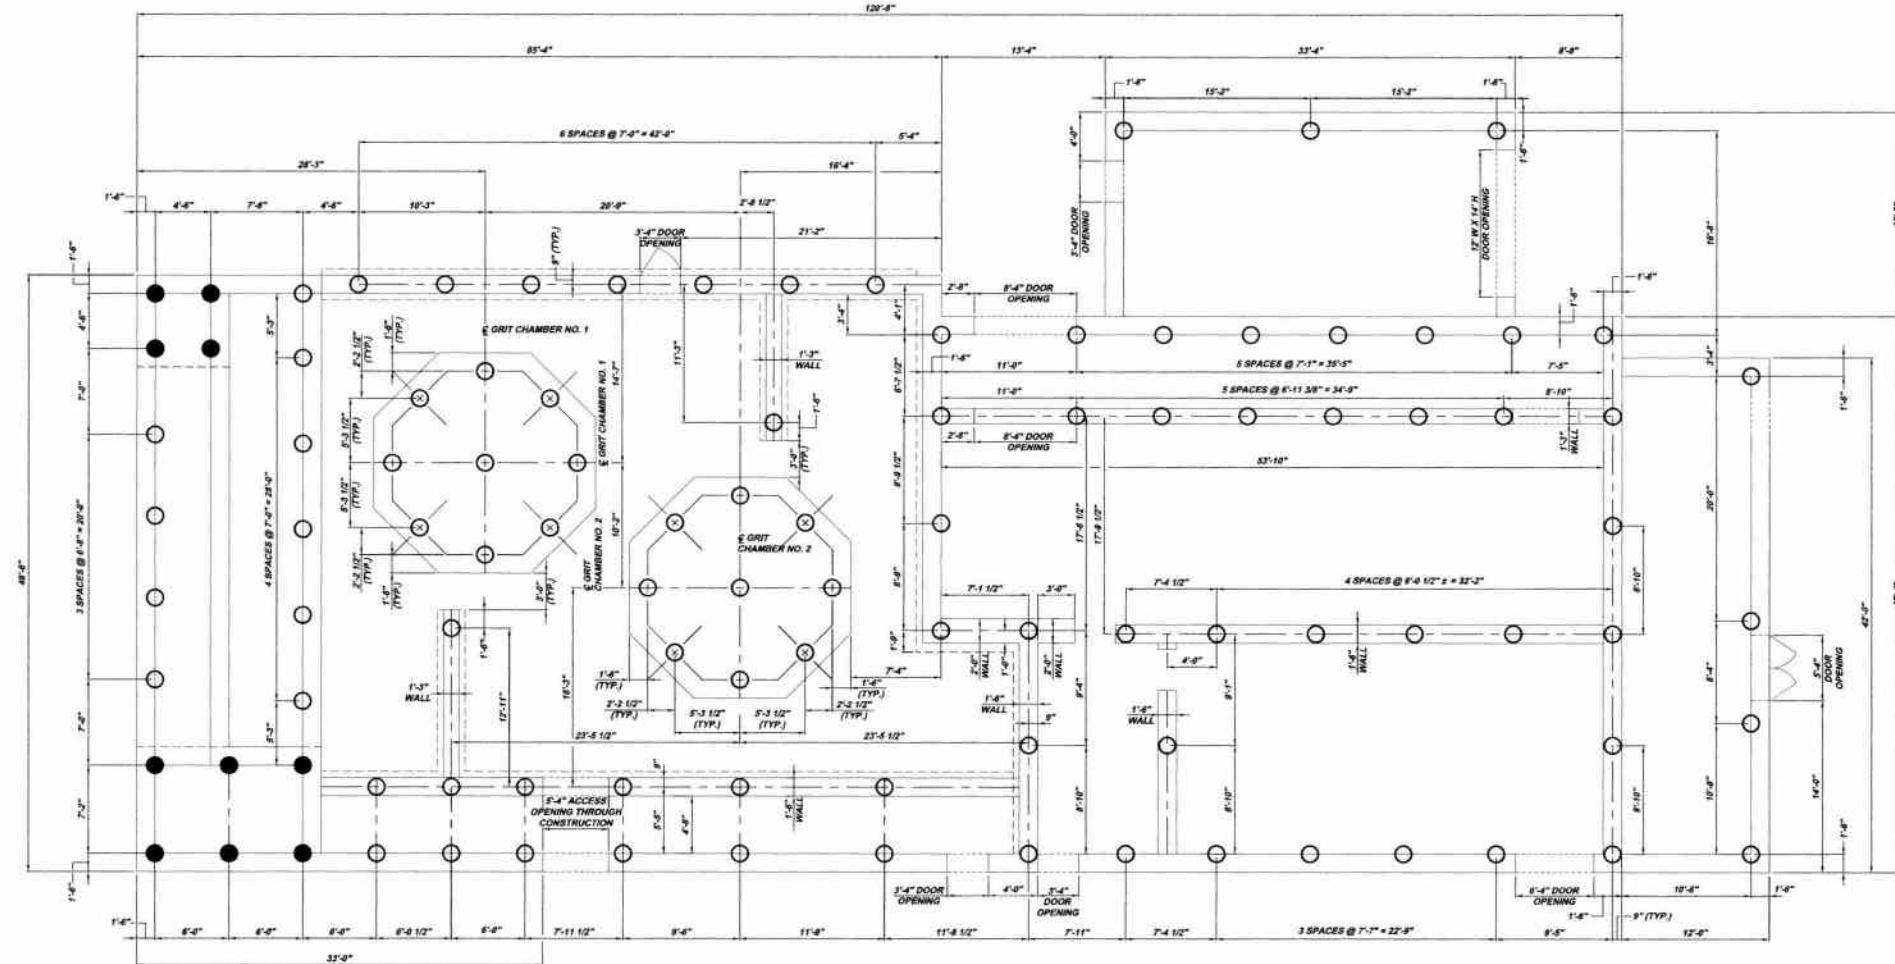

NOTE:
MATERIAL: 2"-0"
PILE: 18" DIAMETER (80 TON CAPACITY),
SHALL EXTEND 6" INTO MAT AND 86" DEEP
MINIMUM

HEAD WORKS PILE PLAN		
DESIGNATION	TOP ELEV.	QUANTITY
●	740.30	10
○	731.79	82

Sheet No.	2
Date:	7-1-08
Drawn By:	DTS
Checked By:	HOF
Approved By:	BHD
Drawing No.	220-32

NOTE:
ITEMS IDENTIFIED WITH UPPER CASE TEXT ARE PROPOSED.
Items Identified With Mixed Case Text are Existing.


KLH
ENGINEERS, INC.


MUNICIPAL AUTHORITY OF THE CITY OF MCKEESEPORT
ALLENTOWN COUNTY, PENNSYLVANIA
CONTRACT NUMBER 2010-01 AND 2010-02
WASTEWATER TREATMENT PLANT EXPANSION
HEADWORKS BUILDING PILE PLAN


5173 DANBESLA RUN ROAD
PITTSBURGH, PA 15236
FAX: 412-920-0428
INFO@KLHENGINEERS.COM


5173 DANBESLA RUN ROAD
PITTSBURGH, PA 15236
FAX: 412-920-0428
INFO@KLHENGINEERS.COM

Date: 7-1-08
REVISION: 0
REVISED: 0
REFINED: 0
RELEASE FOR BD: 1-20-11

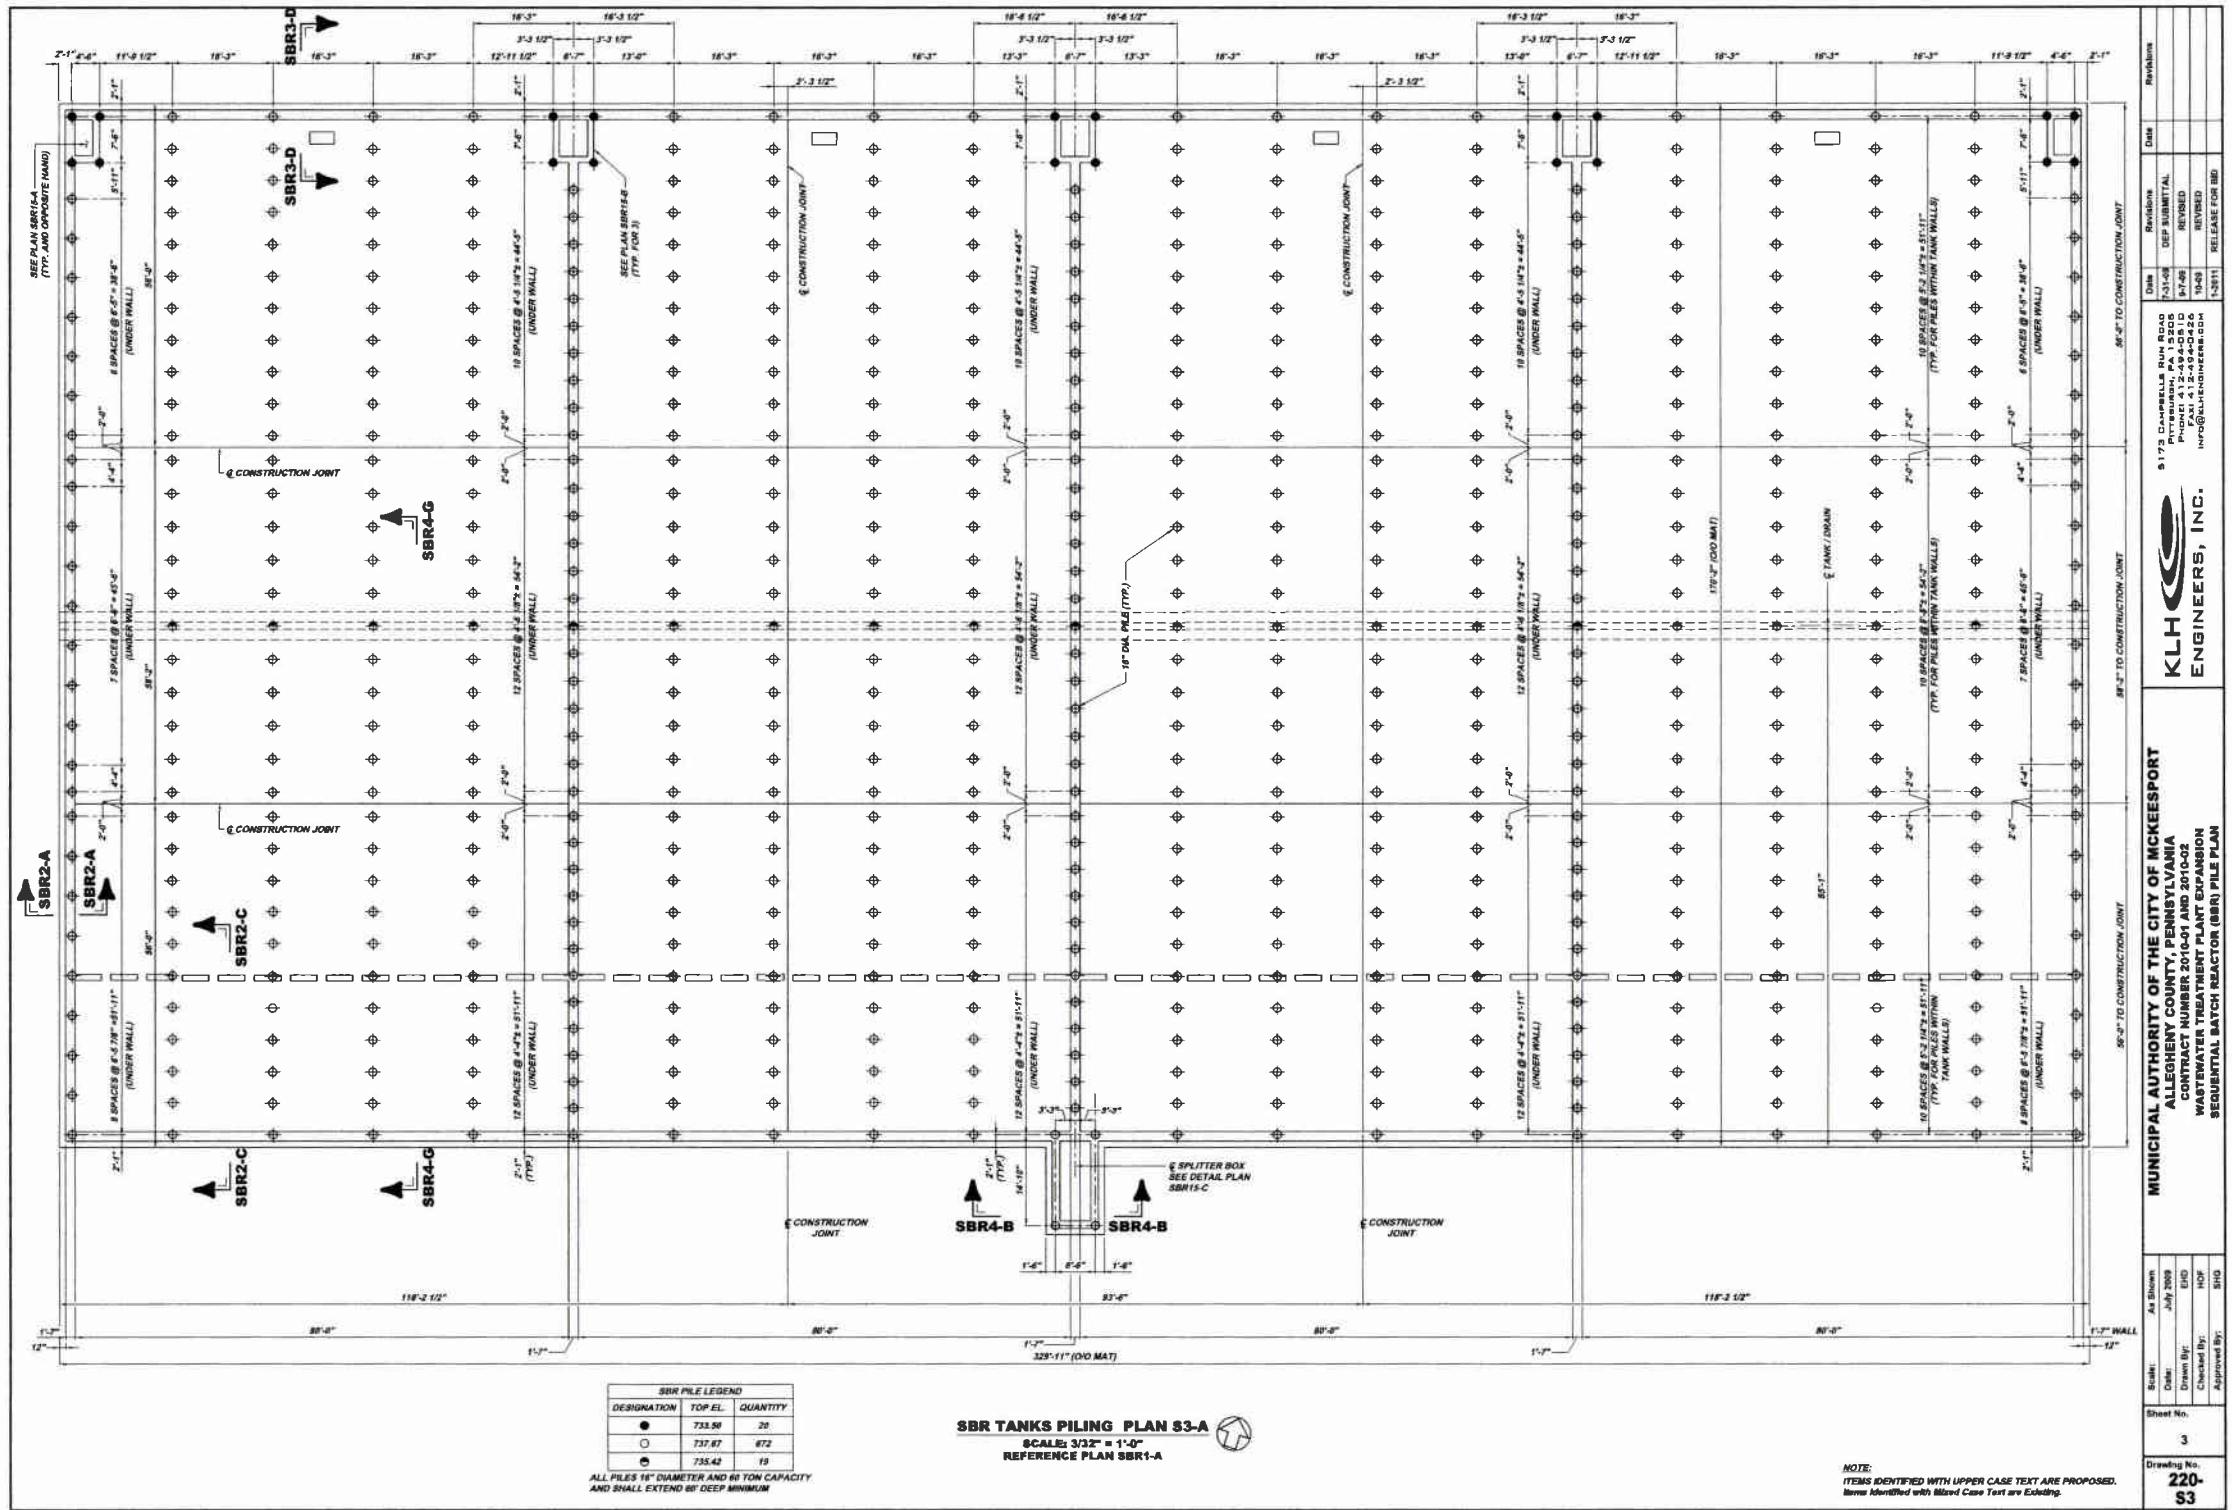

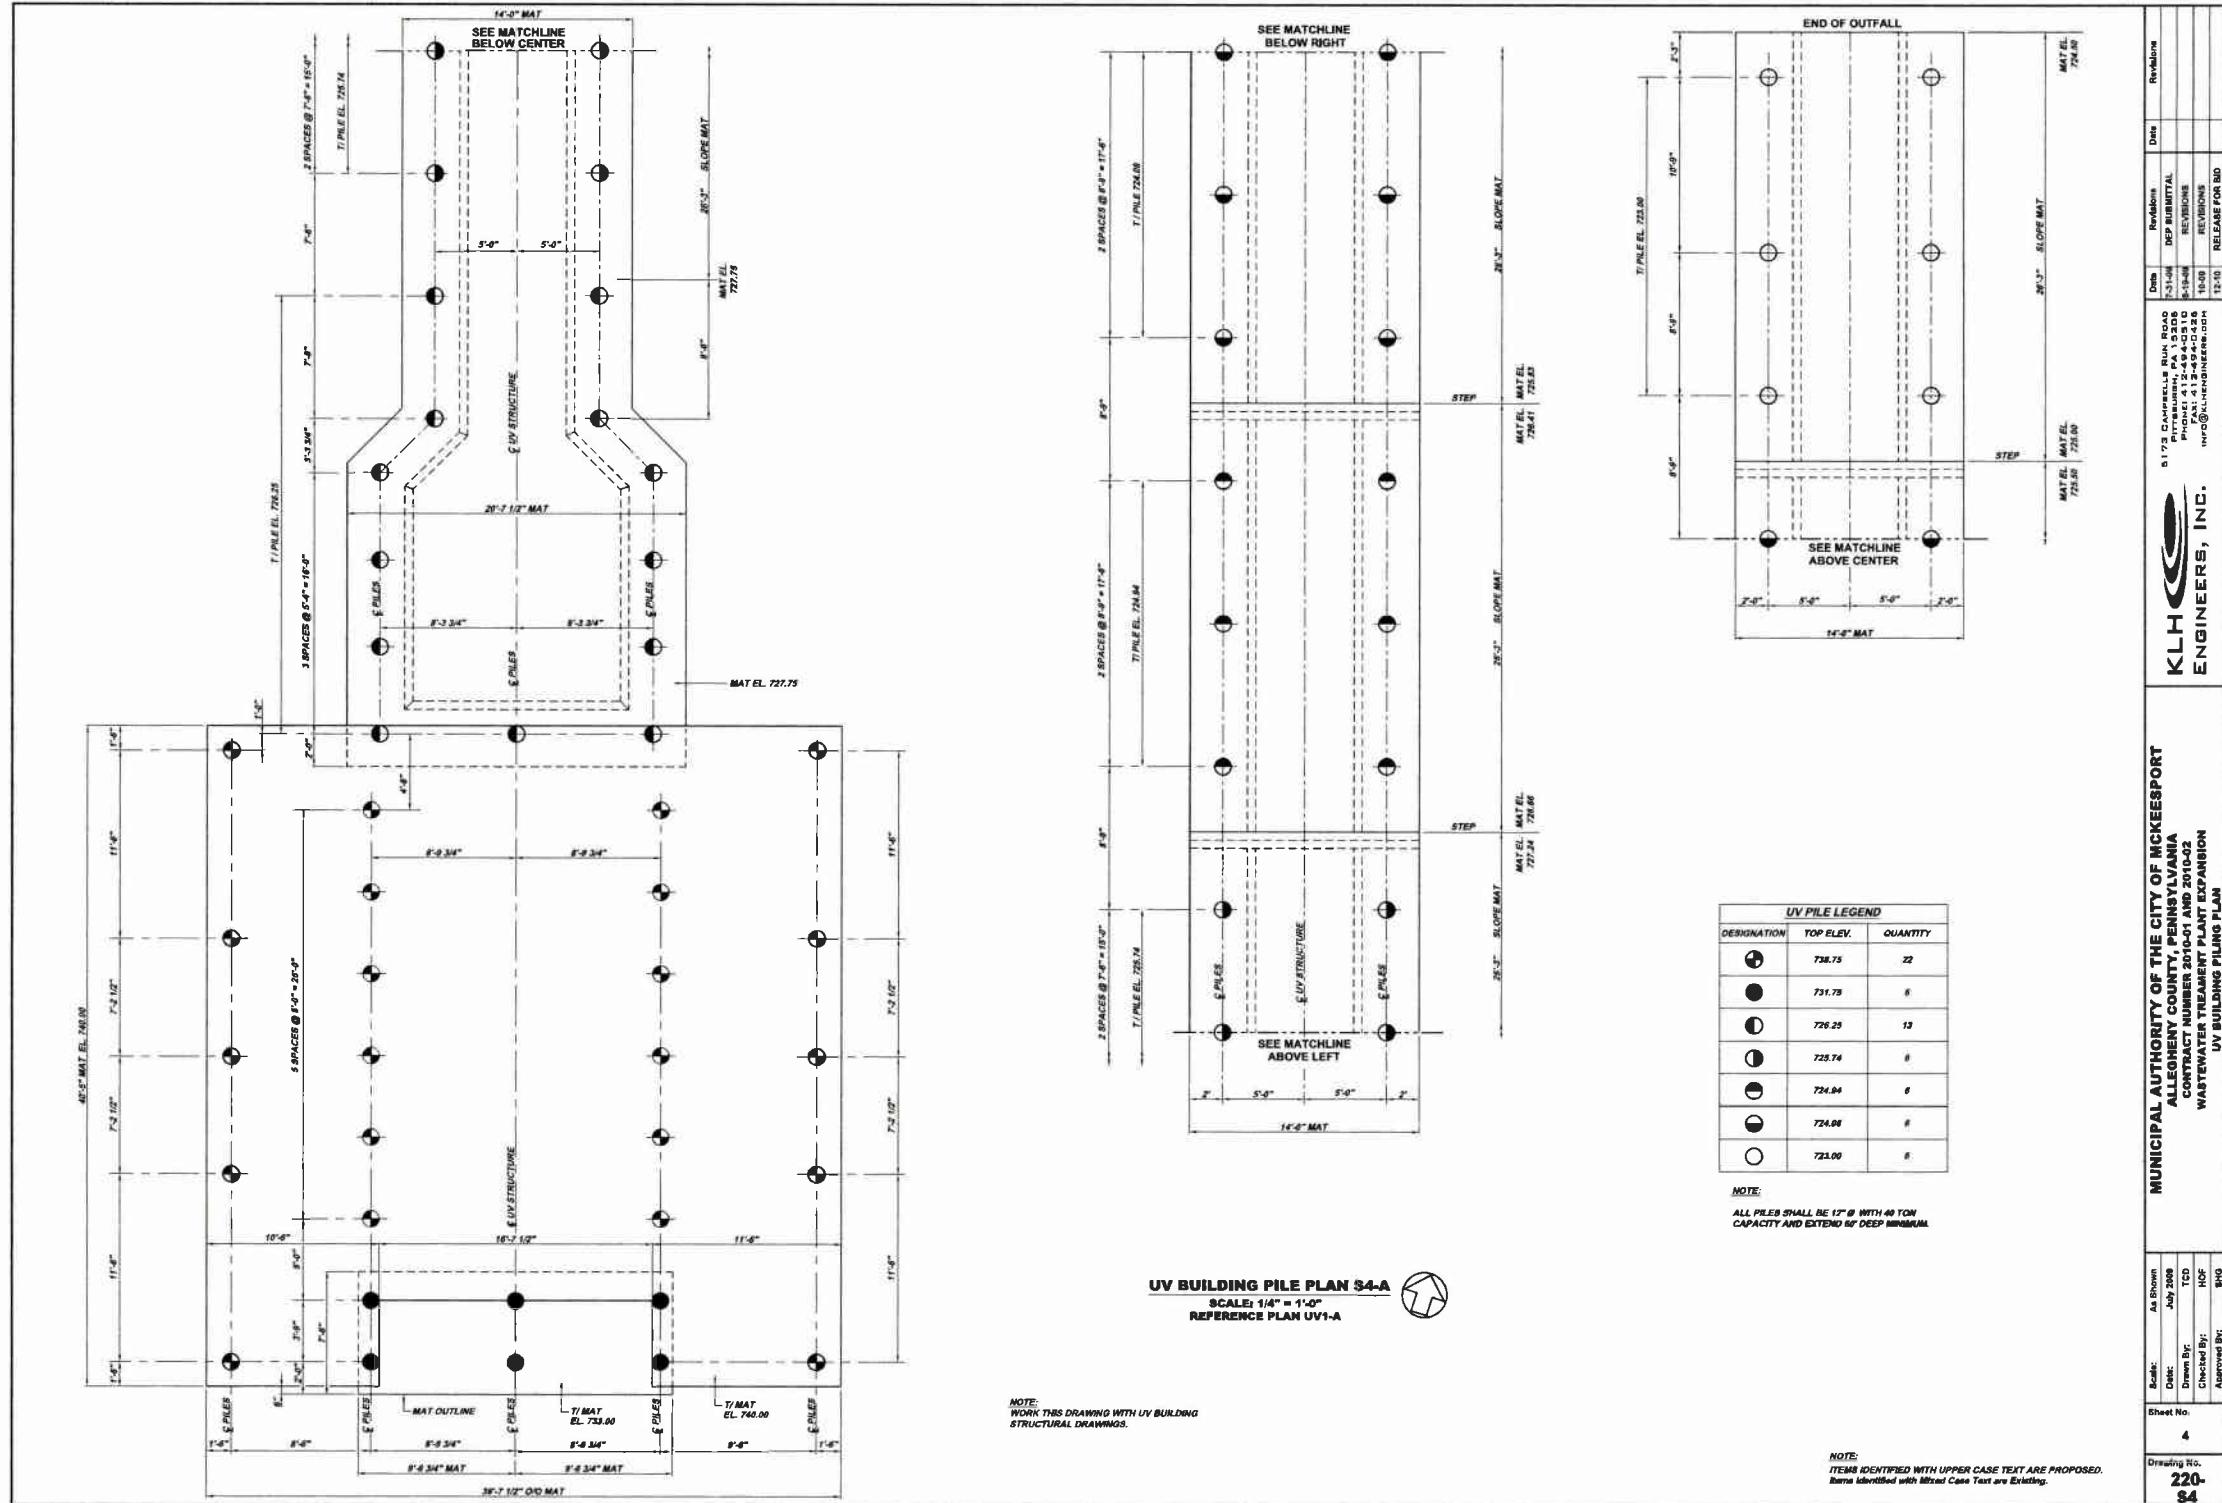

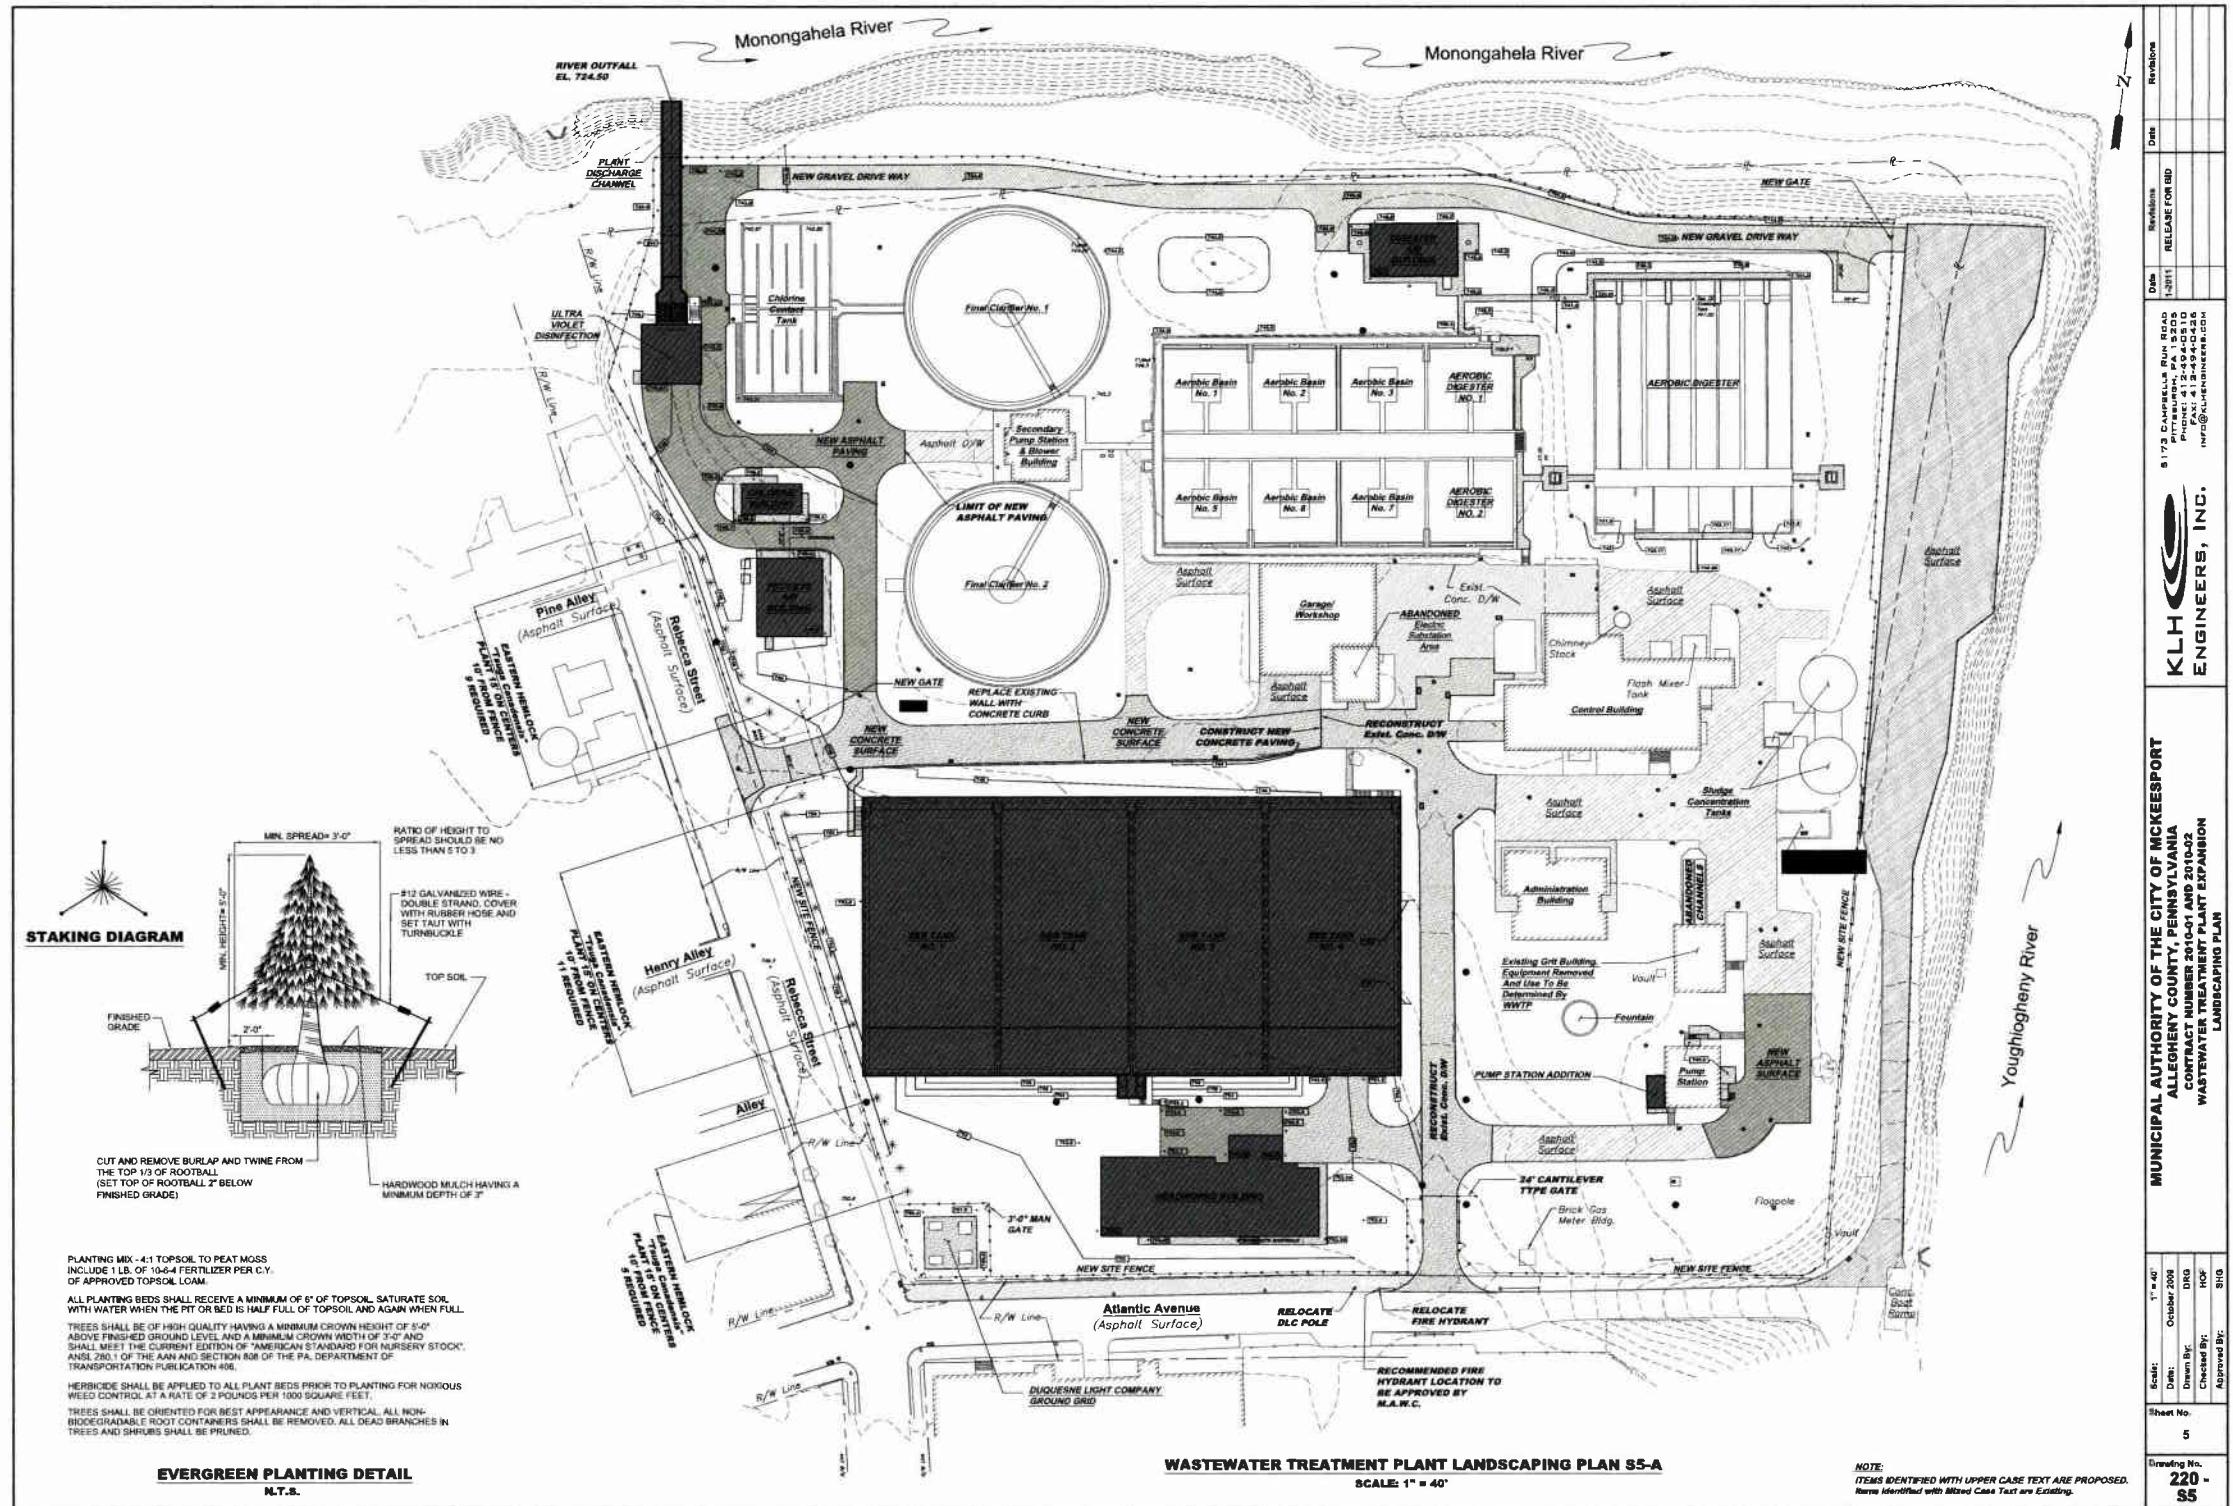


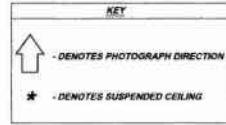

NOTE:

1. CONTRACTOR SHALL CONTACT ALL PUBLIC UTILITY COMPANIES AND DISCONNECT ALL PUBLIC UTILITIES AND REMOVE ALL BUILDING MECHANICAL AND ELECTRICAL SYSTEMS AND PROCESS WITH COMPLETE BUILDING DEMOLITION.

2. PROVIDE DILUTION PHOTOGRAPHS OF THE BUILDING INTERIOR ARE OF THE OWNER'S OWNERS BUSINESS FILES, FURNITURE, SUPPLIES, PARTS, ETC. WILL HAVE BEEN REMOVED BY OTHERS PRIOR TO THIS CONTRACTOR'S NOTICE TO PROCEED.

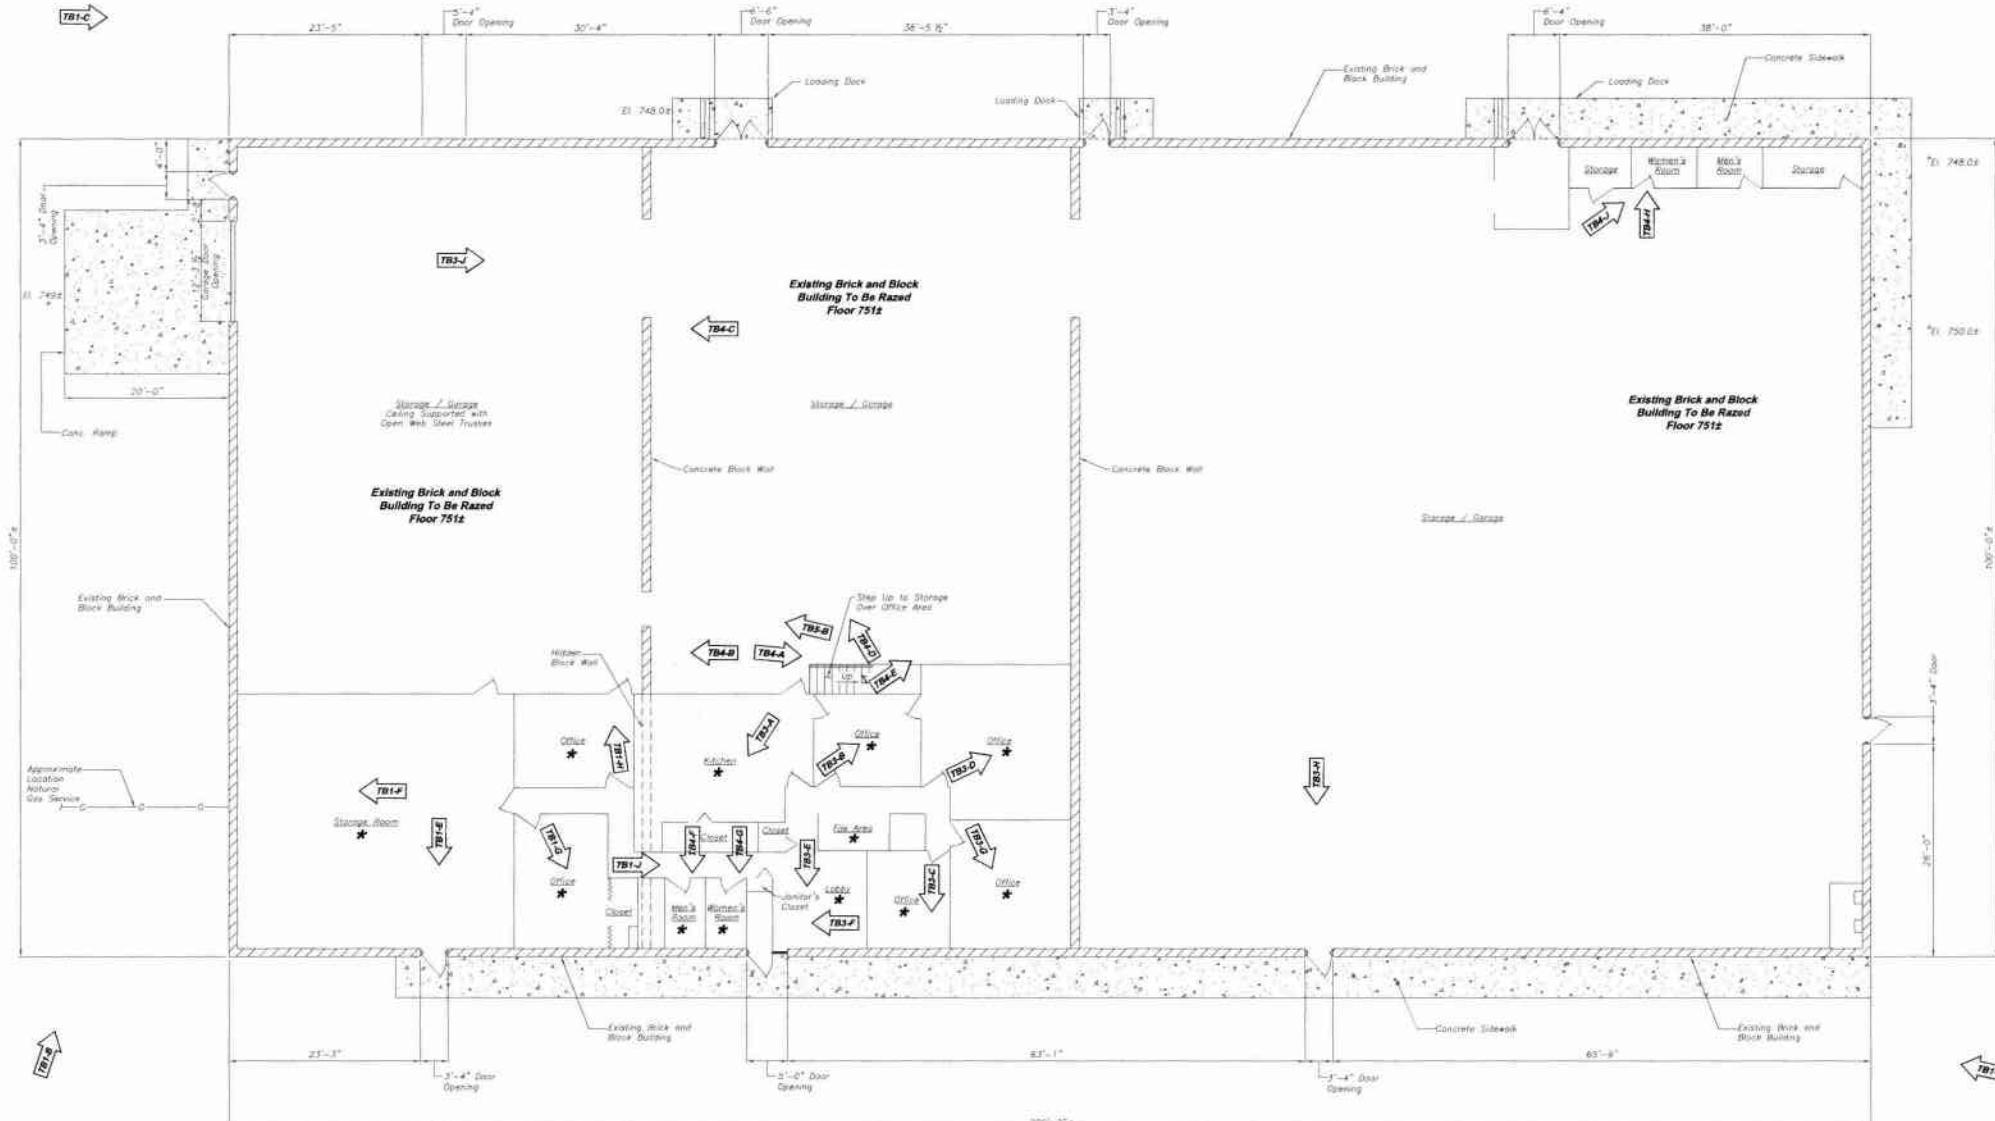

**EXISTING TICO BUILDING
DEMOLITION PLAN TB2-A**

SCALE: 1/8" = 1'-0"

NOTE: ITEMS IDENTIFIED WITH UPPER CASE TEXT ARE PROPOSED.
Items Identified with Mixed Case Text are Existing.



**TICO BUILDING KITCHEN
DEMOLITION PHOTOGRAPH TB3-A
REFERENCE PLAN TB2-A**



**TICO BUILDING OFFICE
DEMOLITION PHOTOGRAPH TB3-B
REFERENCE PLAN TB2-A**



**TICO BUILDING OFFICE
DEMOLITION PHOTOGRAPH TB3-C
REFERENCE PLAN TB2-A**



**TICO BUILDING OFFICE
DEMOLITION PHOTOGRAPH TB3-D
REFERENCE PLAN TB2-A**



**TICO BUILDING LOBBY
DEMOLITION PHOTOGRAPH TB3-E
REFERENCE PLAN TB2-A**



**TICO BUILDING LOBBY
DEMOLITION PHOTOGRAPH TB3-F
REFERENCE PLAN TB2-A**



**TICO BUILDING OFFICE
DEMOLITION PHOTOGRAPH TB3-G
REFERENCE PLAN TB2-A**



**TICO BUILDING STORAGE ROOM
DEMOLITION PHOTOGRAPH TB3-H
REFERENCE PLAN TB2-A**



**TICO BUILDING STORAGE ROOM
DEMOLITION PHOTOGRAPH TB3-J**

REFERENCE PLAN TB2-A

727 CAMPBELLS RUN ROAD
PITTSBURGH, PA 15206
PHONE: 412-438-0110
FAX: 412-249-4310
INFO@KIRKHORNREER.COM


KLH ENGINEERS, INC.

MUNICIPAL AUTHORITY OF THE CITY OF MCKEEESPORT
ALLENTOWN COUNTY, PENNSYLVANIA
CONTRACT NUMBER 2016-Q-1 AND 2010-Q-2
WASTEWATER TREATMENT PLANT EXPANSION
TICO BUILDING DEMOLITION PHOTOGRAPHS

Aa Shewen
 October 2009
 MKE
 HOF
 SHG
 B
 Drawing No.
**220-
TB3**



TICO BUILDING STORAGE STAIRS
DEMOLITION PHOTOGRAPH TB4-A
REFERENCE PLAN TB2-A

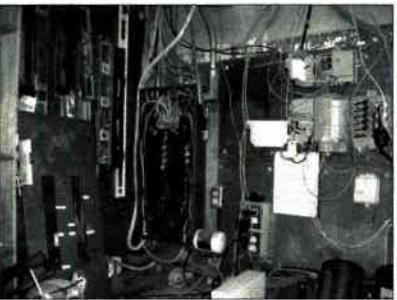

TICO BUILDING ELECTRICAL PANEL
DEMOLITION PHOTOGRAPH TB4-B
REFERENCE PLAN TB2-A



TICO BUILDING WATER MAIN
DEMOLITION PHOTOGRAPH TB4-C
REFERENCE PLAN TB2-A



TICO BUILDING STORAGE ROOM
DEMOLITION PHOTOGRAPH TB4-D
REFERENCE PLAN TB2-A




TICO BUILDING STORAGE ROOM
DEMOLITION PHOTOGRAPH TB4-E
REFERENCE PLAN TB2-A



TICO BUILDING MENS ROOM
DEMOLITION PHOTOGRAPH TB4-F
REFERENCE PLAN TB2-A



TICO BUILDING WOMENS ROOM
DEMOLITION PHOTOGRAPH TB4-G
REFERENCE PLAN TB2-A

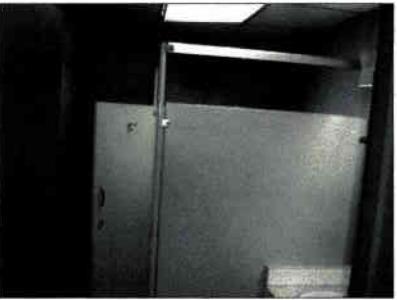

TICO BUILDING STORAGE ROOM WOMENS ROOM
DEMOLITION PHOTOGRAPH TB4-H
REFERENCE PLAN TB2-A




TICO BUILDING STORAGE ROOM WOMENS ROOM
DEMOLITION PHOTOGRAPH TB4-J
REFERENCE PLAN TB2-A

Building:	As Drawn	Revisions:	Date:	Revisions:
			12/2011	RELEASE FOR BLD
S172 CAMPELLE RUN ROAD				
PITTSBURGH, PA 15235				
PHONE: 412-249-4430				
FAX: 412-249-4438				
INFO@KLHENGINEERS.COM				
KLH	KLH	KLH		
ENGINEERS, INC.				

NOTE:
ITEMS IDENTIFIED WITH UPPER CASE TEXT ARE PROPOSED.
Items Identified with Mixed Case Text are Existing.


4
Drawing No.
220-
TB4

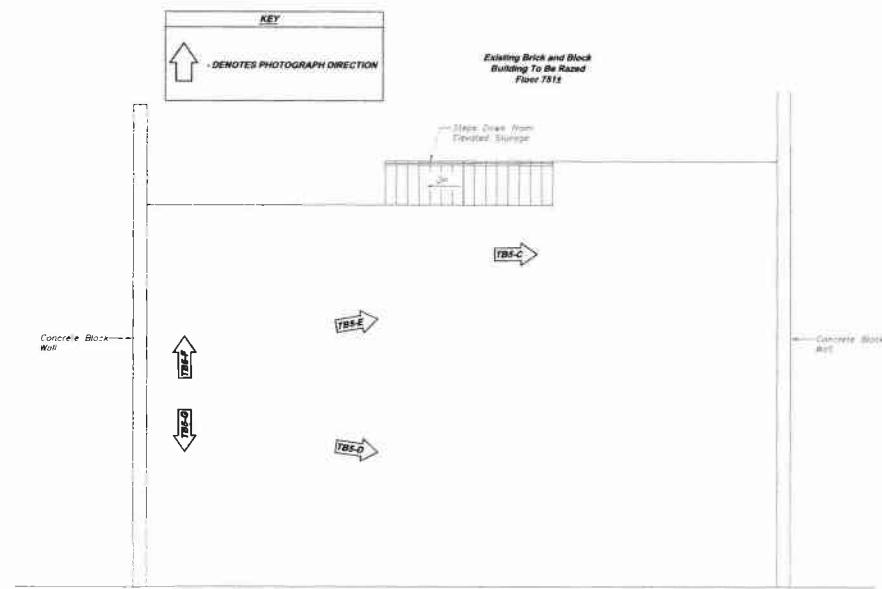

**TICO BUILDING STORAGE ROOM
DEMOLITION PHOTOGRAPH TB5-B**
REFERENCE PLAN TB2-A



**TICO BUILDING UPPER STORAGE ROOM
DEMOLITION PHOTOGRAPH TB5-C**
REFERENCE PLAN TB5-A

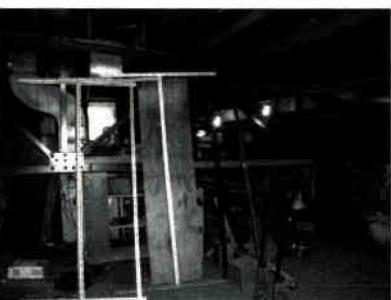

**TICO BUILDING UPPER STORAGE ROOM
DEMOLITION PHOTOGRAPH TB5-D**
REFERENCE PLAN TB5-A



**TICO BUILDING UPPER STORAGE ROOM
DEMOLITION PHOTOGRAPH TB5-E**
REFERENCE PLAN TB5-A



**TICO BUILDING UPPER STOARGE ROOM
DEMOLITION PHOTOGRAPH TB5-F**
REFERENCE PLAN TB5-A



**TICO BUILDING UPPER STORAGE ROOM
DEMOLITION PHOTOGRAPH TB5-G**
REFERENCE PLAN TB5-A

NOTE:
ITEMS IDENTIFIED WITH UPPER CASE TEXT ARE PROPOSED.
Items Identified with Mixed Case Text are Existing.

Sheet No.	As Shown	Date:	Revisions	Date:	Revisions
5		10/20/09		10/31/11	RELEASE FOR BID
		ME		PRINTED	10/20/11
		HOF		FAX	412-349-0448
		BHO		INFO@KLHENGINEERS.COM	

KLH
ENGINEERS, INC.

MUNICIPAL AUTHORITY OF THE CITY OF MCKEEESPORT
ALLENTOWN COUNTY, PENNSYLVANIA
CONTRACT NUMBER 2010-01 AND 2010-02
WASTEWATER TREATMENT PLANT EXPANSION
TICO BUILDING DEMOLITION PLAN AND PHOTOGRAPHS

Drawing No.
**220-
TB5**

5

WASTEWATER TREATMENT PLANT PUMP STATION DRAWING REFERENCE									
SHEET NO.	DWG. NO.	DESCRIPTION	SHEET NO.	DWG. NO.	DESCRIPTION				
1	220-PS1	DEMOLITION ELEVATIONS	10	220-PS10	IMPROVEMENT PLANS				
2	220-PS2	DEMOLITION PLANS	11	220-PS11	IMPROVEMENT PLANS				
3	220-PS3	DEMOLITION PLANS	12	220-PS14	IMPROVEMENT SECTIONS				
4	220-PS11	DEMOLITION PLANS, SECTIONS AND DETAILS	13	220-PS13	IMPROVEMENT SECTIONS, PLANS AND SCHEDULE				
5	220-PS4	DEMOLITION SECTIONS	14	220-PS9	ROOF IMPROVEMENT PLAN AND DETAILS				
6	220-PS5	DEMOLITION PHOTOGRAPHS	15	220-PS12	WALL AND WINDOW IMPROVEMENT DETAILS				
7	220-PS6	DEMOLITION PHOTOGRAPHS	16	220-PS18	SCHEMATIC DIAGRAMS				
8	220-PS7	DEMOLITION PHOTOGRAPHS	17	220-PS15	STRUCTURAL PLANS, SECTIONS AND DETAILS				
9	220-PS8	DEMOLITION ELEVATIONS	18	220-PS16	STRUCTURAL PLANS, SECTIONS AND DETAILS				
			19	220-PS17	STRUCTURAL PLANS, SECTIONS AND DETAILS				

**W.W.T.P. PUMP STATION DEMOLITION
NORTH ELEVATION PS1-A**
SCALE: 1/4" = 1'-0"
REFERENCE PLAN PS2-A

**W.W.T.P. PUMP STATION DEMOLITION
WEST ELEVATION PS1-B**
SCALE: 1/4" = 1'-0"
REFERENCE PLAN PS2-A

**W.W.T.P. PUMP STATION DEMOLITION
SOUTH ELEVATION PS1-C**
SCALE: 1/4" = 1'-0"
REFERENCE PLAN PS2-A

**W.W.T.P. PUMP STATION DEMOLITION
EAST ELEVATION PS1-D**
SCALE: 1/4" = 1'-0"
REFERENCE PLAN PS2-A

Date	Revised	Date	Revised
7-1-09	DEP SUBMITTED		
7-1-09	REVISED		
7-1-09	RELEASE FOR BID		
7-1-09			

Date	Revised	Date	Revised
7-1-09	DEP SUBMITTED	7-1-09	REVISED
7-1-09	RELEASE FOR BID	7-1-09	REVISED
7-1-09			

MUNICIPAL AUTHORITY OF THE CITY OF MCKEESEPORT
ALLENTOWN COUNTY, PENNSYLVANIA
PROJECT NUMBER 2010-01 AND 2010-02
WASTEWATER TREATMENT PLANT EXPANSION
PUMP STATION DEMOLITION ELEVATIONS

5173 CAMPELLE RUN ROAD
MUTTERSBURG, PA 17543
TEL: 412-394-0420
FAX: 412-394-0425
INFO@KELHENGINEERS.COM


**KLH
ENGINEERS, INC.**

As Drawn
July 2009
ARKE
Drawn By:
Checked By:
Approved By:


Sheet No.:
1

Drawing No.:
**220-
PS1**

NOTE:
ITEMS IDENTIFIED WITH UPPERCASE TEXT ARE PROPOSED
Items Identified with Mixed Case Text are Existing.

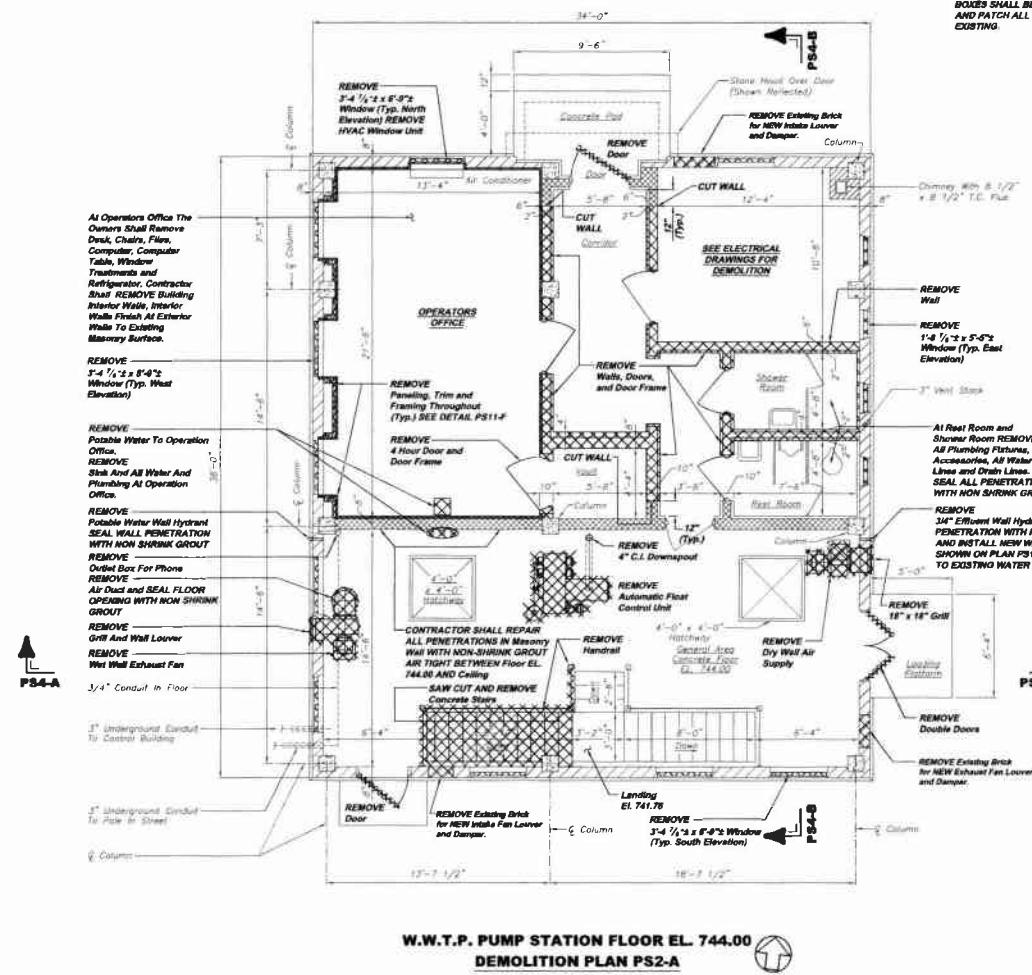

NOTE: REMOVE ALL ELECTRICAL EQUIPMENT INSIDE THE ENTIRE PUMP STATION. THIS SHALL INCLUDE ALL CONDUIT, WIRE, PANELS, LIGHTS, RECEPTACLES, ETC. ALL RECESSED BOXES SHALL BE FITTED WITH BLANK COVER AND PATCH ALL PENETRATIONS TO MATCH EXISTING.

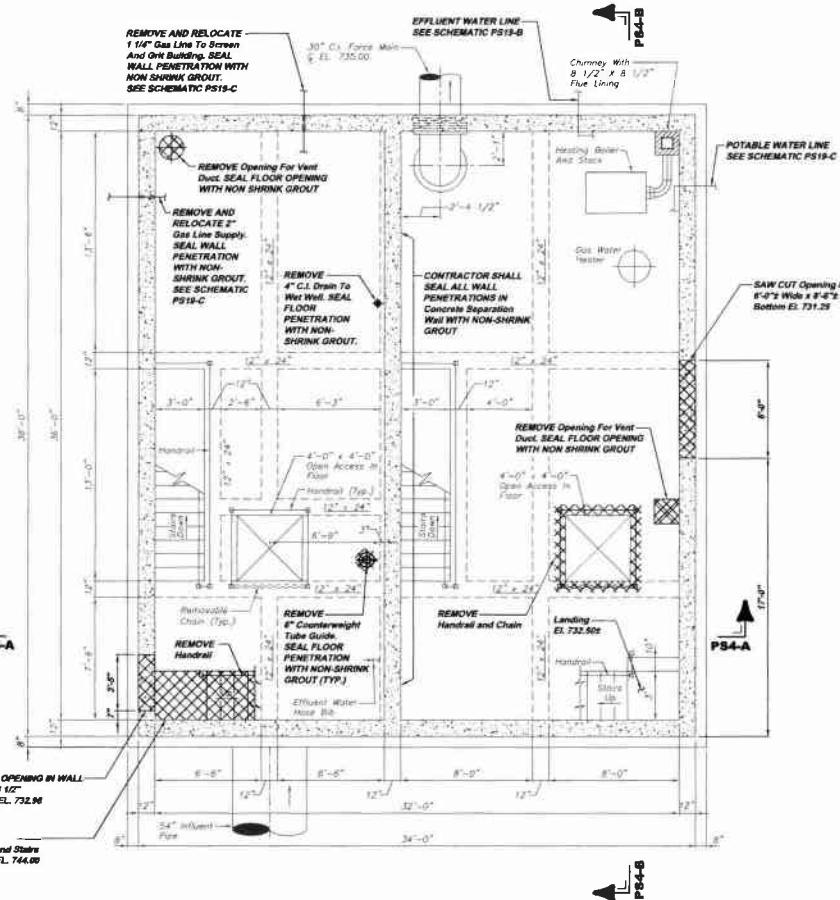


W.W.T.P. PUMP STATION FLOOR EL. 731.29 
DEMOLITION PLAN PS2-B

SCALE: 1/4" = 1'-0"
REFERENCE PLAN P92-A

NOTE:
CONTRACTOR SHALL SEAL AIR TIGHT ALL
DEMOLITION PENETRATIONS, EXISTING AND
NEW PIPE PENETRATIONS IN CONCRETE
BETWEEN PUMP STATION WET WELL AND
PUMP STATION DRY WELL (TYP. ALL
FLOOR).

Sheet No.	A. Bilewski	MUNICIPAL AUTHORITY OF THE CITY OF MCKEESPORT ALLENTOWN COUNTY, PENNSYLVANIA CONTRACT NUMBER 2010-01 AND 2010-02 WASTEWATER TREATMENT PLANT EXPANSION PUMP STATION DEMOLITION PLAN		KLH ENGINEERS, INC.	Revisions Date REVIEWED RELEASE FOR BID 10/25/2011
Date:	July 2008	Drawn By:	P. ROZD PTC/MARSHALL, PA	Due Date:	7/31/08 10/29/08
Drawn By:		Checked By:	P. ROZD PTC/MARSHALL, PA	Reviewed By:	
Approved By:	BHO				
2					

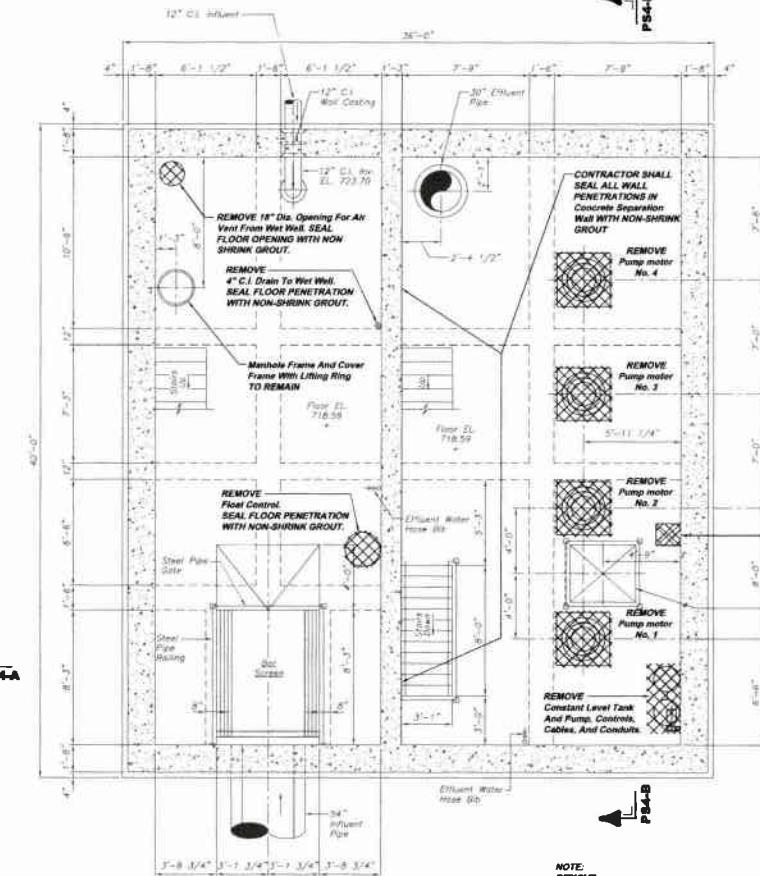


W.W.T.P. PUMP STATION FLOOR EL. 718.59

DEMOLITION PLAN PS3-A

SCALE: 1/4" = 1'-0"

REFERENCE PLAN PS2-B


NOTE: REMOVE ALL ELECTRICAL EQUIPMENT INSIDE THE ENTIRE PUMP STATION. THIS SHALL INCLUDE ALL CONDUIT, WIRE PANELS, LIGHTS, RECEPTACLES, ETC. ALL RECESSED BOXES SHALL BE FITTED WITH BLANK COVER AND PATCH ALL PENETRATIONS TO MATCH EXISTING.

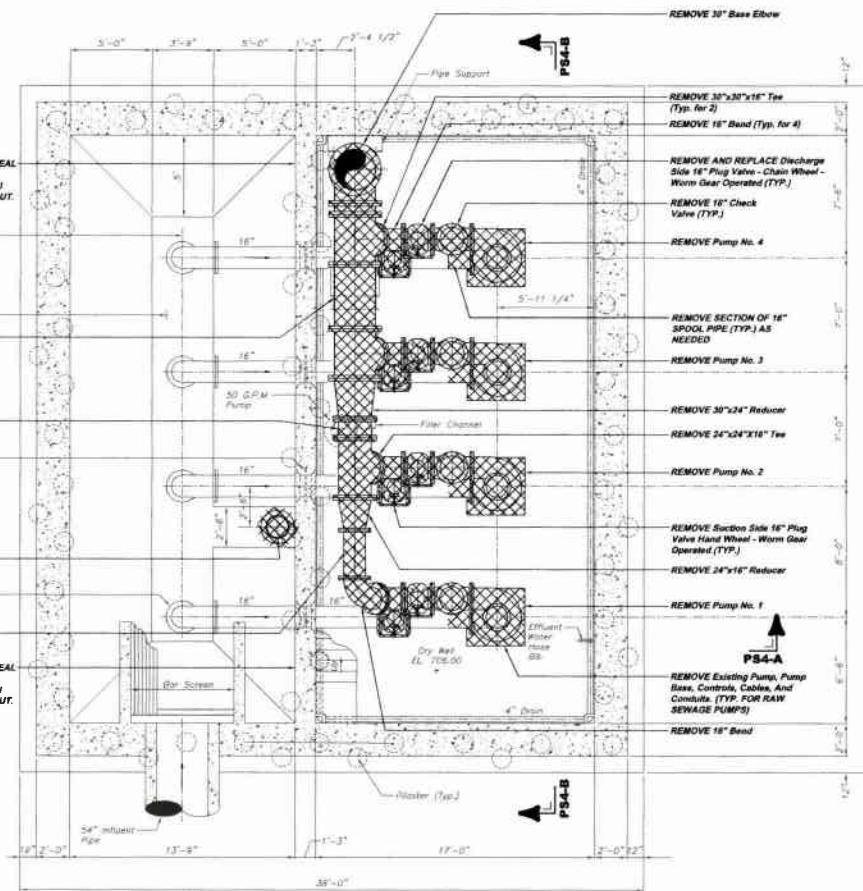

**W.W.T.P. PUMP STATION
PUMP ROOM FLOOR EL.706.00 DEMOLITION
AND WET WELL EL. 703.00 DEMOLITION PLAN PS3-B**


NOTE:
ITEMS IDENTIFIED WITH UPPER CASE TEXT ARE PROPOSED
Items Identified with Mixed Case Text are Existing.

Street:	Ay Shem	City:	MCKEESPORT
Date:	July 2008	County:	ALLEGHENY COUNTY
Owner By:	NME	Contract Number:	2011-01 AND 2010-02
Approved By:	SHD	WASTEWATER TREATMENT PLANT EXPANSION PUMP STATION DEMOLITION PLANS	
Printed No.	3	Revisions:	Date:
Drawing No.	220- PS3	DEB	REBUTTAL
		1-14-08	10-16-08
		FAX: 412-644-3010	REV'D
		412-644-2426	RELEASE FOR BID
		INFO@KLH-ENGINEERS.COM	8/28/11

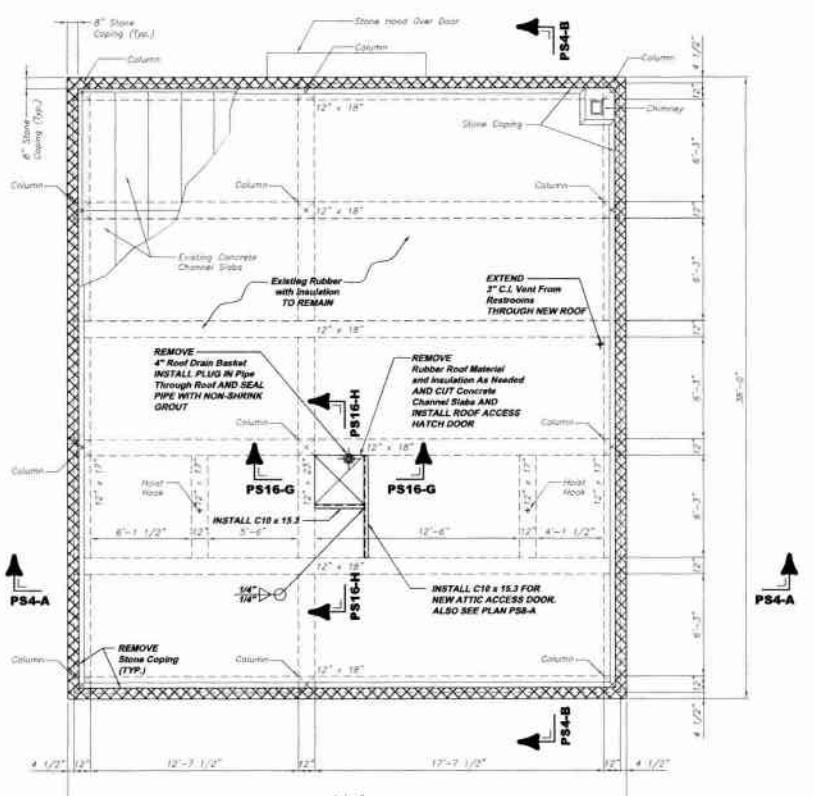


**W.W.T.P. PUMP STATION
ROOF DEMOLITION PLAN PS11-A**

SCALE: 1/4" = 1'-0"
REFERENCE PLAN PS2-A

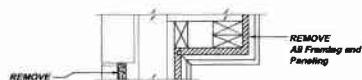


DETAIL PS11-F

SCALE: 1 1/2" = 1'-0"
REFERENCE PLAN PS2-A

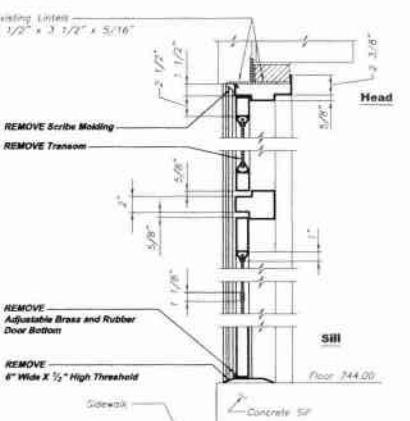


DOOR DEMOLITION DETAIL PS11-B

SCALE: 1 1/2" = 1'-0"
REFERENCE PLAN PS2-A

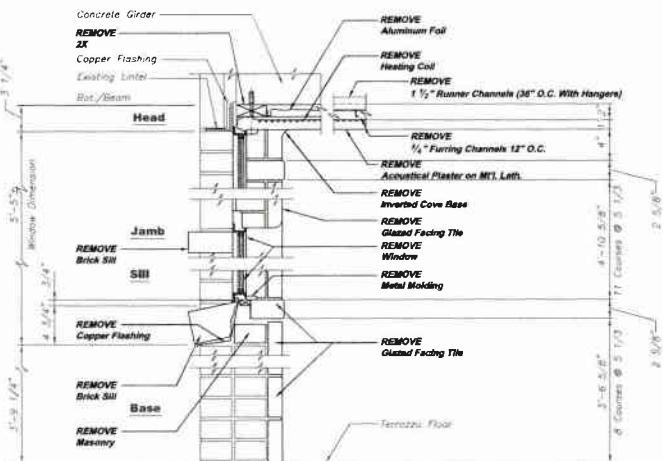


**WINDOW DEMOLITION DETAIL PS11-C
(TYP. AT OPERATORS OFFICE)**

SCALE: 1 1/2" = 1'-0"
REFERENCE PLAN PS2-A

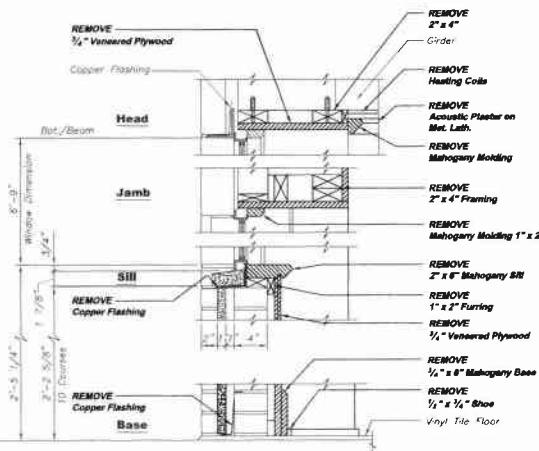

**WINDOW DEMOLITION DETAIL PS11-D
(TYP. AT REST ROOM AND SHOWER ROOM)**

SCALE: 1 1/2" = 1'-0"
REFERENCE PLAN PS2-A

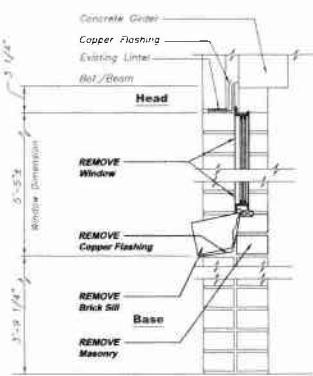

**WINDOW DETAIL PS11-E
(TYP. AT GENERAL AREA AND ELECTRICAL ROOM)**

SCALE: 1 1/2" = 1'-0"
REFERENCE PLAN PS2-A

**MUNICIPAL AUTHORITY OF THE CITY OF MCKEEKESPORT
ALLENTOWN COUNTY, PENNSYLVANIA
CONTRACT NUMBER 2010-01 AND 2010-02
WASTEWATER TREATMENT PLANT
PUMP STATION DEMOLITION PLANS, SECTIONS AND DETAILS**


**KLH
ENGINEERS, INC.**

Date	Revisions	Date	Revisions
7/3/08	DEP SUBMITTED	7/3/08	
7/10/08	REVISED	7/10/08	
7/14/08	RELEASE FOR BID	7/14/08	
7/14/08	INFO@KLHEngineers.com		

Scale:	As Shown
Date:	July 2008
Drawn By:	MME
Checked By:	HOF
Approved By:	SMA

Drawing No.	220-PS11
4	






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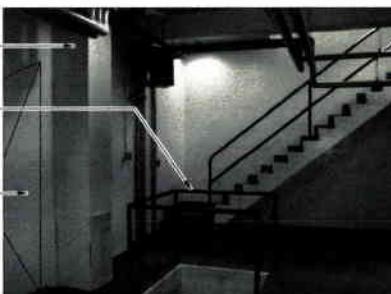


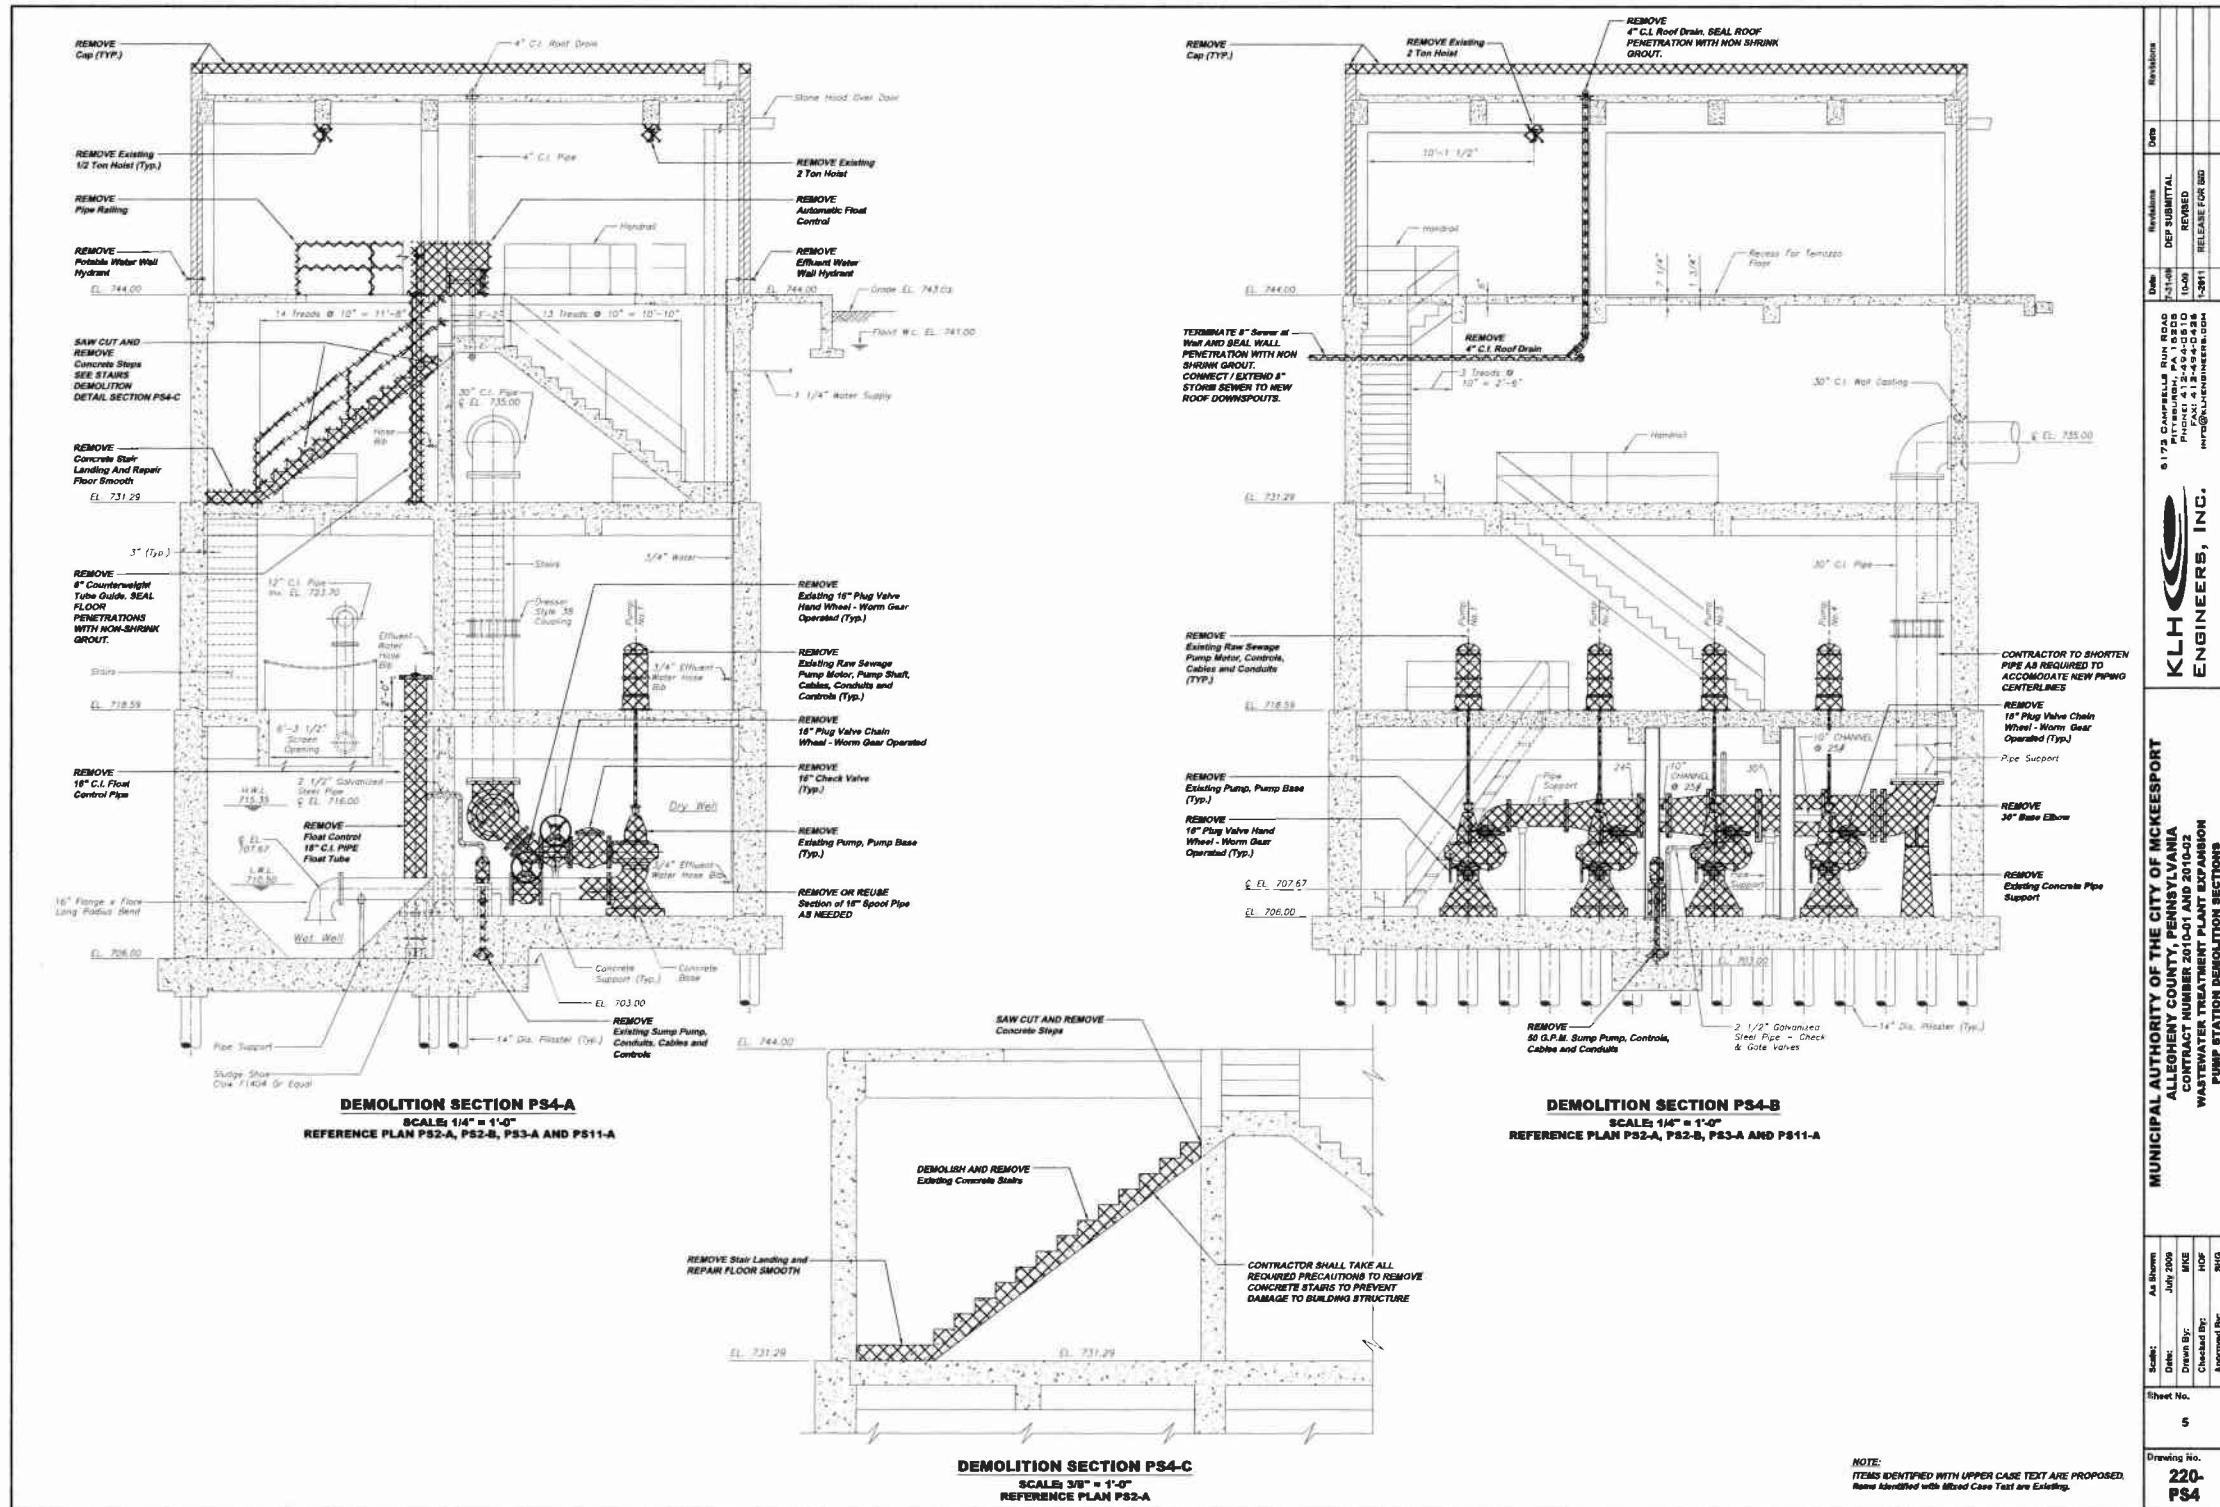6172 CAMPBELL RUN ROAD
PITTSBURGH, PA 15236
PHONE: 412-239-4444
FAX: 412-239-4445
E-MAIL: MWP@LHEngineering.com


KLH
ENGINEERS, INC.


MUNICIPAL AUTHORITY OF THE CITY OF MCKEESEPORT
ALLENTOWN COUNTY, PENNSYLVANIA
CONTRACT NUMBER 2010-01 AND 2010-02
WASTEWATER TREATMENT PLANT EXPANSION
PUMP STATION DEMOLITION SECTIONS

W.W.T.P. PUMP STATION																																															
DEMOLITION PHOTOGRAPH			DEMOLITION PHOTOGRAPH																																												
 <p>REMOVE Lower CLOSE OPENING WITH SPLIT FACE BLOCK</p> <p>REMOVE Stone Casing (TYP.)</p> <p>REMOVE Exterior Window. CONTRACTOR SHALL FIELD VERIFY OPENING DIMENSION AND INSTALL GLASS BLOCK.</p> <p>REMOVE Door, Transom, AND Door Frame. CONTRACTOR SHALL FIELD VERIFY OPENING DIMENSIONS.</p> <p>REMOVE Windows, Exhaust Vents, Louvers, and Window Sills. INSTALL SPLIT FACE BLOCK.</p>			 <p>REMOVE Stone Casing (TYP.)</p> <p>REMOVE Door, Transom, AND Door Frame. CONTRACTOR SHALL FIELD VERIFY OPENING DIMENSIONS.</p> <p>REMOVE Existing Windows, AND INSTALL GLASS BLOCK CONTRACTOR SHALL FIELD VERIFY OPENING DIMENSIONS (TYP. FOR 3 THIS WALL)</p>																																												
W.W.T.P. PUMP STATION NORTH ELEVATION DEMOLITION PHOTOGRAPH PS5-A <small>REFERENCE ELEVATION PS1-A</small>			W.W.T.P. PUMP STATION SOUTH ELEVATION DEMOLITION PHOTOGRAPH PS5-B <small>REFERENCE ELEVATION PS1-C</small>																																												
 <p>REMOVE Exterior Duct AND Housing REPAIR ALL PENETRATIONS IN BRICK WITH SPLIT FACE BLOCK AND IN ROOF WITH NON-SHRINK GROUT.</p> <p>REMOVE Exterior Window. CONTRACTOR SHALL FIELD VERIFY OPENING DIMENSIONS.</p> <p>REMOVE Close opening with SPLIT FACE BLOCK.</p>			 <p>REMOVE Cast iron Roof Drain</p> <p>REMOVE Vibrating Machine TO LOCATION SELECTED BY OWNER</p> <p>REMOVE Windows REPLACE WITH BLOCK</p> <p>REMOVE Railing</p> <p>REMOVE Fan</p>																																												
W.W.T.P. PUMP STATION WEST ELEVATION DEMOLITION PHOTOGRAPH PS5-C <small>REFERENCE ELEVATION PS1-B</small>			W.W.T.P. PUMP STATION FLOOR EL. 744.00 DEMOLITION PHOTOGRAPH PS5-F <small>REFERENCE PLAN PS2-A</small>																																												
 <p>REMOVE Windows, Exhaust Vents, Louvers, and Window Sills. INSTALL SPLIT FACE BLOCK. See Demolition Detail PS11-D AND PS11-E</p> <p>REMOVE Stone Casing (TYP.)</p> <p>REMOVE Light Support, Cables, AND Conduit.</p> <p>REMOVE Root Scupper. SEAL OPENING WITH NON-SHRINK GROUT.</p> <p>REMOVE Double Door, Transom, AND Door Frame. CONTRACTOR SHALL FIELD VERIFY OPENING DIMENSIONS.</p> <p>REMOVE Louver / Damper CLOSE OPENING WITH SPLIT FACE BLOCK.</p>			 <p>REMOVE Interior Walls</p> <p>REMOVE Door and Door Frame</p> <p>REMOVE Water Cooler and RETURN TO OWNER</p> <p>REMOVE Motor Control Center, Cables and Conduits in Accordance with Electrical Drawings.</p>																																												
W.W.T.P. PUMP STATION EAST ELEVATION DEMOLITION PHOTOGRAPH PS5-D <small>REFERENCE ELEVATION PS1-D</small>			W.W.T.P. PUMP STATION FLOOR EL. 744.00 DEMOLITION PHOTOGRAPH PS5-H <small>REFERENCE PLAN PS2-A</small>																																												
 <p>REMOVE Ceiling See Contract Drawings</p> <p>Existing Operation Office - Owner Shall REMOVE Desk, Chairs, File Computer, Computer Table, File Window Treatments, Refrigerator, Contractor Shall REMOVE Building Interior Finishes, Existing Finishes on Interior and Exterior Walls to Existing Masonry Surface as Identified in the Contract Drawings.</p> <p>REMOVING Existing Paneling</p>			 <p>NOTE: ITEMS IDENTIFIED WITH UPPER CASE TEXT ARE PROPOSED. Items Identified with Mixed Case Text are Existing.</p>																																												
W.W.T.P. PUMP STATION FLOOR EL. 744.00 DEMOLITION PHOTOGRAPH PS5-G <small>REFERENCE PLAN PS2-A</small>			W.W.T.P. PUMP STATION FLOOR EL. 744.00 DEMOLITION PHOTOGRAPH PS5-J <small>REFERENCE PLAN PS2-A</small>																																												
<table border="1"> <thead> <tr> <th>Date:</th> <th>Revisions</th> <th>Date</th> <th>Revisions</th> <th>Date</th> <th>Revisions</th> </tr> </thead> <tbody> <tr> <td>5/17/2 CHAMPELL RUN ROAD</td> <td></td> <td></td> <td></td> <td></td> <td></td> </tr> <tr> <td>PS11-A</td> <td></td> <td></td> <td></td> <td></td> <td></td> </tr> <tr> <td>PHOTO: 4-17-2004-2010</td> <td></td> <td></td> <td></td> <td></td> <td></td> </tr> <tr> <td>PHONE: 412-249-4214-88</td> <td></td> <td></td> <td></td> <td></td> <td></td> </tr> <tr> <td>FAX: 412-249-4214-88</td> <td></td> <td></td> <td></td> <td></td> <td></td> </tr> <tr> <td>INFO@KLNENGINEERS.COM</td> <td></td> <td></td> <td></td> <td></td> <td></td> </tr> </tbody> </table>						Date:	Revisions	Date	Revisions	Date	Revisions	5/17/2 CHAMPELL RUN ROAD						PS11-A						PHOTO: 4-17-2004-2010						PHONE: 412-249-4214-88						FAX: 412-249-4214-88						INFO@KLNENGINEERS.COM					
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Scale: As Shown Date: July 2004 Drawn By: MNC Checked By: HOF Approved By: SHG Sheet No.: 6 Drawing No.: 220- PS5																																															
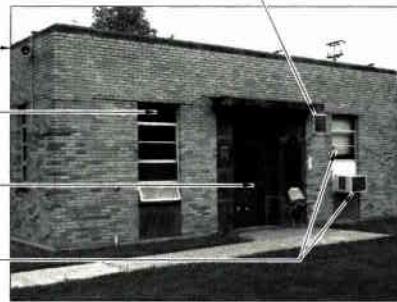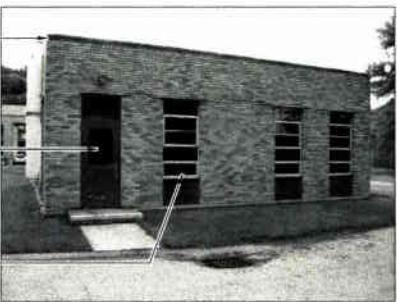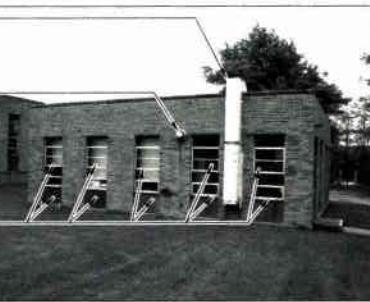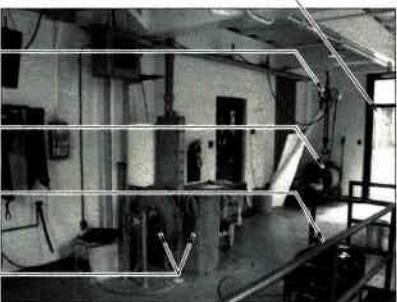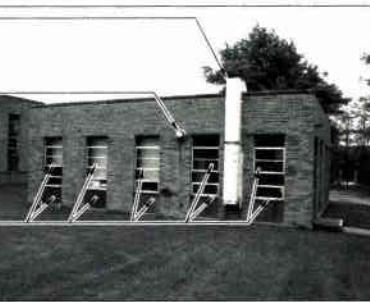
<div style="text-align: right; margin-bottom: 10px;"> <small>REMOVE Cabinets See Demolition Drawing</small> <small>REMOVE Existing Paneling</small> </div>  <p>W.W.T.P. PUMP STATION FLOOR EL. 744.00 DEMOLITION PHOTOGRAPH PS6-A REFERENCE PLAN PS2-A</p>	<div style="text-align: right; margin-bottom: 10px;"> <small>REMOVE Reef Room, Inclusive of All Water Lines, Drain Lines, Tubs, Showers, Bathtubs, Sink Furniture, and Building Interior Walls as Identified in the Contract Drawings.</small> </div>  <p>W.W.T.P. PUMP STATION FLOOR EL. 744.00 DEMOLITION PHOTOGRAPH PS6-B REFERENCE PLAN PS2-A</p>	<div style="text-align: right; margin-bottom: 10px;"> <small>REMOVE Shower Room Inclusive of All Water Lines, Drain Lines, Plumbing Fixtures, and Building Interior Walls as Identified in the Contract Drawings.</small> </div>  <p>W.W.T.P. PUMP STATION FLOOR EL. 744.00 DEMOLITION PHOTOGRAPH PS6-C REFERENCE PLAN PS2-A</p>
<small>6173 CAMPBELL RUN ROAD PITTSBURGH, PA 15236 PHONE: 412-284-4250 FAX: 412-284-4256 INFO@KLHENGINEERS.COM</small>		
KLH ENGINEERS, INC.		
<div style="text-align: right; margin-bottom: 10px;"> <small>Existing Duct</small> <small>REMOVE Railing Around Floor Opening</small> <small>CUT WALL See Demolition Drawings</small> </div>  <p>W.W.T.P. PUMP STATION (DRY WELL) FLOOR EL. 731.29 DEMOLITION PHOTOGRAPH PS6-D REFERENCE PLAN PS2-A</p>	<div style="text-align: right; margin-bottom: 10px;"> <small>Existing Electric Junction Box</small> <small>Existing Electric Conduits</small> <small>Existing Gas Fired Water Heater</small> <small>Existing Water & Heater Gas Supply</small> </div>  <p>W.W.T.P. PUMP STATION (DRY WELL) FLOOR EL. 731.29 DEMOLITION PHOTOGRAPH PS6-E REFERENCE PLAN PS2-A</p>	<div style="text-align: right; margin-bottom: 10px;"> <small>REMOVE Drain Pipe</small> <small>REMOVE Drain Pipe SEAL PENETRATIONS WITH NON SHRINK GROUT.</small> <small>Existing Electric Conduits</small> <small>Existing Electric Junction Box</small> </div>  <p>W.W.T.P. PUMP STATION (DRY WELL) FLOOR EL. 731.29 DEMOLITION PHOTOGRAPH PS6-F REFERENCE PLAN PS2-A</p>
<div style="text-align: right; margin-bottom: 10px;"> <small>Existing Electric Junction Box</small> <small>REMOVE Pump Motor, Shaft and Pump Base and All Pump Controls. (Typ. for 4)</small> </div>  <p>W.W.T.P. PUMP STATION (DRY WELL) FLOOR EL. 718.59 DEMOLITION PHOTOGRAPH PS6-G REFERENCE PLAN PS3-A</p>	<div style="text-align: right; margin-bottom: 10px;"> <small>Existing Unit Heater</small> <small>REMOVE Constant Level Tank and Pump, Controls, Cables and Conduits.</small> <small>REMOVE Pump Motors (Typ. for 4)</small> </div>  <p>W.W.T.P. PUMP STATION (DRY WELL) FLOOR EL. 718.59 DEMOLITION PHOTOGRAPH PS6-H REFERENCE PLAN PS3-A</p>	<div style="text-align: right; margin-bottom: 10px;"> <small>REMOVE Constant Level Tank and Pump, Controls, Cables and Conduits.</small> </div>  <p>W.W.T.P. PUMP STATION (DRY WELL) FLOOR EL. 718.59 DEMOLITION PHOTOGRAPH PS6-J REFERENCE PLAN PS3-A</p>
<small>Scale: As Drawn Date: 4/6/2000 Drawn By: MKE Checked By: HOF Approved By: SHG</small>		
<small>NOTE: ITEMS IDENTIFIED WITH UPPERCASE TEXT ARE PROPOSED. Items Identified with Mixed Case Text are Existing.</small>		
<small>Drawing No. 220- PS6</small>		

W.W.T.P. PUMP STATION (WET WELL) FLOOR EL. 731.29 DEMOLITION PHOTOGRAPH PS7-A						
REFERENCE PLAN PS2-A						
REMOVE AND RELOCATE 2" Natural Gas to Boiler And Water Heater SEAL WALL PENETRATIONS WITH NON SHRINK GROUT.						
EXISTING NATURAL GAS AT BOILER ROOM FLOOR SHALL BE CONNECTED TO NEW 2" GAS SERVICE. SEE DRAWING 220-YPS1						
Existing Hot Water - Heat Supply and Return						
REMOVE Gas Pipe Support						
REMOVE AND RELOCATE 2" Natural Gas Service SEAL WALL PENETRATION WITH NON SHRINK GROUT						
Existing 18" Dia. Air Vent from Wet Well						
W.W.T.P. PUMP STATION (WET WELL) FLOOR EL. 731.29 DEMOLITION PHOTOGRAPH PS7-A						
REFERENCE PLAN PS2-A						
Existing 18" Dia. Air Vent from Wet Well						
RELOCATE Unit Heater						
RELOCATE Thermostat						
REMOVE Steps						
REMOVE Handrail						
REMOVE Stair Landing						
W.W.T.P. PUMP STATION (WET WELL) FLOOR EL. 731.29 DEMOLITION PHOTOGRAPH PS7-B						
REFERENCE PLAN PS2-B						
Existing Hose Bib						
REMOVE Chain SEAL PENETRATIONS WITH NON SHRINK GROUT.						
W.W.T.P. PUMP STATION (WET WELL) FLOOR EL. 731.29 DEMOLITION PHOTOGRAPH PS7-C						
REFERENCE PLAN PS2-C						
Existing 18" Dia. Air Vent from Wet Well						
REMOVE 6" Counterweight Tube Guide SEAL PENETRATIONS WITH NON SHRINK GROUT.						
Existing 18" Dia. Air Vent from Wet Well						
RELOCATE Unit Heater						
RELOCATE Thermostat						
REMOVE Steps						
REMOVE Handrail						
REMOVE Stair Landing						
W.W.T.P. PUMP STATION (PUMP ROOM) FLOOR EL. 706.00 DEMOLITION PHOTOGRAPH PS7-D						
REFERENCE PLAN PS3-A						
Existing 4" C.I. Drain						
REMOVE Chain SEAL PENETRATIONS WITH NON SHRINK GROUT.						
Existing Steel Pipe - Gate / Railing						
REMOVE Existing Float Control SEAL PENETRATIONS WITH NON SHRINK GROUT						
Existing Bar Screen						
W.W.T.P. PUMP STATION (PUMP ROOM) FLOOR EL. 706.00 DEMOLITION PHOTOGRAPH PS7-E						
REFERENCE PLAN PS3-B						
REMOVE Check Valve (Typ.)						
REMOVE AND REPLACE Pump Discharge 16" Plug Valve (Typ.)						
REMOVE 16" Bend						
REMOVE Existing Pump Suction 16" Plug Valve (Typ.)						
REMOVE Raw Sewage Pump, Pump Shaft, Pump Base (Typ. for 4)						
REMOVE Raw Sewage Pump, Pump Shaft, Pump Base (Typ. for 4)						
REMOVE Existing 16" Plug Valve (Typ.)						
REMOVE Existing 16" C.I. Pump Section (Typ.)						
W.W.T.P. PUMP STATION (PUMP ROOM) FLOOR EL. 706.00 DEMOLITION PHOTOGRAPH PS7-F						
REFERENCE PLAN PS3-B						
REMOVE Existing Pump						
Existing Channels - TO REMAIN						
REMOVE All Header Piping						
REMOVE Existing Check Valve						
REMOVE Existing 16" Bend						
REMOVE Existing Pipe Support						
REMOVE Existing Sump Pump						
REMOVE Air Plug Valves (Typ.)						
REMOVE OR REUSE Existing 16" Spool As Required						
Existing 18" Spool As Required						
W.W.T.P. PUMP STATION (PUMP ROOM) FLOOR EL. 718.59 DEMOLITION PHOTOGRAPH PS7-G						
REFERENCE PLAN PS3-A						
Existing 18" Spool As Required						
REMOVE 30° D.I. Base 90° Bend						
REMOVE 30"X30"X16" Tee						
Existing Channel TO REMAIN Modify As Required for Blocking						
REMOVE Existing 16" Bend						
REMOVE 16" Plug Valve						
REMOVE 16" Check Valve						
REMOVE Existing Pump						
W.W.T.P. PUMP STATION (PUMP ROOM) FLOOR EL. 718.59 DEMOLITION PHOTOGRAPH PS7-H						
REFERENCE PLAN PS3-A						
Existing 18" Spool As Required						
REMOVE Contractor Staff Modify Pipe As Required To Accommodate New Centerlines						
REMOVE AND REINSTALL As Required to Accommodate New Pipe Centerlines						
REMOVE Existing 30° Base 90° Elbow						
REMOVE Concrete Pipe Support						
W.W.T.P. PUMP STATION (PUMP ROOM) FLOOR EL. 718.59 DEMOLITION PHOTOGRAPH PS7-J						
REFERENCE PLAN PS3-A						
Existing 18" Spool As Required						
NOTE: ITEMS IDENTIFIED WITH UPPER CASE TEXT ARE PROPOSED. Items Identified with Mixed Case Text are Existing.						
MUNICIPAL AUTHORITY OF THE CITY OF MCKEEESPORT ALLEGHENY COUNTY, PENNSYLVANIA CONTRACT NUMBER 2010-C1 and 2010-C2 WASTEWATER TREATMENT PLANT EXPANSION PUMP STATION DEMOLITION PHOTOGRAPH PS7-K						
REFERENCE PLAN PS3-A						
Sheet No.: 8	Date: July 2010	Drawn By: MEC	Checked By: HOP	Approved By: SHB	Revisions:	Revisions:
Drawing No.: 220-PST7	DEP SUBMITTAL	10-09	RELEASE FOR BID			
	Phone: 412-444-0130	Fax: 412-444-0130				
	E-mail: info@klhengineers.com					

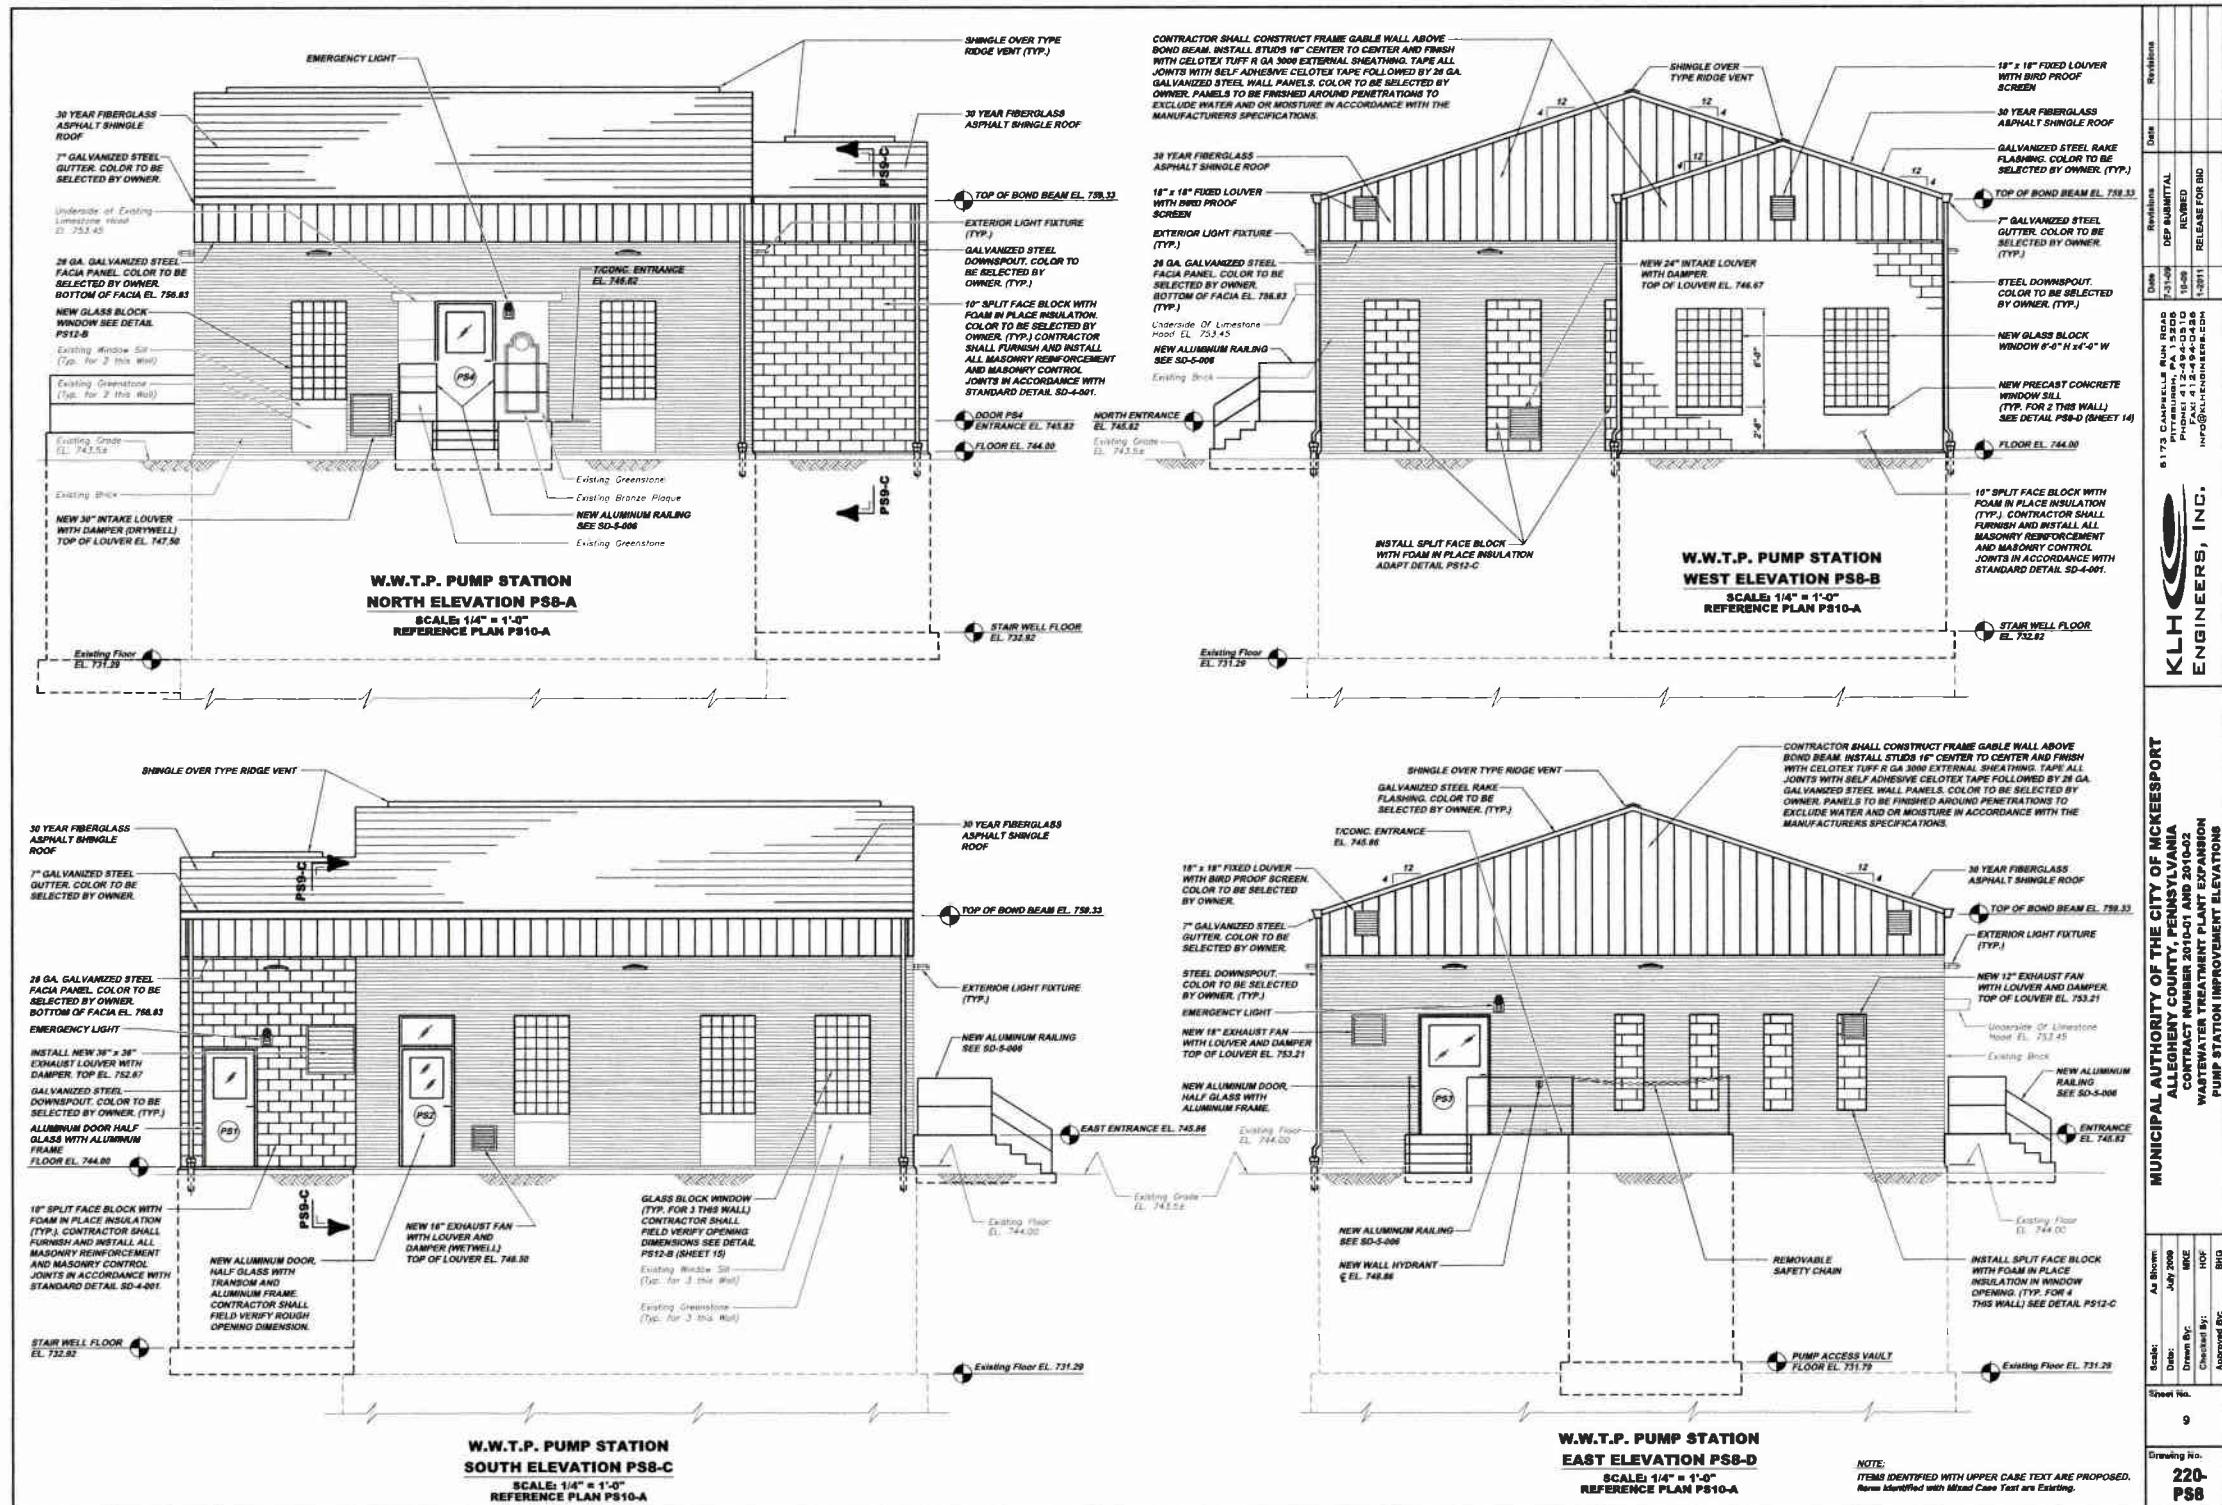

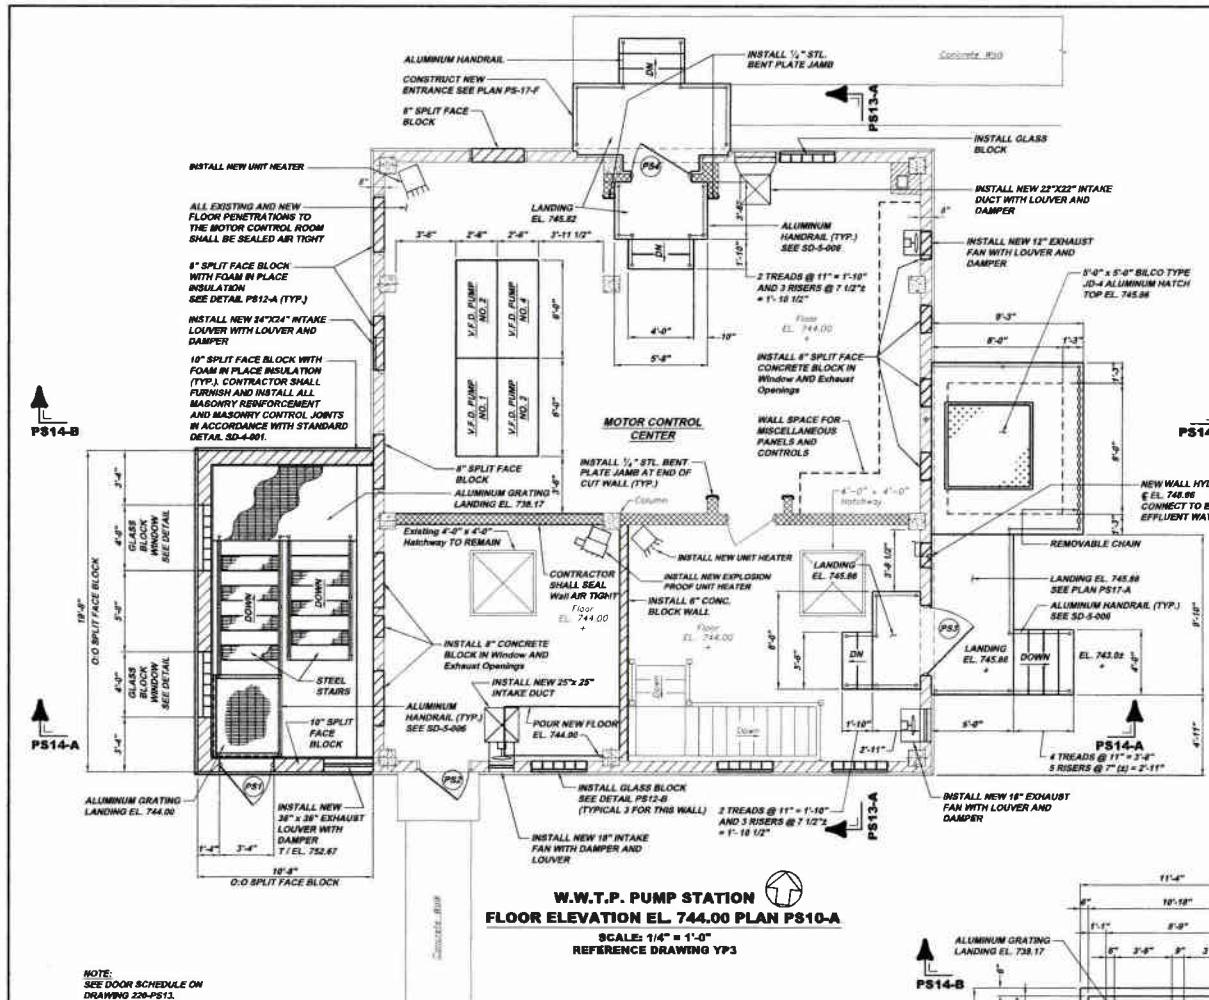


W.W.T.P. PUMP STATION FLOOR ELEVATION EL. 744.00 PLAN PS10-A

SCALE: 1/4" = 1'-0"
REFERENCE DRAWING Y

NOTE:
SEE DOOR SCHEDULE ON
DRAWING 220-PS11.


NOTE:
CONTRACTOR SHALL SEAL AIR TIGHT ALL
DEMOLITION PENETRATIONS, EXISTING AND NEW
PIPE PENETRATIONS IN CONCRETE BETWEEN
PUMP STATION WET WELL AND PUMP STATION
DRY WELL (TYP. ALL FLOORS).

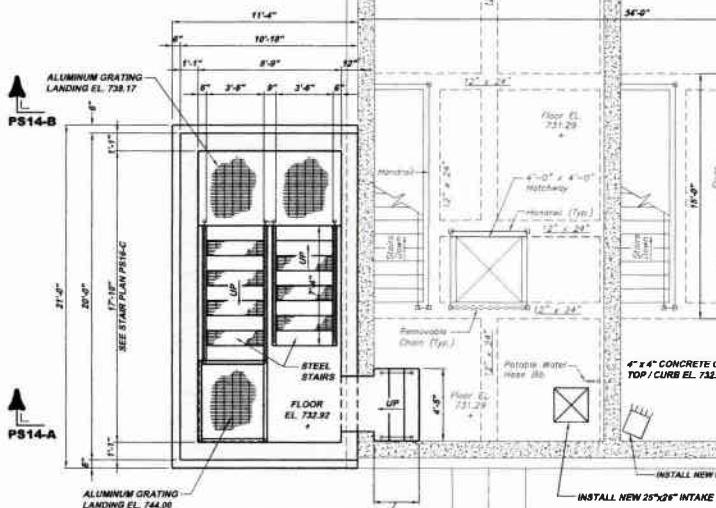

W.W.T.P. PUMP STATION
FLOOR ELEVATION 731.29 PLAN PS1


SCALE: 1/4" = 1'-0"
REFERENCE PLAN PS10-A


NOTE: ITEMS IDENTIFIED WITH UPPER CASE TEXT ARE PROPOSED.

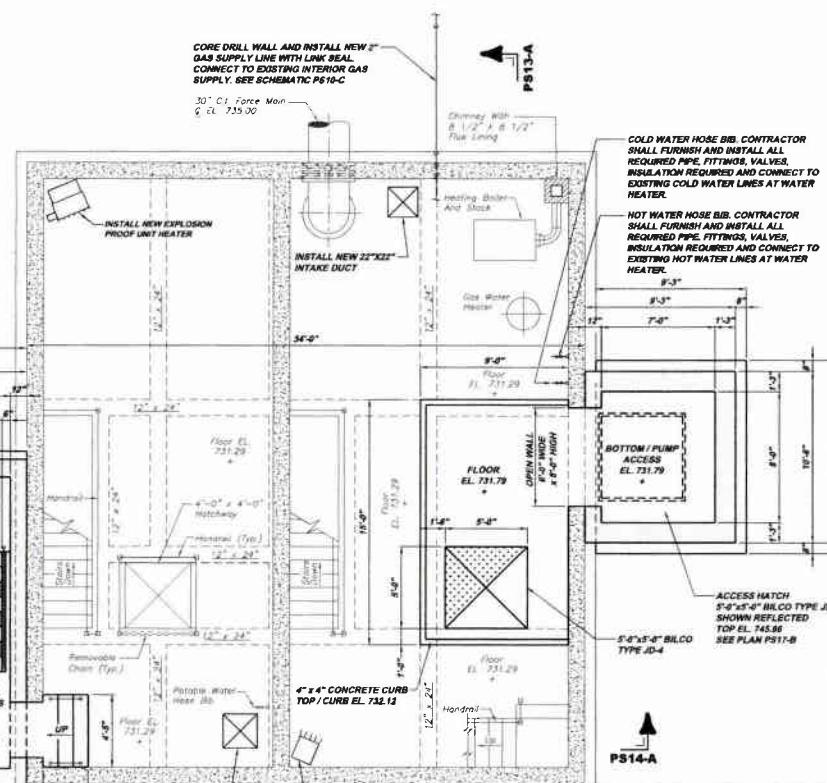


MUNICIPAL AUTHORITY OF THE CITY OF MCKEESPORT
ALLEGIENY COUNTY, PENNSYLVANIA
CONTRACT NUMBER 2010-01 and 2010-02
WASTEWATER TREATMENT PLANT EXPANSION
PUMP STATION IMPROVEMENT PLANS


	Revisions
	Date REBILLED 07-16-06 REFILED 11-20-06 REWORKED 01-22-07 RELEASE FOR BID 01-23-07 INFO@KLHENGINEERS.COM

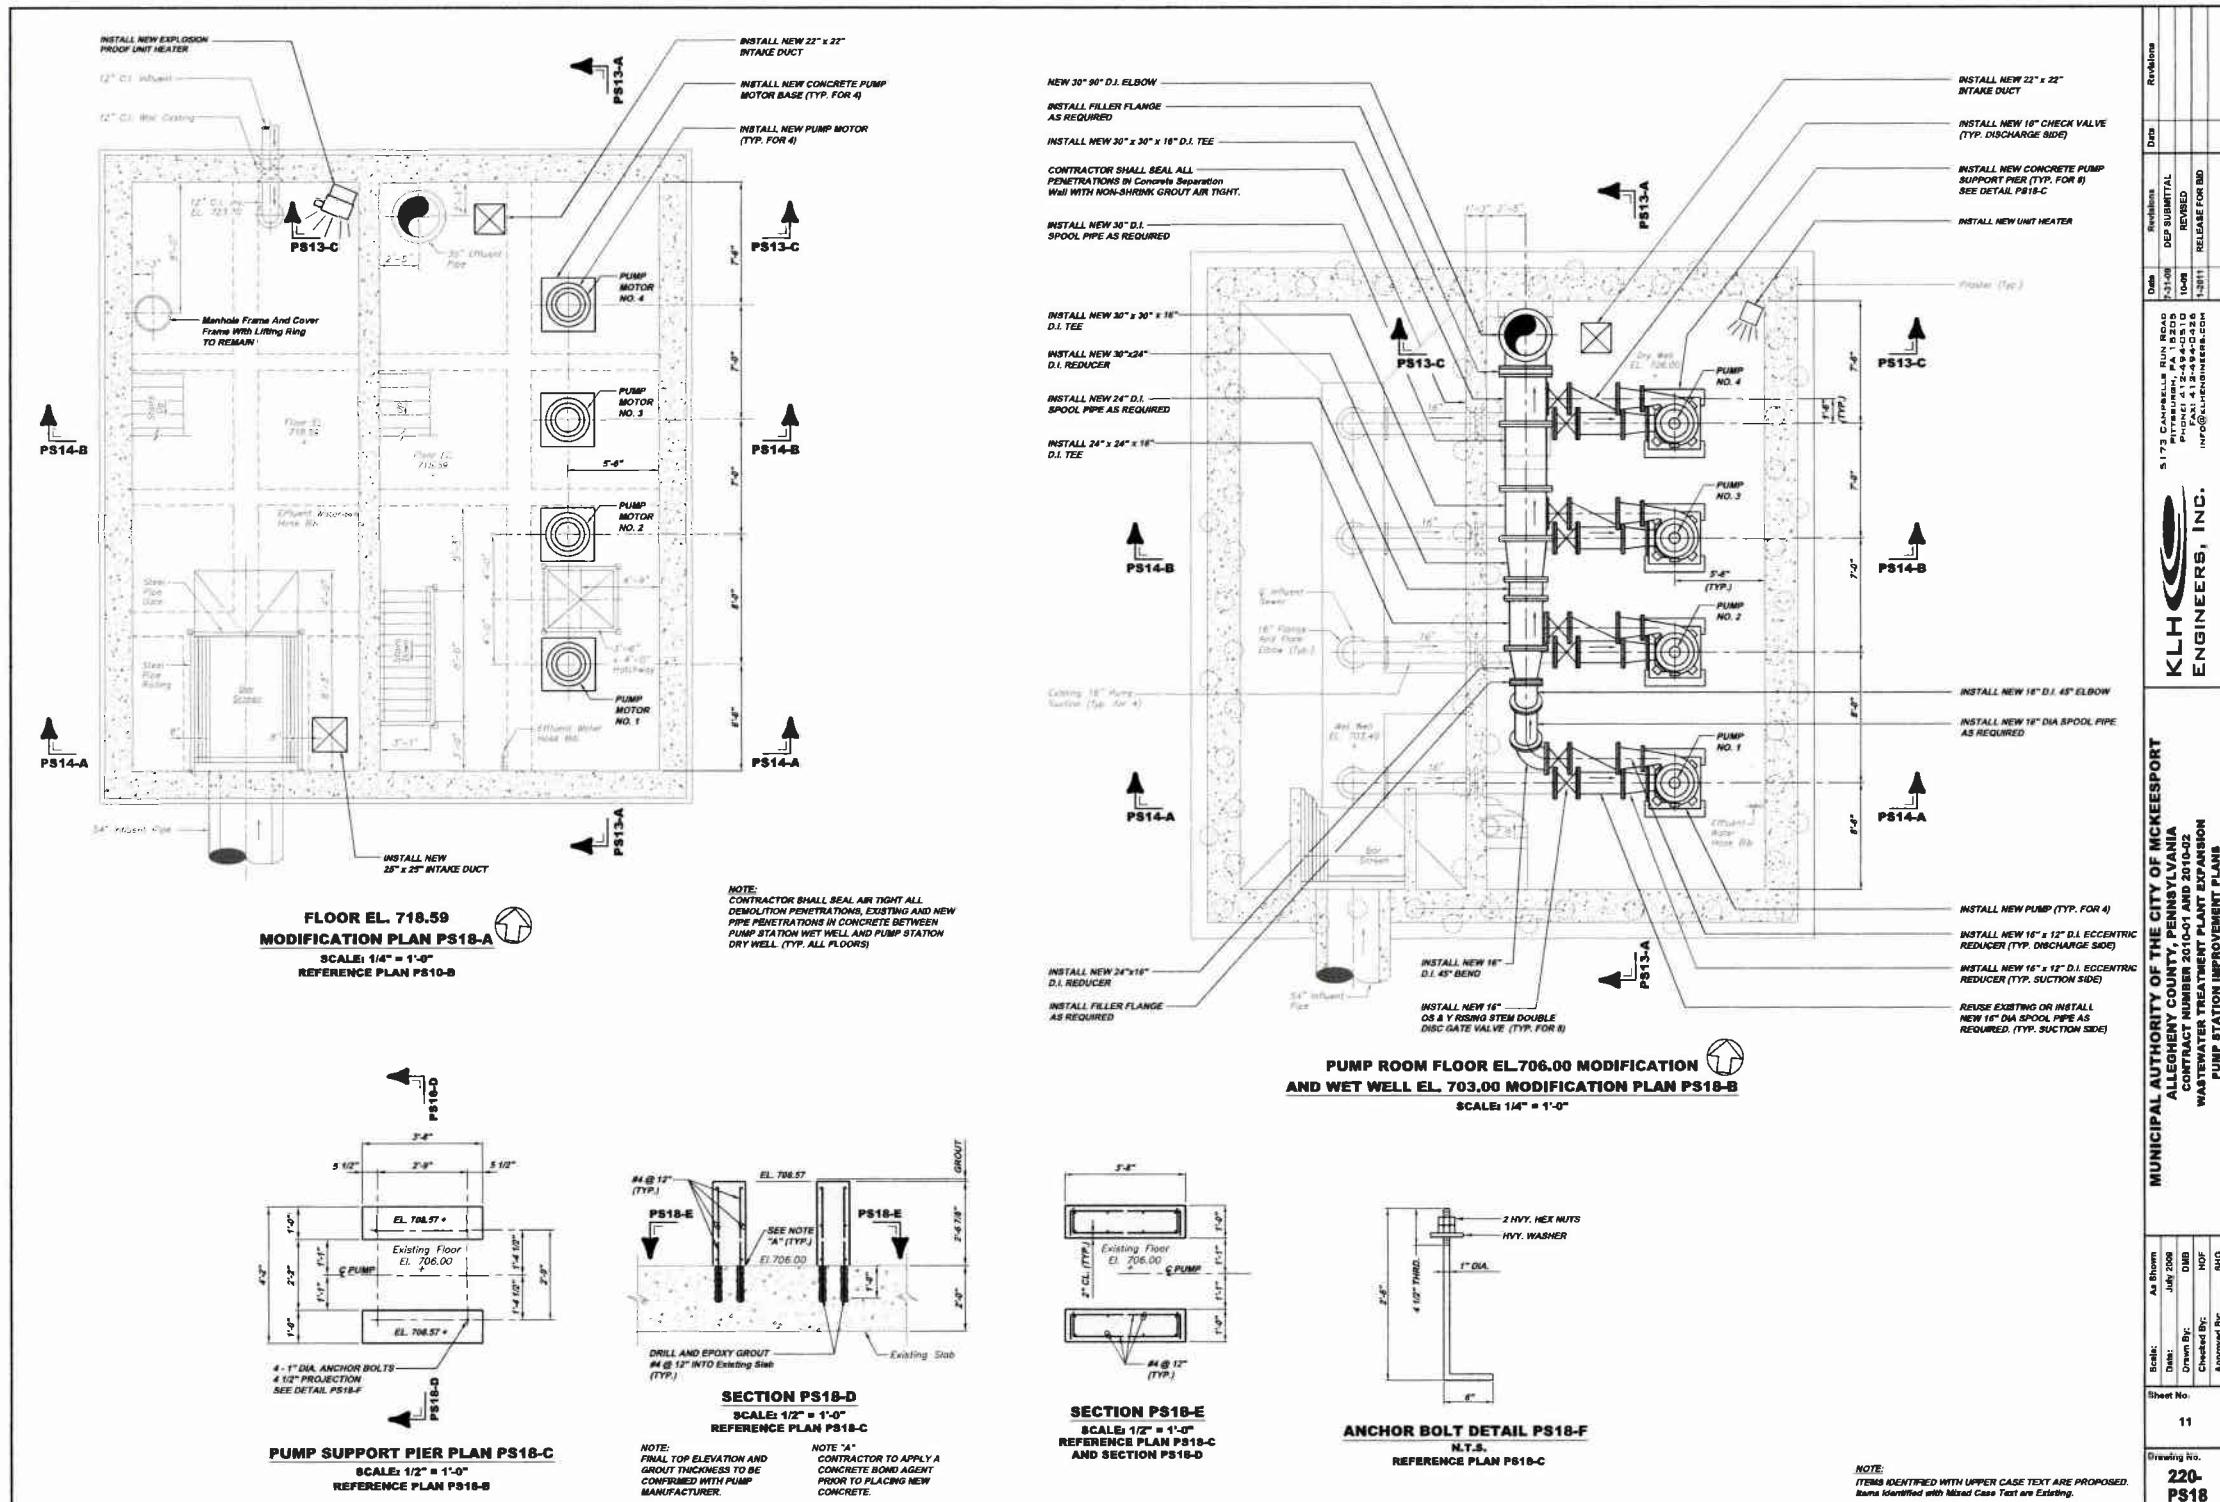

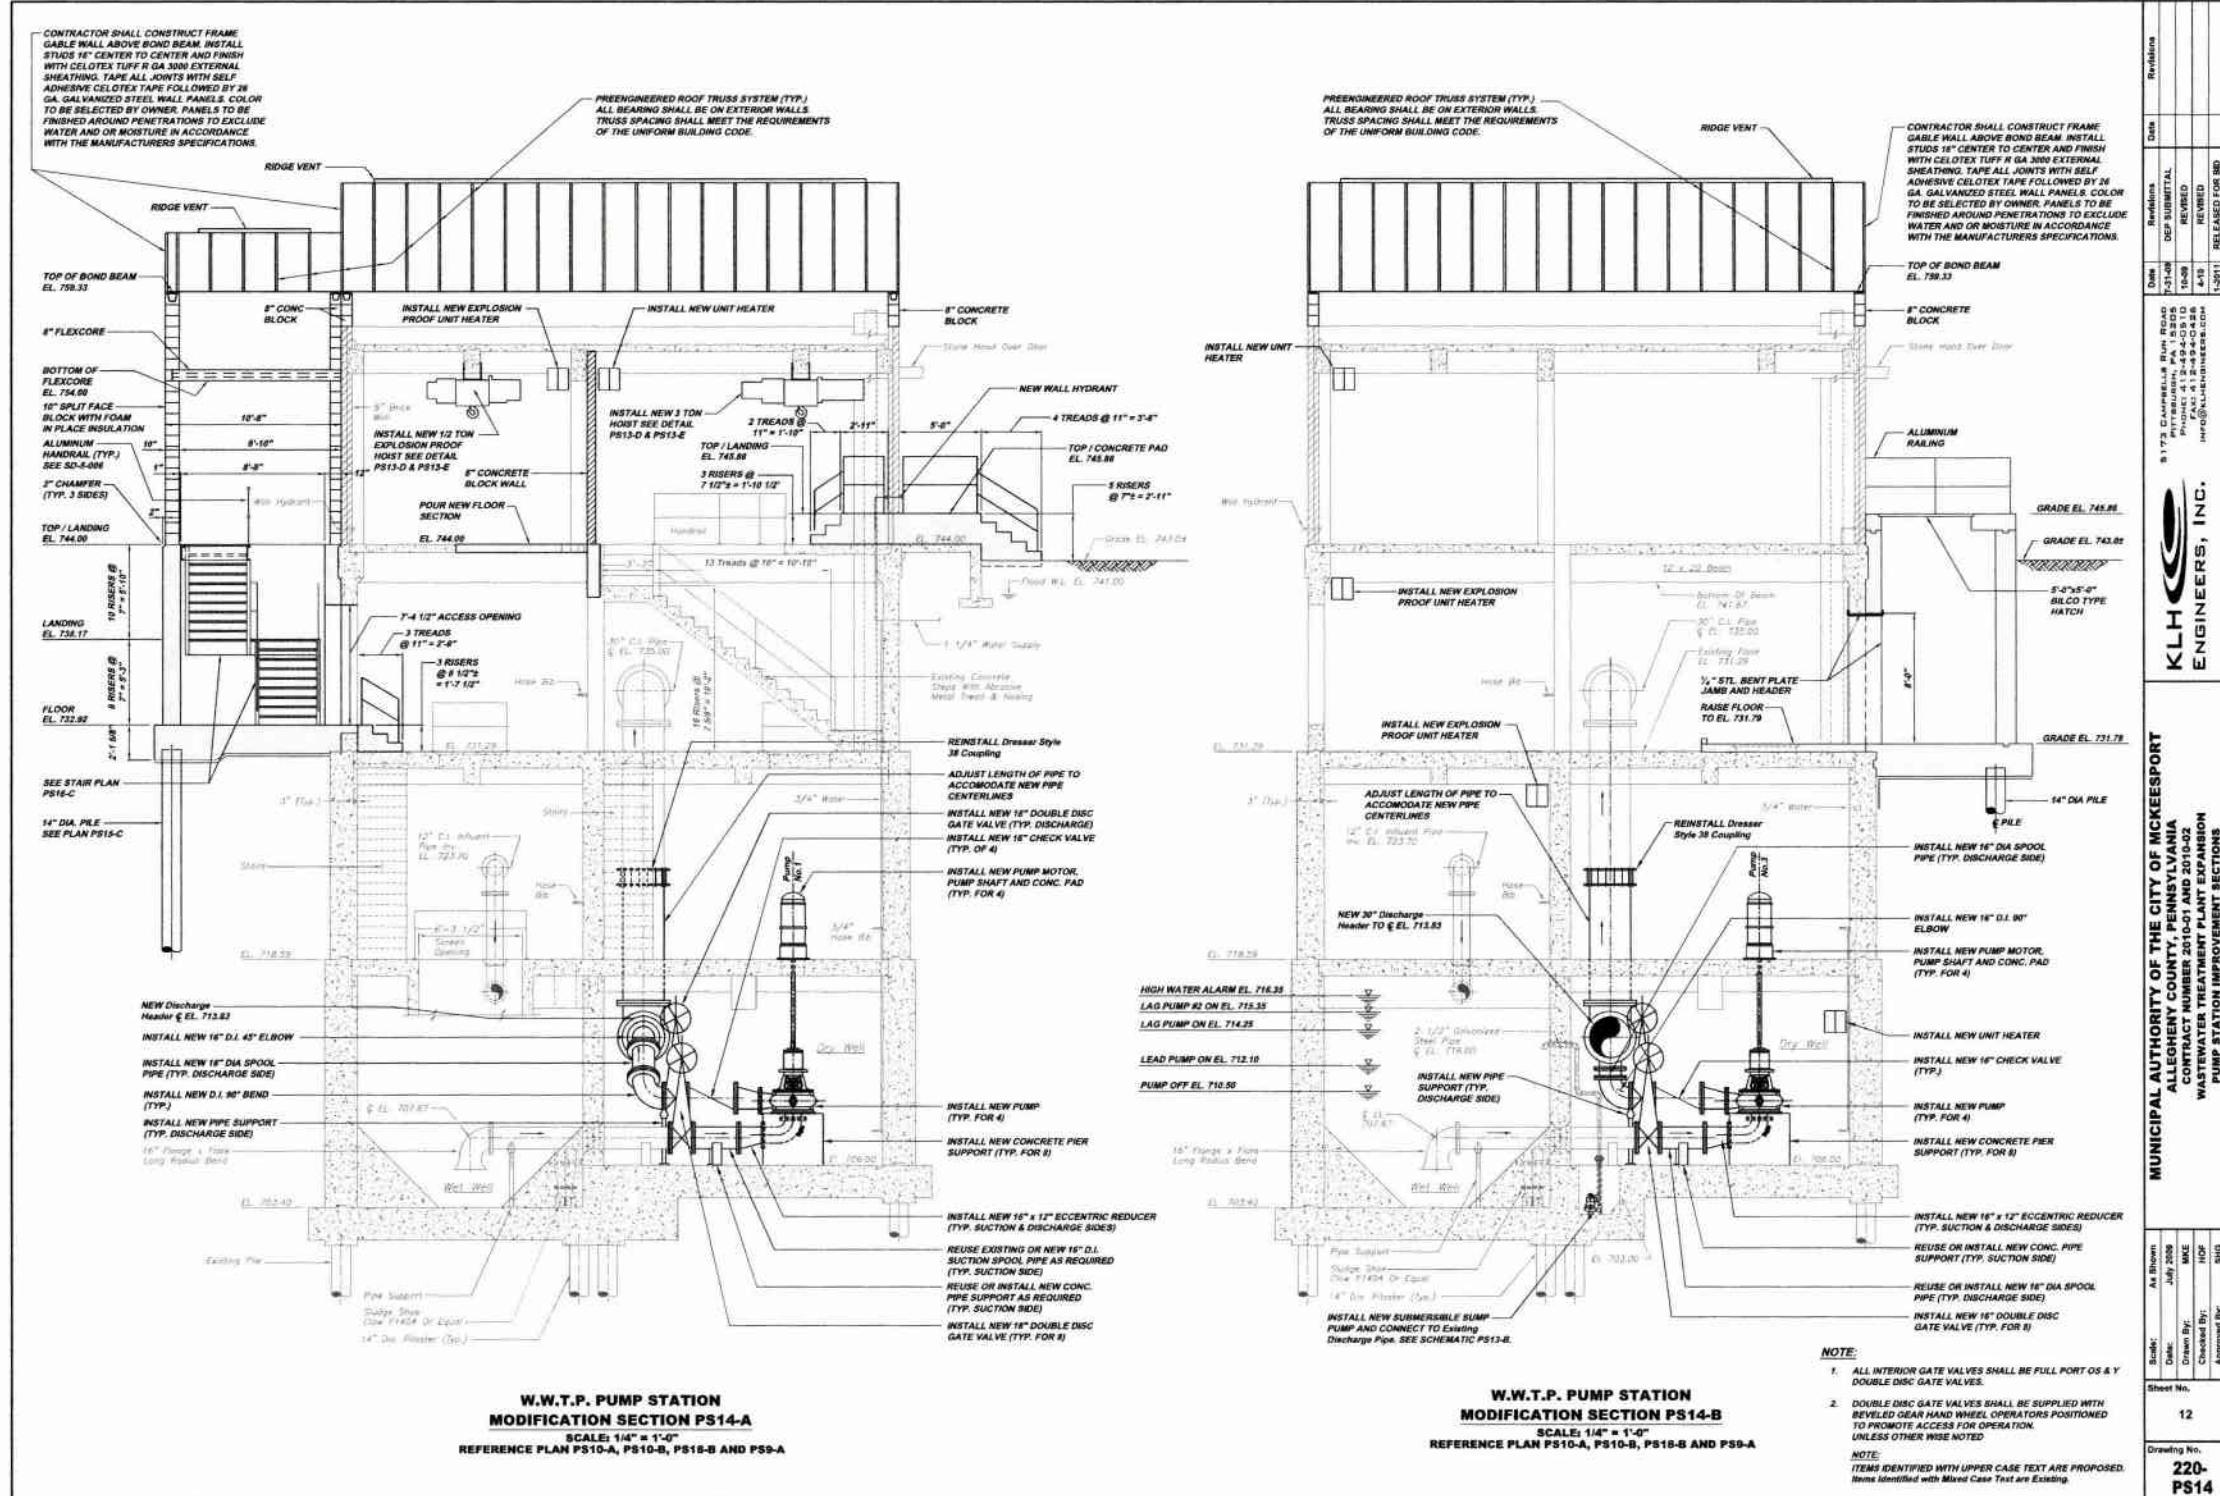


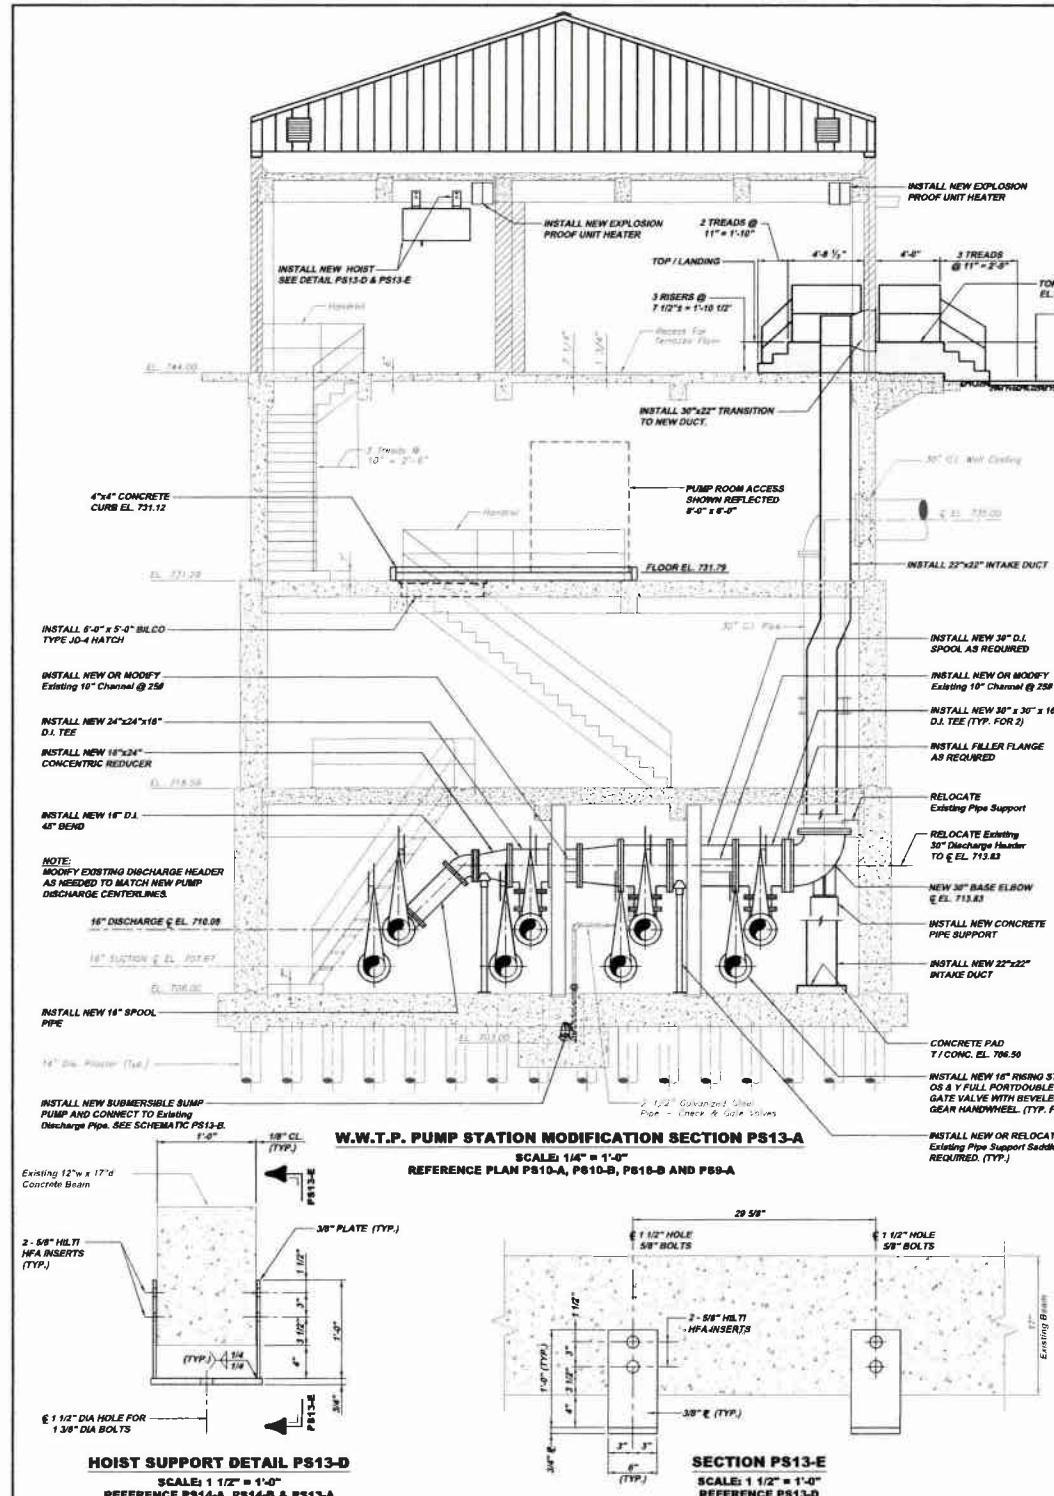


WWTP PUMP STATION DOOR SCHEDULE (ALL HARDWARE US 32 FINISH)									
MARK	LOCATION	DOOR DESCRIPTION	DIMENSIONS (INCHES) (ROUND TO NEAREST 1/4 INCHES)	LOCKSET (BARSET) (FINISH US 32)	HINGE (FINISH US 32)	CLOSER (LCN)	THRESHOLD (NATIONAL GUARD)	INCRAPEL (ROCK GUARD)	WEATHER STRIP (NATIONAL GUARD)
PS1	EXTERIOR SOUTH WALL WELL WELL ACCESS	CLINE INSULATED ALUMINUM DOOR WITH ALUMINUM FRAME, DOOR PANEL 3'-6" x 7'-0" WITH HALF GLASS	3'-4" x 7'-4"	MORTISE PANIC TYPE EXIT DEVICE SERIES 9900 WITH ETL TRIM	MCKINNEY STAINLESS STEEL CONTINUOUS TYPE (HEAVY DUTY RATED)	1488 ADA COMPLIMENT EACH PANEL	425	10" HIGH x .050"	160 SDKB PERIMETER SEAL 101 VONG SWEEP
PS2	EXTERIOR SOUTH WALL ACCESS	CLINE INSULATED ALUMINUM DOOR WITH TRANSOM AND ALUMINUM FRAME, DOOR PANEL 3'-0" x 7'-0" WITH HALF GLASS	VERIFY EXISTING ROUGH OPENING	MORTISE PANIC TYPE EXIT DEVICE SERIES 9900 WITH ETL TRIM	MCKINNEY STAINLESS STEEL CONTINUOUS TYPE (HEAVY DUTY RATED)	1488 ADA COMPLIMENT EACH PANEL	425	10" HIGH x .050"	160 SDKB PERIMETER SEAL 101 VONG SWEEP
PS3	EXTERIOR EAST PUMP ROOM ACCESS	CLINE INSULATED ALUMINUM DOOR WITH ALUMINUM FRAME, DOOR PANEL HALF GLASS 3'-0" x 7'-0"	4'-0" x 7'-4" VERIFY EXISTING ROUGH OPENING	MORTISE PANIC TYPE EXIT DEVICE SERIES 9900 WITH ETL TRIM	MCKINNEY STAINLESS STEEL CONTINUOUS TYPE (HEAVY DUTY RATED)	1488 ADA COMPLIMENT EACH PANEL	425	10" HIGH x .050"	160 SDKB PERIMETER SEAL 101 VONG SWEEP
PS4	EXTERIOR NORTH ELECTRIC ROOM ACCESS	CLINE INSULATED ALUMINUM DOOR WITH ALUMINUM FRAME, DOOR PANEL HALF GLASS 3'-0" x 7'-0"	3'-4" x 7'-4" VERIFY EXISTING ROUGH OPENING	MORTISE PANIC TYPE EXIT DEVICE SERIES 9900 WITH ETL TRIM	MCKINNEY STAINLESS STEEL CONTINUOUS TYPE (HEAVY DUTY RATED)	1488 ADA COMPLIMENT EACH PANEL	425	10" HIGH x .050"	160 SDKB PERIMETER SEAL 101 VONG SWEEP
PS5	ATTIC ACCESS	CECO CORP INSULATED METAL DOOR PANEL WITH 4 SLIDED FRAME 14HR FIRE RATED	3'-4" x 3'-4"	PASSAGE LOCKSET 8215 COMBINATION STRIKE IN FRAME ESCUTCHEON AND LEVER TRIM SERIES 6400 (LAL)	HAGER 1250 4 1/2" x 4 1/2" (2 REOD) SPRING TYPE PRIME COATED	—	—	—	160 SA PERIMETER SEAL

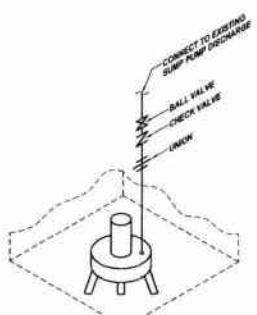


SUMP PUMP SCHEMATIC PS13-B

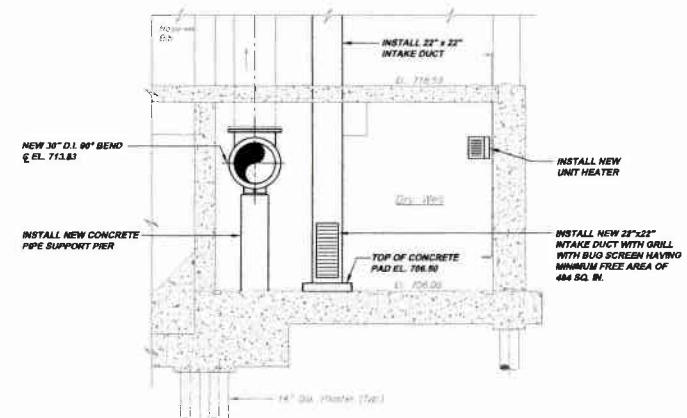

**W.W.T.P. PUMP STATION
MODIFICATION SECTION PS13-C**

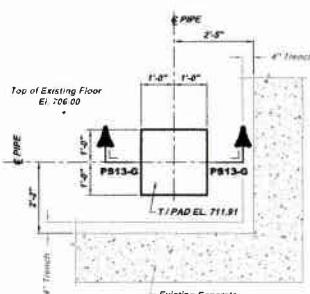


**FOUNDATION PLAN PS13-F
(NEW PUMP SUPPORT)
SCALE: 1/2" = 1'-0"
REFERENCE: PLAN PS13-B**

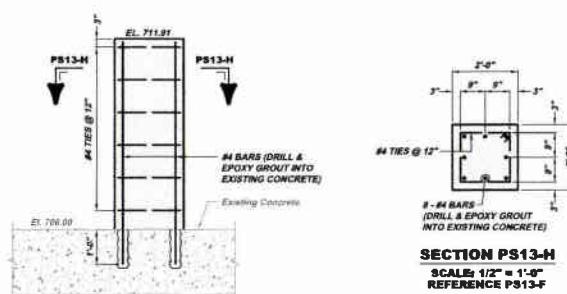

SECTION PS13-G

NOTE:
ITEMS IDENTIFIED WITH UPPER CASE TEXT ARE PROPOSED.
Items Identified with Mixed Case Text are Existing.


MUNICIPAL AUTHORITY OF THE CITY OF MCKEESEPORT		5172 Cambria Rd., Suite 100 Pittsburgh, PA 15236-1100		Date RECEIVED 6-1-04 6-1-04 6-1-04 6-1-04	Revised SUBMITTED REVISED RELEASE FOR BIO
CONTRACT NUMBER 10-01 AND 10-02		PHONE: 412-264-4411 FAX: 412-264-4412 INFO@MCKEEPORTPA.ORG			Oral 6-1-04 6-1-04 6-1-04 6-1-04
WASTEWATER TREATMENT PLANT, DETAILS AND SCHEDULE PUMP STATION IMPROVEMENT SECTIONS, DETAILS AND SCHEDULE					
13		KLH ENGINEERS, INC.			
Drawing No. 220- PS13					

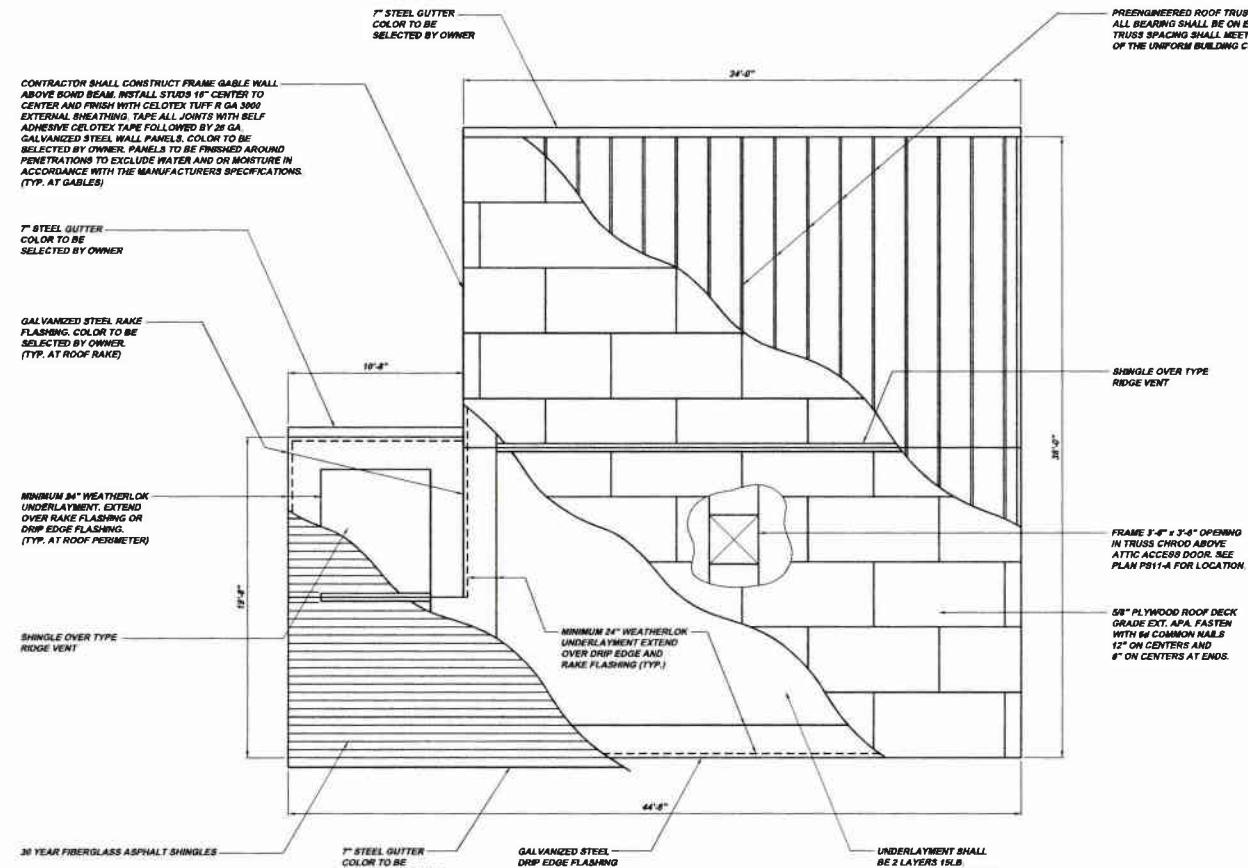

W.W.T.P. PUMP STATION
ROOF PLAN PS9-A




N

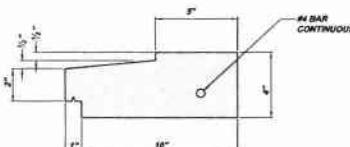

PRECAST CONCRETE SILL DETAIL PS9-D

ROOF DETAIL PS9-B
SCALE: $3/4"$ = $1'-0"$
REFERENCE SECTION PS9-C

SCALE 3/4" = 1-4'
REFERENCE SECTION PAGE

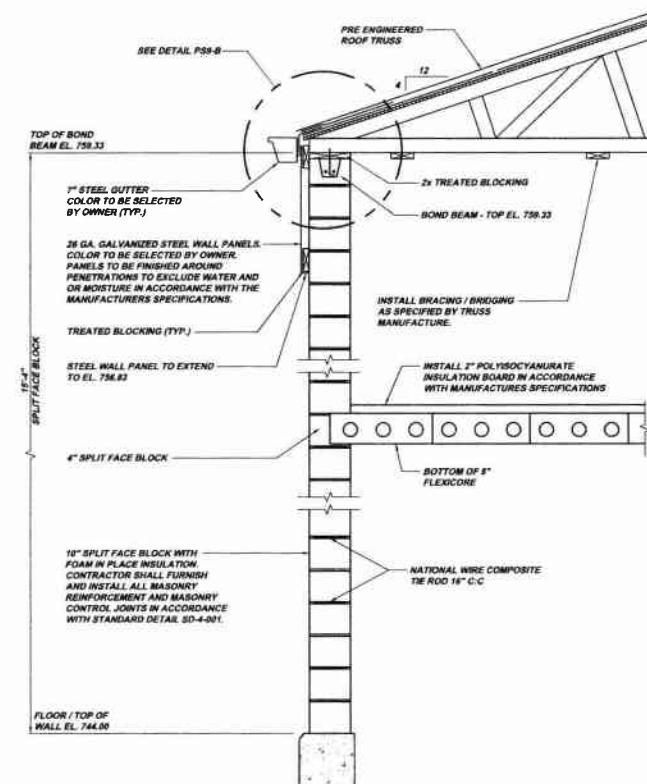


DRY WELL ACCESS TYPICAL WALL SECTION PS9-C

SCALE: 3/4" = 1'-0"

Drawing No. 220- PS9		Sheet No. 14	
MUNICIPAL AUTHORITY OF THE CITY OF MCKEESPORT ALLENTOWN, PENNSYLVANIA CONTRACT NUMBER 2011-C-01 AND 2011-C-02 WASTEWATER TREATMENT PLANT EXPANSION -		5173 CAMBELL RUN ROAD PENNSYLVANIA PHONE: 412-444-0210 FAX: 412-444-0246 E-MAIL: INFO@KLHENGINEERS.COM	
Scale:	As Shown	Date:	06/11/08
Drawn By:	Mike	Revised:	DE- SUBMITTAL
Checked By:	HOF	Approved:	PROVED
Sheet Name:	Markings:		

		Date	Revision	Notes
RESTORATION DETAIL PS12-A SCALE: 1 1/2" = 1'-0" REFERENCE ELEVATION PS6-B		7-10-08 REVISED 10-08 RELEASE FOR BID FAX: 412-444-0238 INFO@KLHENGINEERS.COM		
GLASS BLOCK WINDOW DETAIL PS12-B SCALE: 1 1/2" = 1'-0" REFERENCE ELEVATION PS6-A AND PS6-C				
DETAIL PS12-C SCALE: 1 1/2" = 1'-0" REFERENCE ELEVATION PS6-D				
DOOR NO. PS1 DETAIL PS12-D N.T.S. REFERENCE PLAN PS10-A		5-17-08 PITT&BLAKEY, INC. PH: 412-444-0238 FAX: 412-444-0238 INFO@KLHENGINEERS.COM		
DOOR NO. PS2 DETAIL PS12-E N.T.S. REFERENCE PLAN PS10-A				
DOOR NO. PS4 DETAIL PS12-F N.T.S. REFERENCE PLAN PS10-A				
GLASS BLOCK WINDOW DETAIL PS12-G N.T.S. REFERENCE PLAN PS6-B				
DOOR NO. PS3 DETAIL PS12-H N.T.S. REFERENCE PLAN PS10-A				
MUNICIPAL AUTHORITY OF THE CITY OF MCKEEESPORT ALLENTOWN COUNTY, PENNSYLVANIA CONTRACT NUMBER 2010-01 AND 2010-02 WASTEWATER TREATMENT PLANT EXPANSION PUMP STATION WALL AND WINDOW IMPROVEMENT DETAILS				
Scale: Sheet No. Drawing No.	As Shown Date: Drawn By: Checked By: Approved By:			
15	July 2008 KLH HOF SHQ 15 220- PS12			
NOTE: ITEMS IDENTIFIED WITH UPPERCASE TEXT ARE PROPOSED. Items Identified with Mixed Case Text are Existing.				

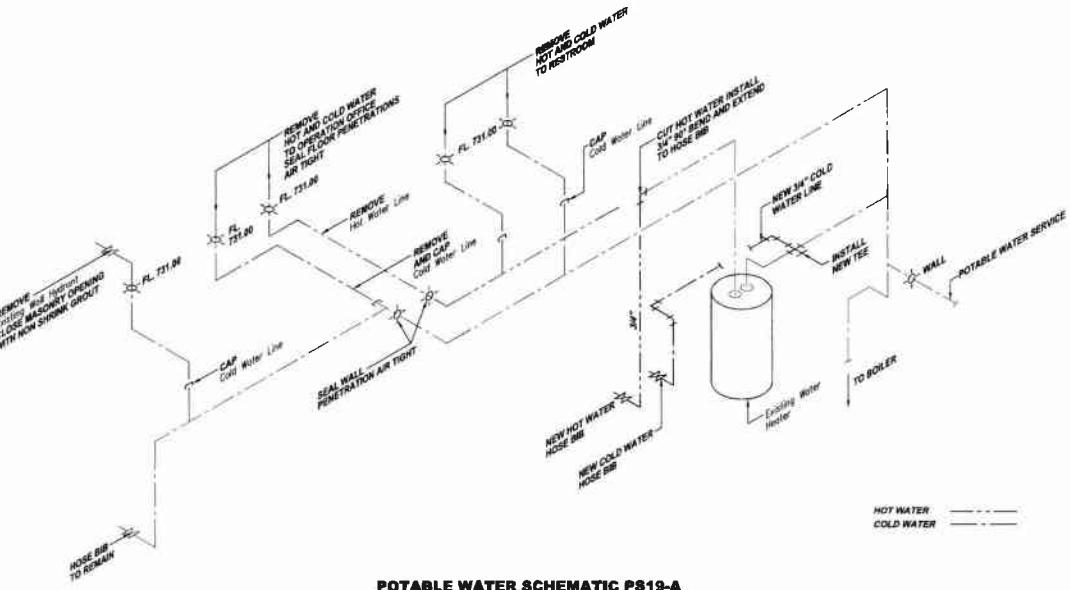

POTABLE WATER SCHEMATIC PS19-A

NLT®





EFFLUENT WATER SCHEMATIC PS19-B

NATURAL GAS SCHEMATIC PS19-C
N.T.S.


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Drawing No.	220- PS19	
Scale:	As Shown	
Date:	July 2008	
Driver By:	DHO	
Checked By:	HOF	
Approved By:	BHO	
MUNICIPAL AUTHORITY OF THE CITY OF MCKEESPORT ALLENTOWN COUNTY, PENNSYLVANIA		
CONTRACT NUMBER 201-001 AND 201-002 WASTEWATER TREATMENT PLANT EXPANSION PUMP STATION SCHEMATIC DIAGRAMS		
 KLH ENGINEERS, INC.		
<p>5-173 Campbells Run Road Pittsburgh, PA 15236 412-246-3200 FAX: 412-246-3205 info@klh-engineers.com</p>		
<p>5-173 Campbells Run Road Pittsburgh, PA 15236 412-246-3200 FAX: 412-246-3205 info@klh-engineers.com</p>		
Date	Revisions	Date
7/3/08	0	REVIEWED 7/3/08 RELEASE FOR BID 7/3/08
Hayline		

NOTE:
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Items Identified with Mixed Case Text are Existing.


Drawing No.
**220-
PS19**

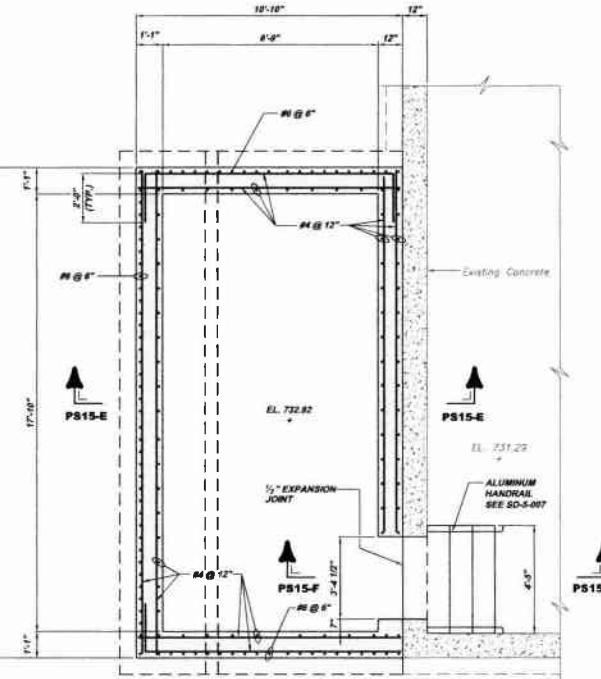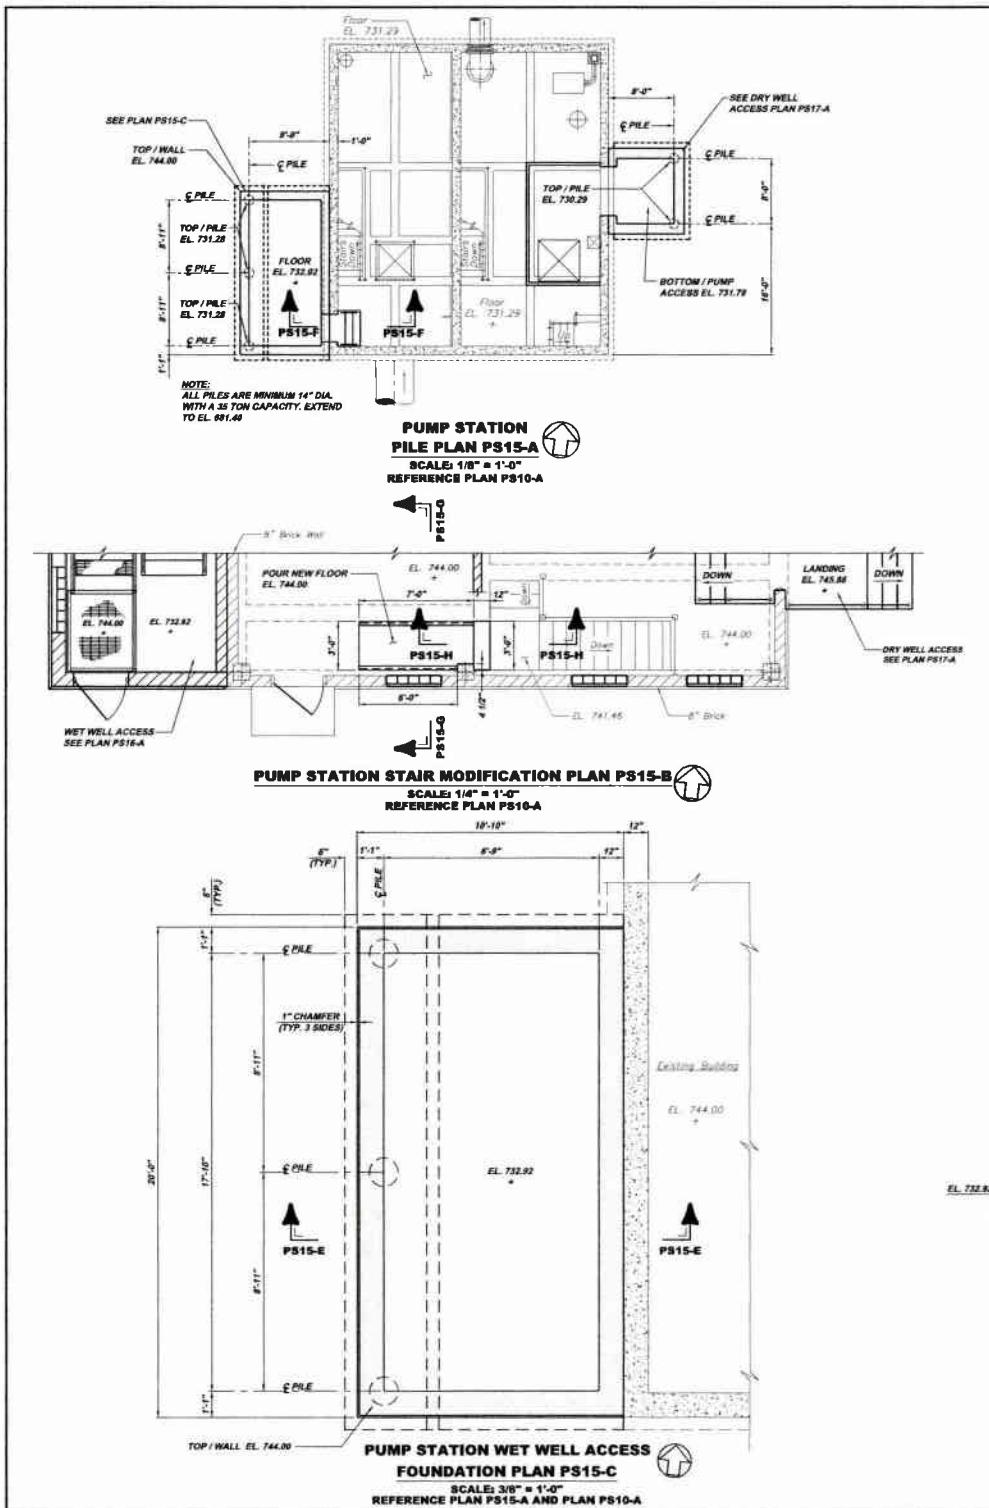


PUMP STATION WET WELL PS15-D
SECTIONAL WALL PLAN
SCALE: 3/8" = 1'-0"
REFERENCE PLANS P818-A AND PLAN PS10-A

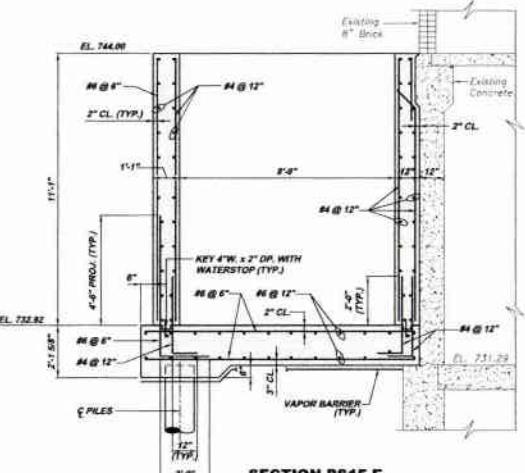


SECTION PS15-E
SCALE: 3/8" = 1'-0"
REFERENCE PLAN PS15-D AND PLAN PS15-C

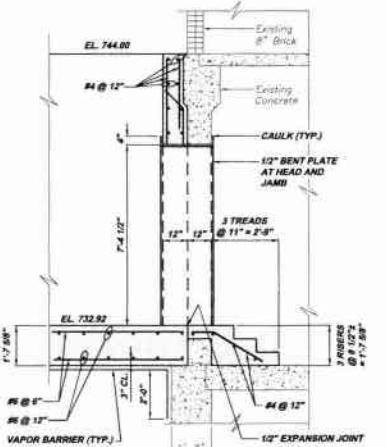

SECTION PS15-F
SCALE: 3/8" = 1'-0"
REFERENCE PLAN PS15-A AND PLAN PS15-D

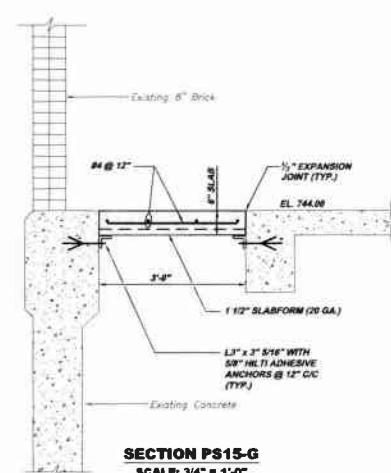



SECTION PS15-G
SCALE: 3/4" = 1'-0"
REFERENCE PLAN PS15-B

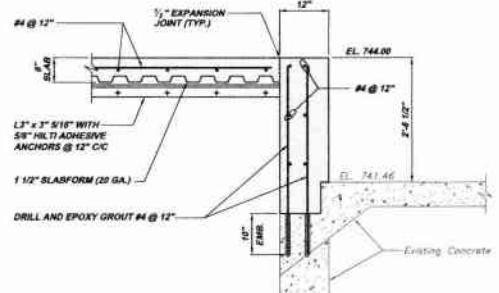



SECTION PS15-H
SCALE 3/4" = 1'-0"
REFERENCE PLAN PS15-B


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Sheet No.							17		
Drawing No. 220-PS15									
MUNICIPAL AUTHORITY OF THE CITY OF MCKEESPORT ALLENTOWN COUNTY, PENNSYLVANIA CONTRACT NUMBER 2010-01 AND 2010-02 WASTEWATER TREATMENT PLANT EXPANSION PUMP STATION STRUCTURAL PLANS, SECTIONS AND DETAILS^a									
 KLH ENGINEERS, INC.									
# 512 CAMPHILL BLD ROAD PITTSBURGH, PA 15210 PHONE: 412-249-0110 FAX: 412-249-0111 E-MAIL: INFO@KLHENGINEERS.COM									
REVISIONS DATE REBUTTAL RELEASE FOR BID									

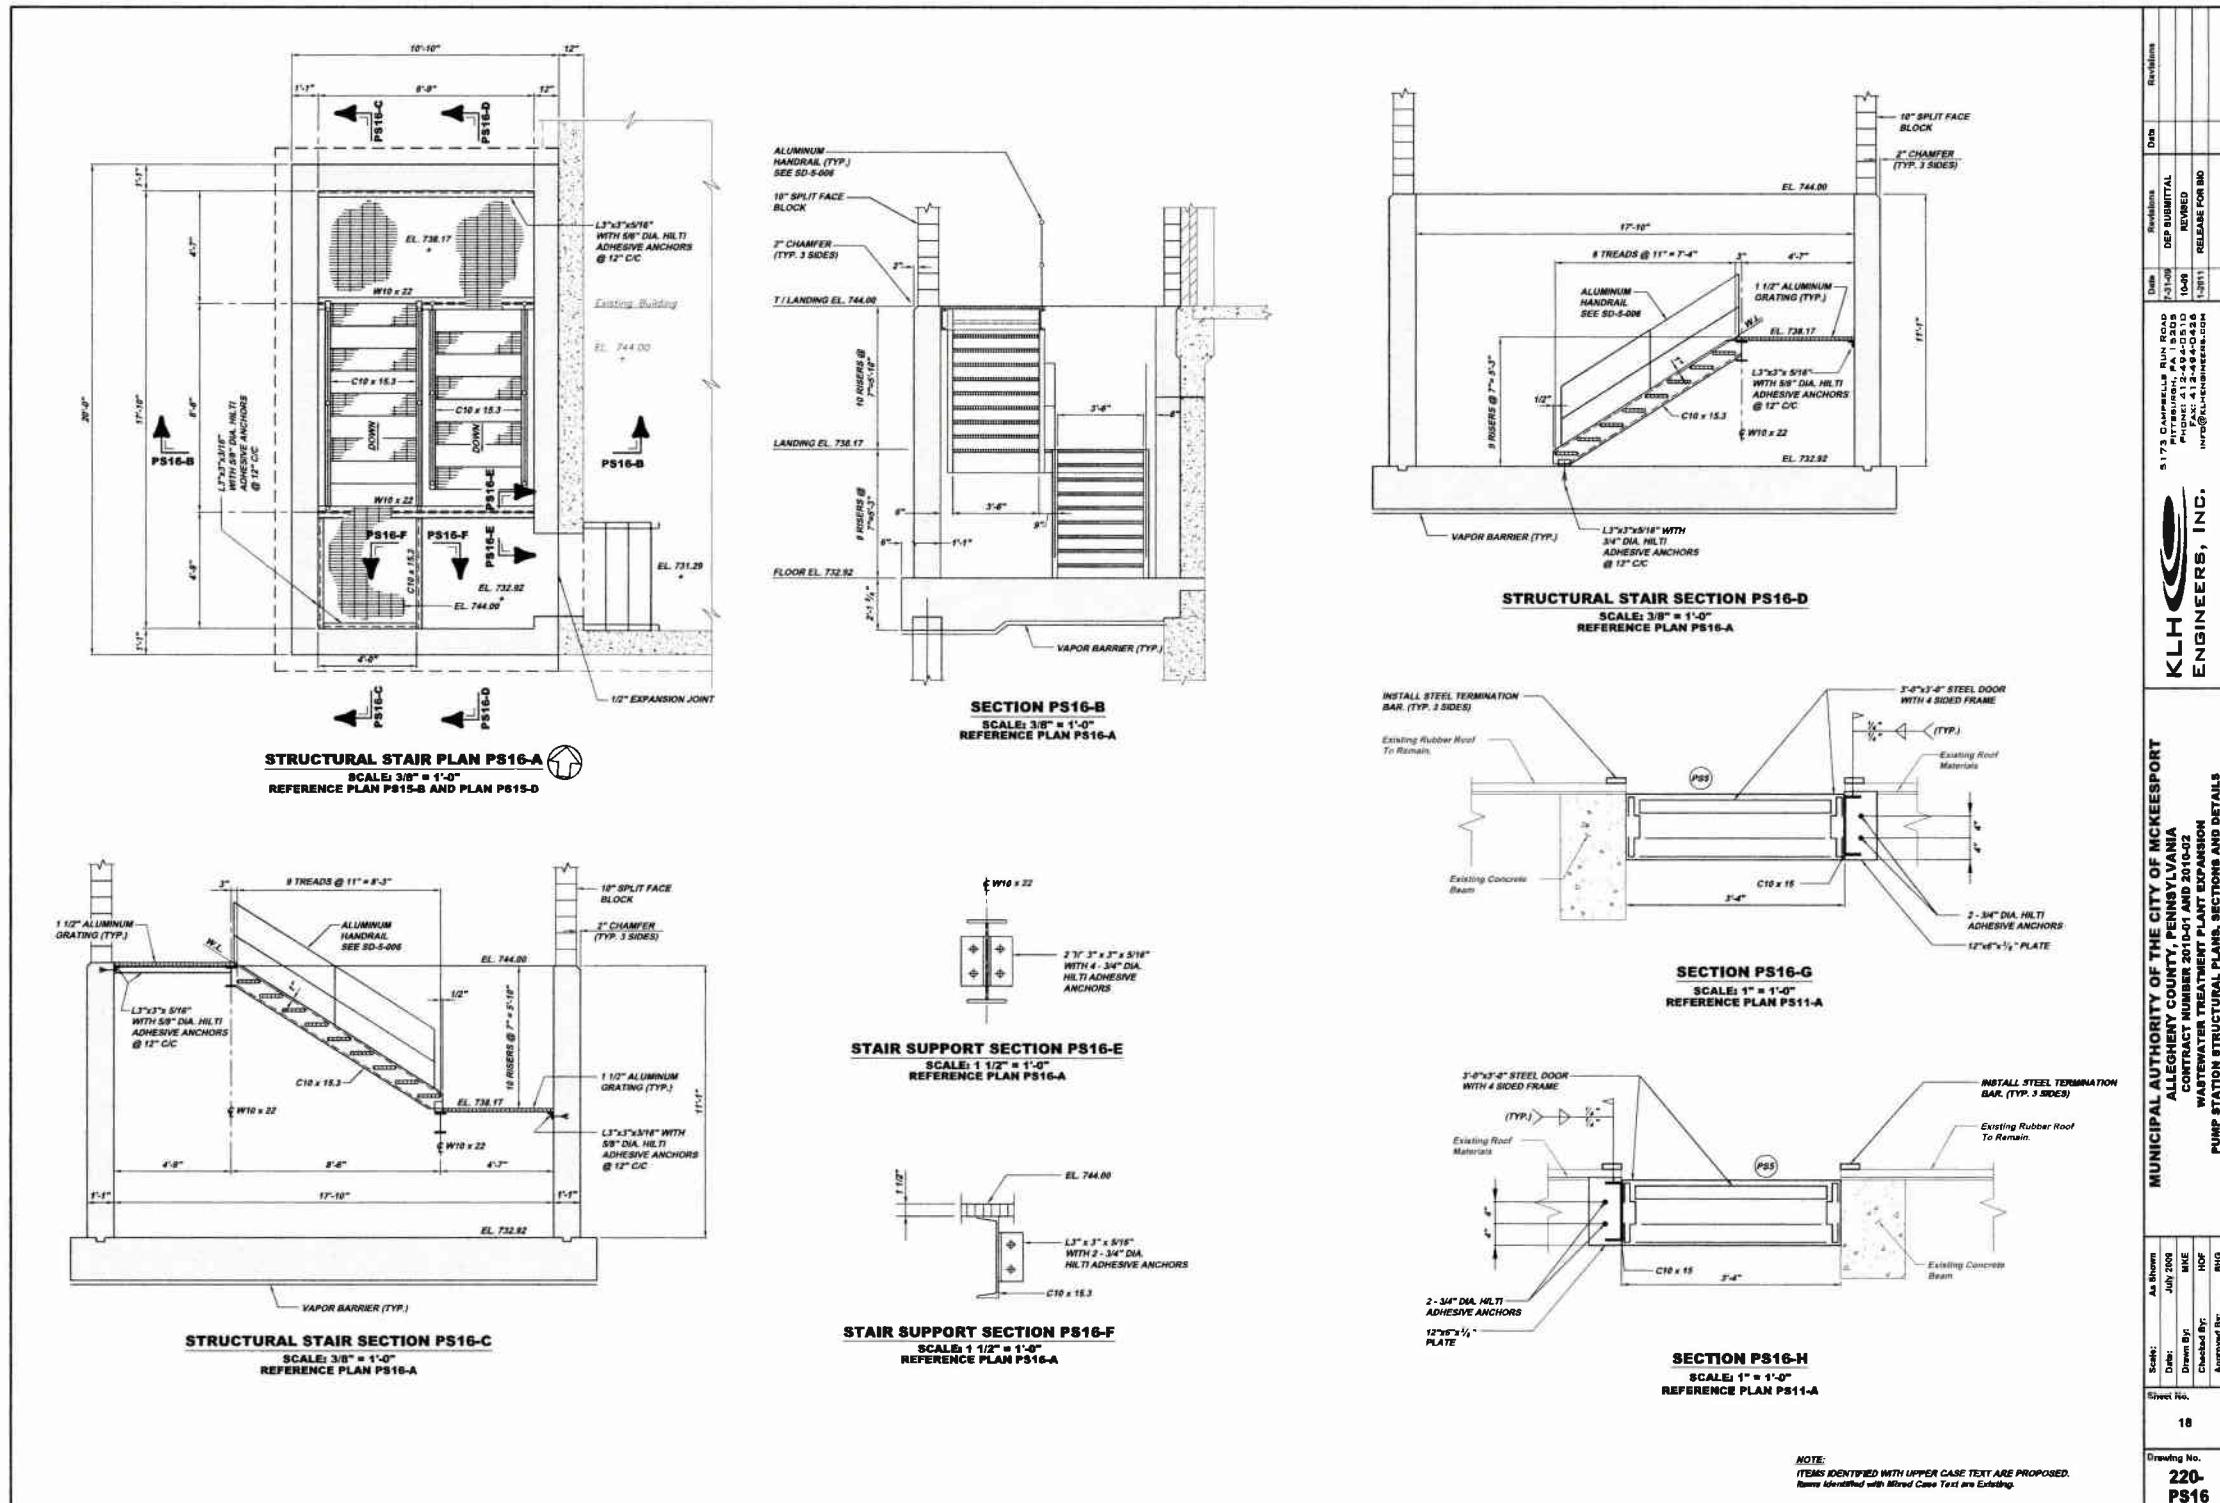


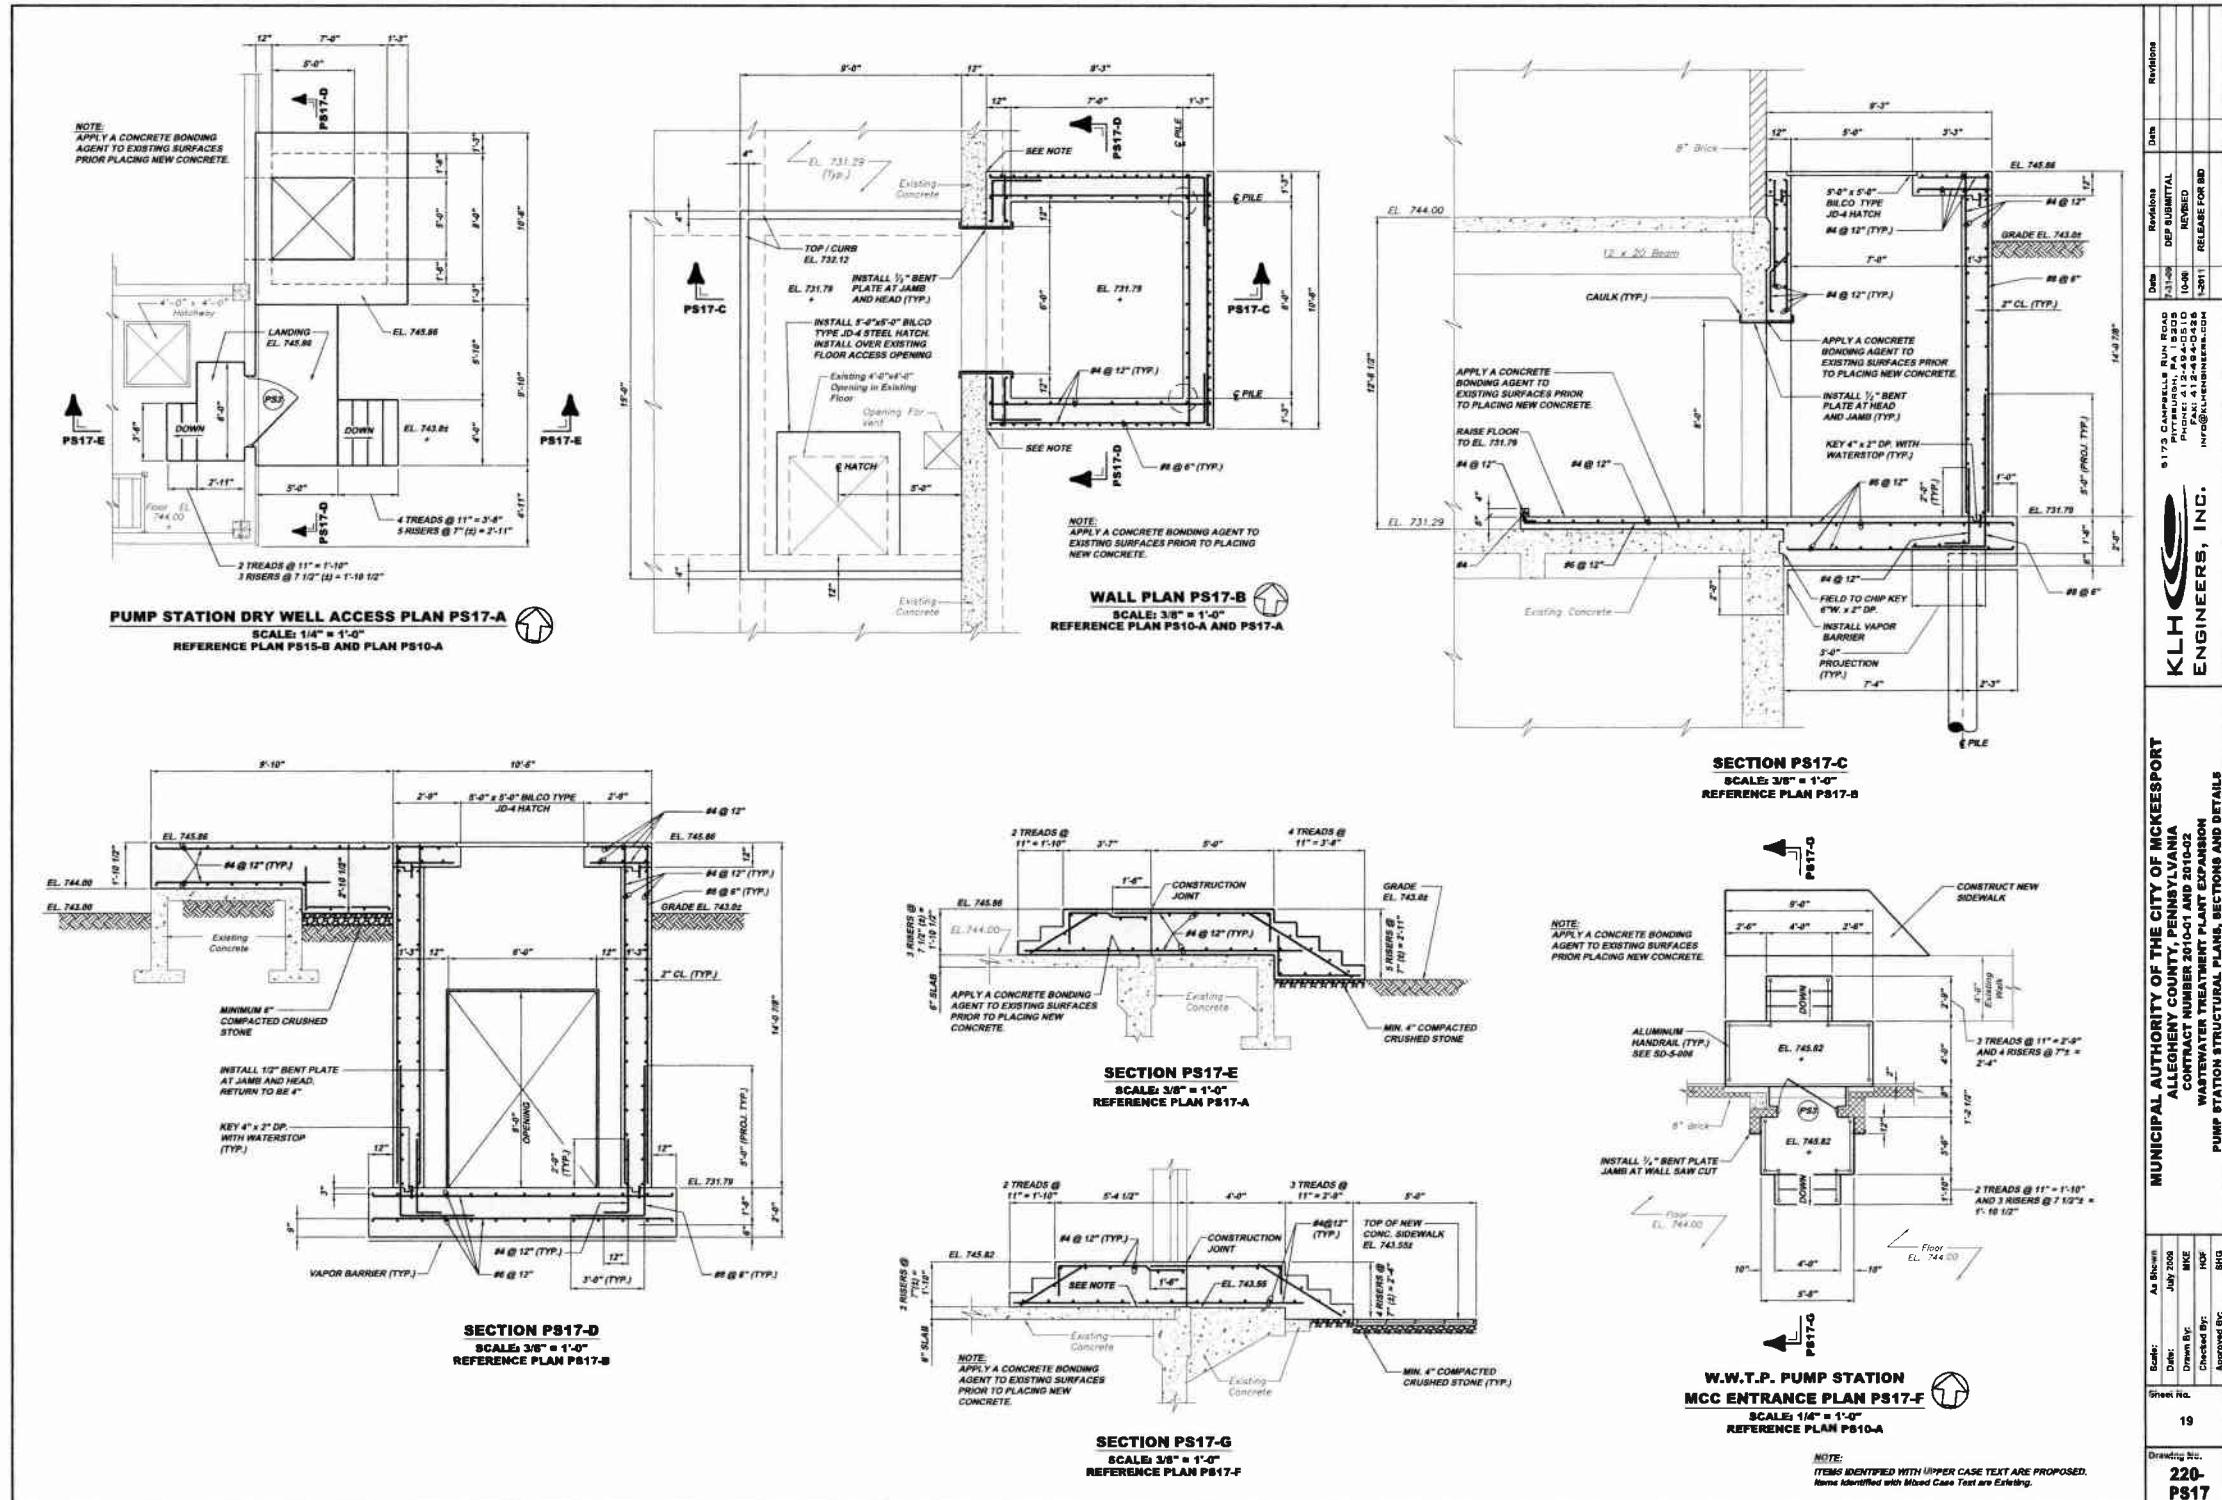

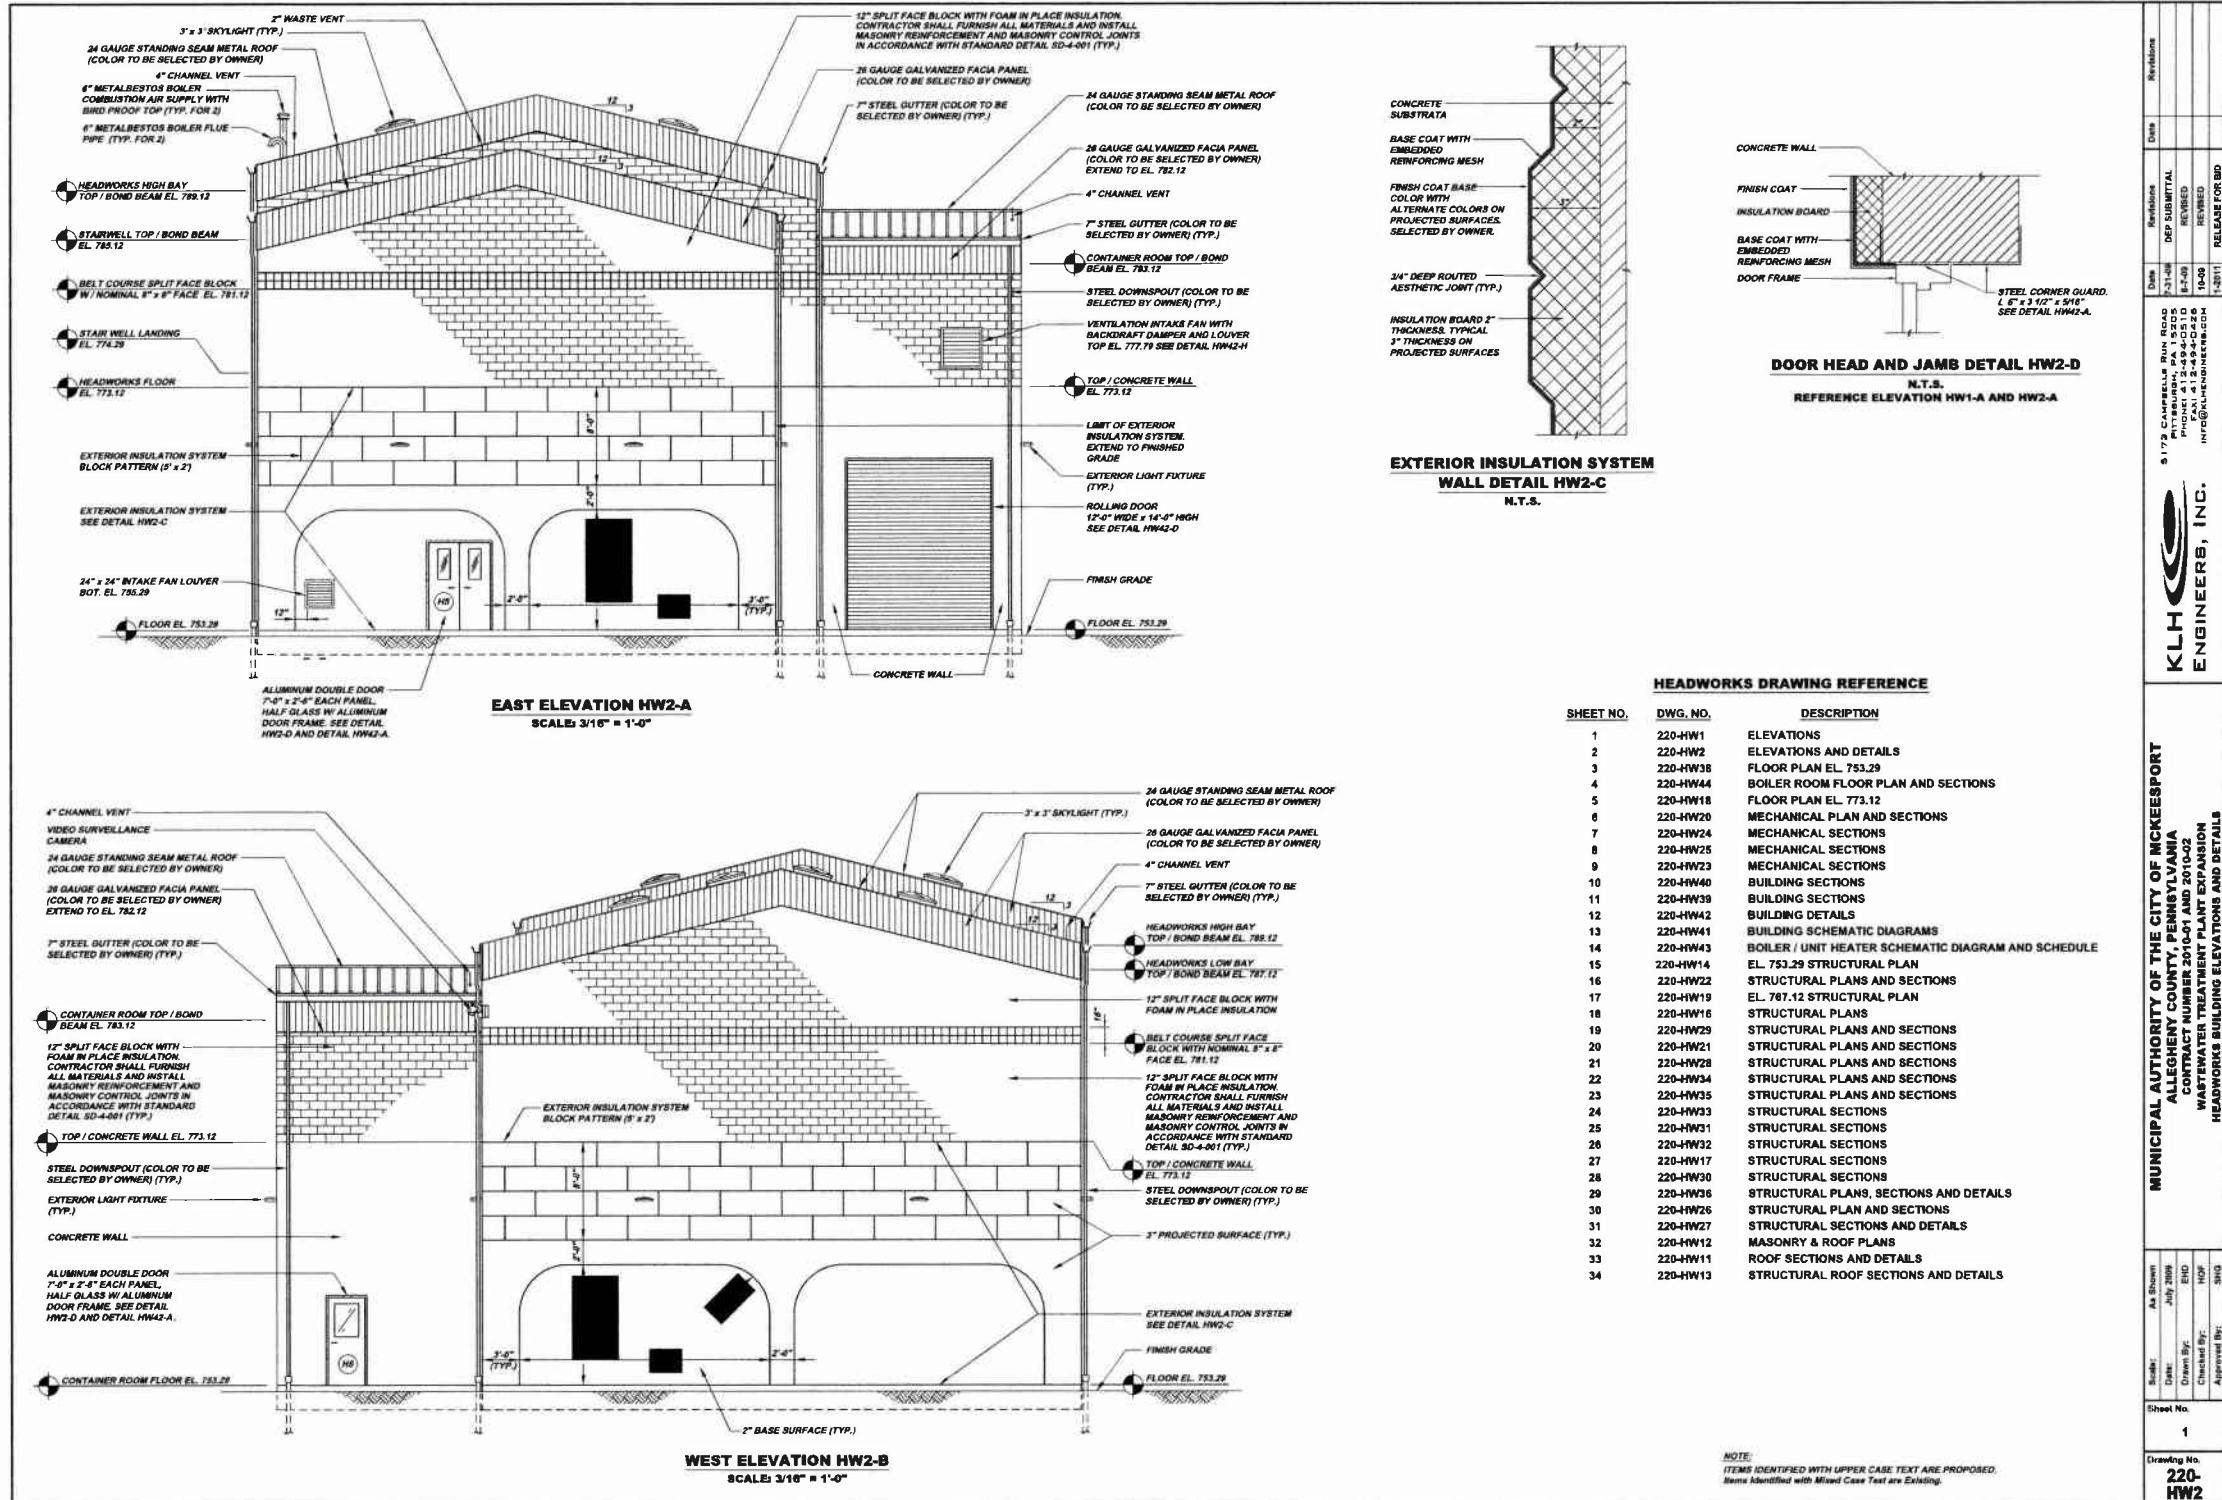


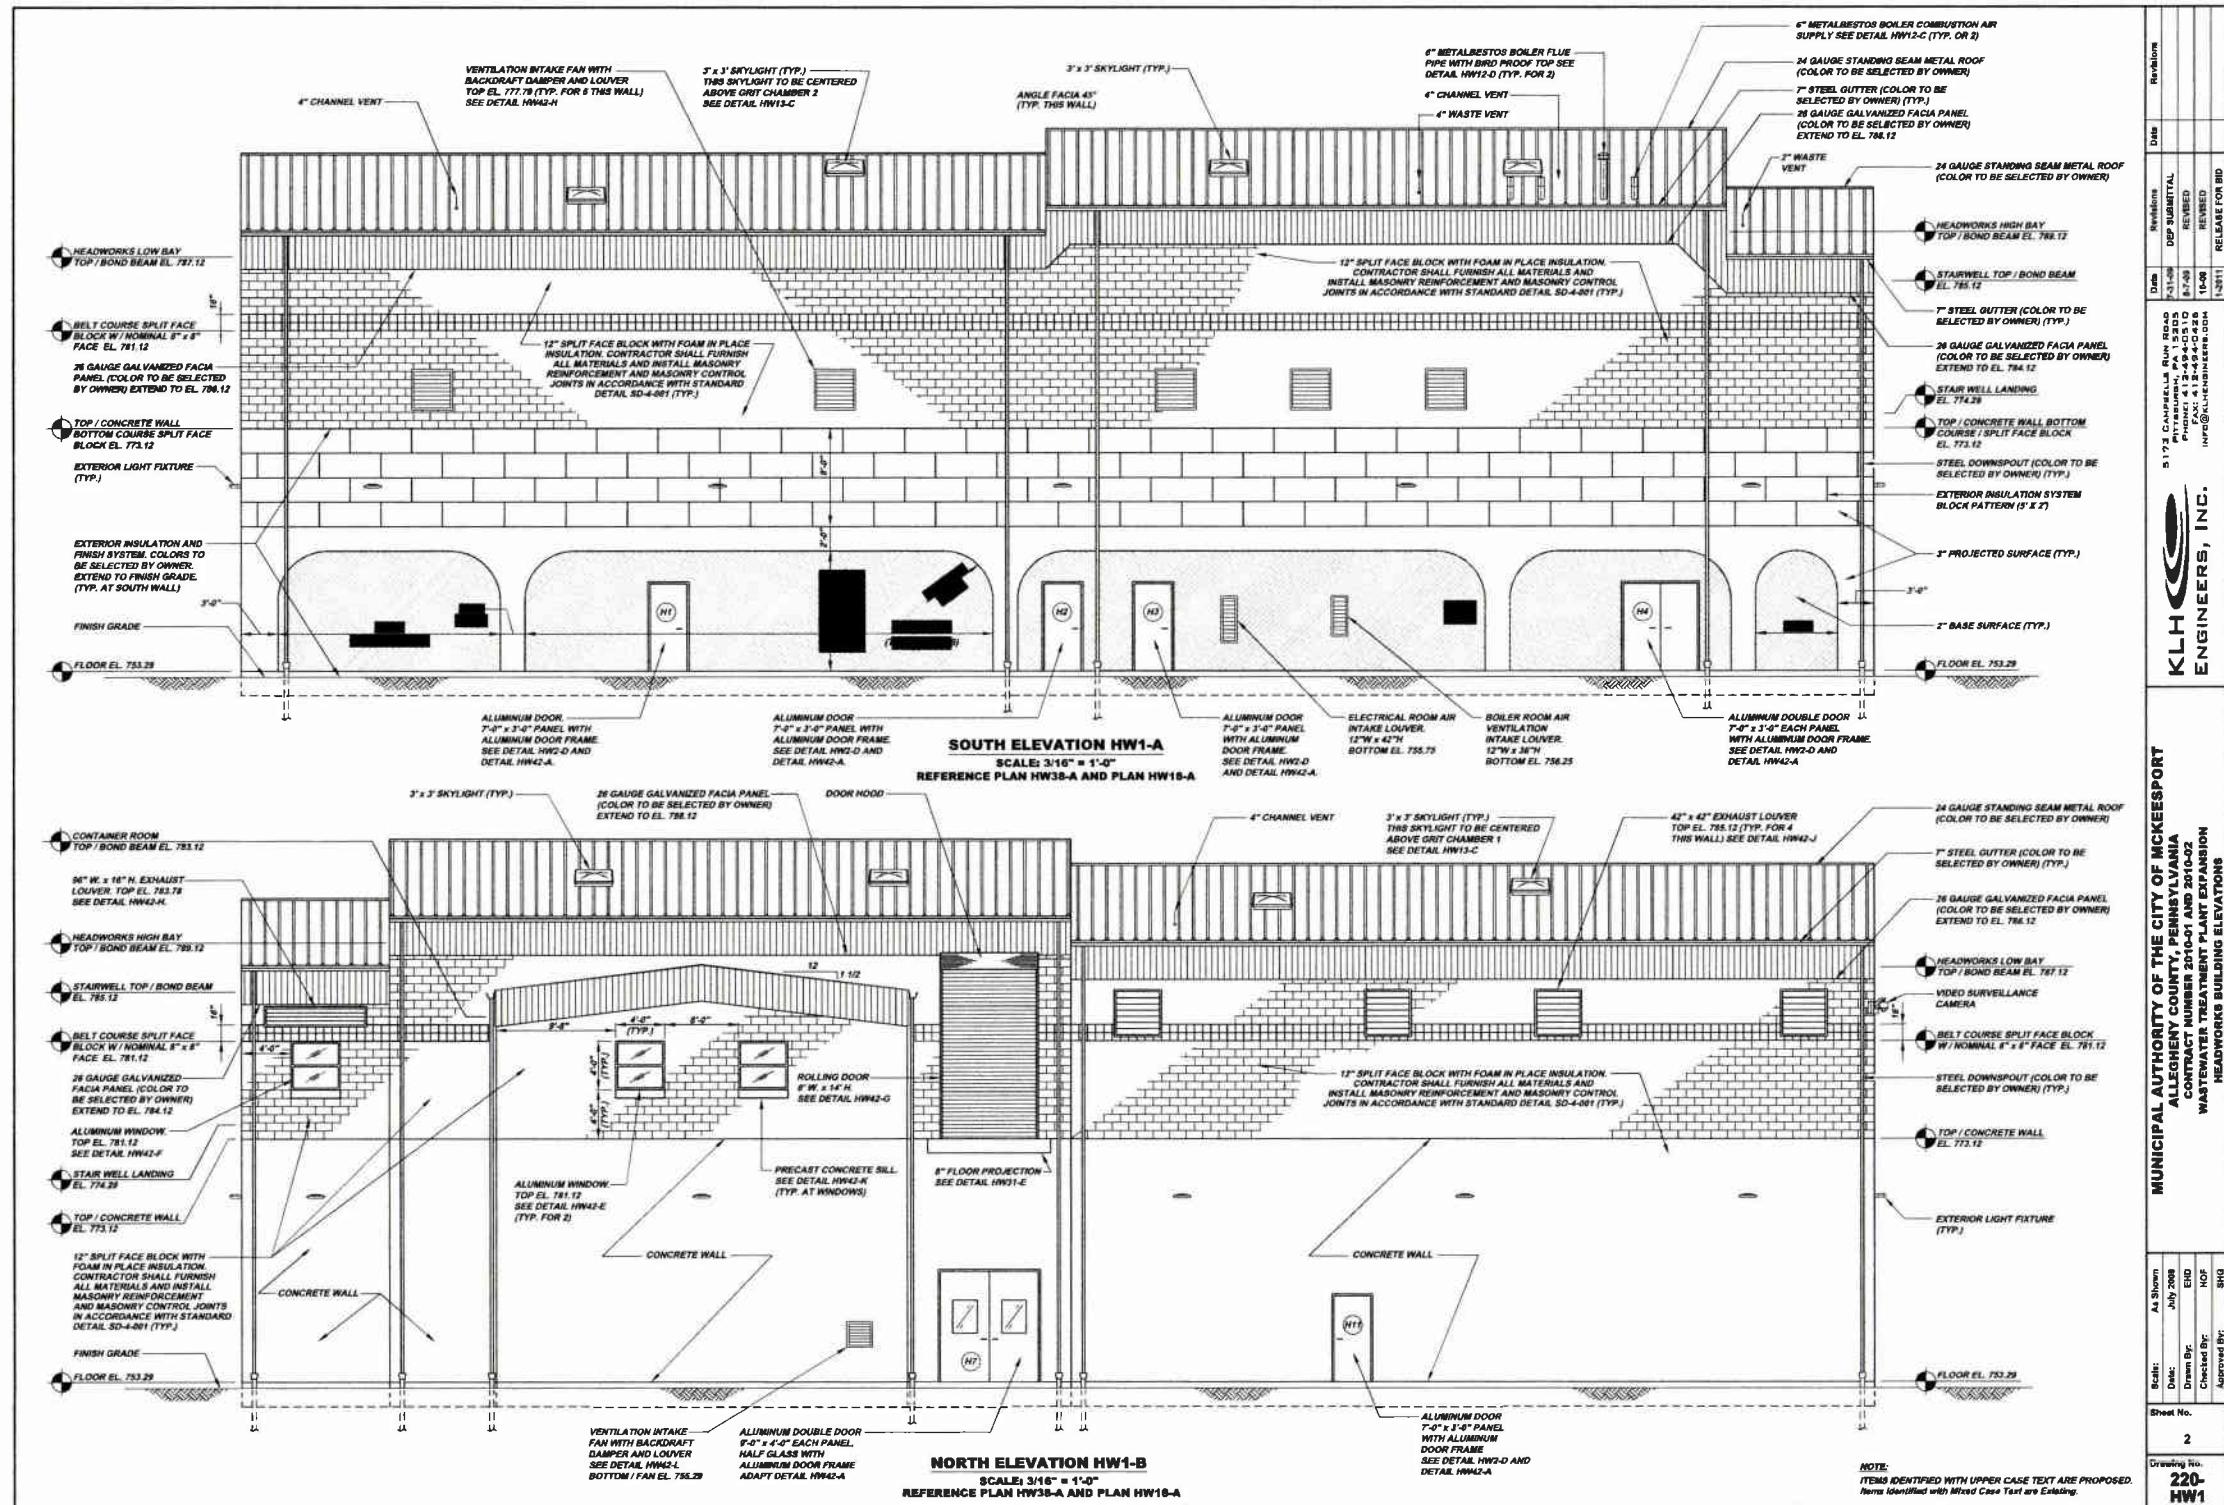

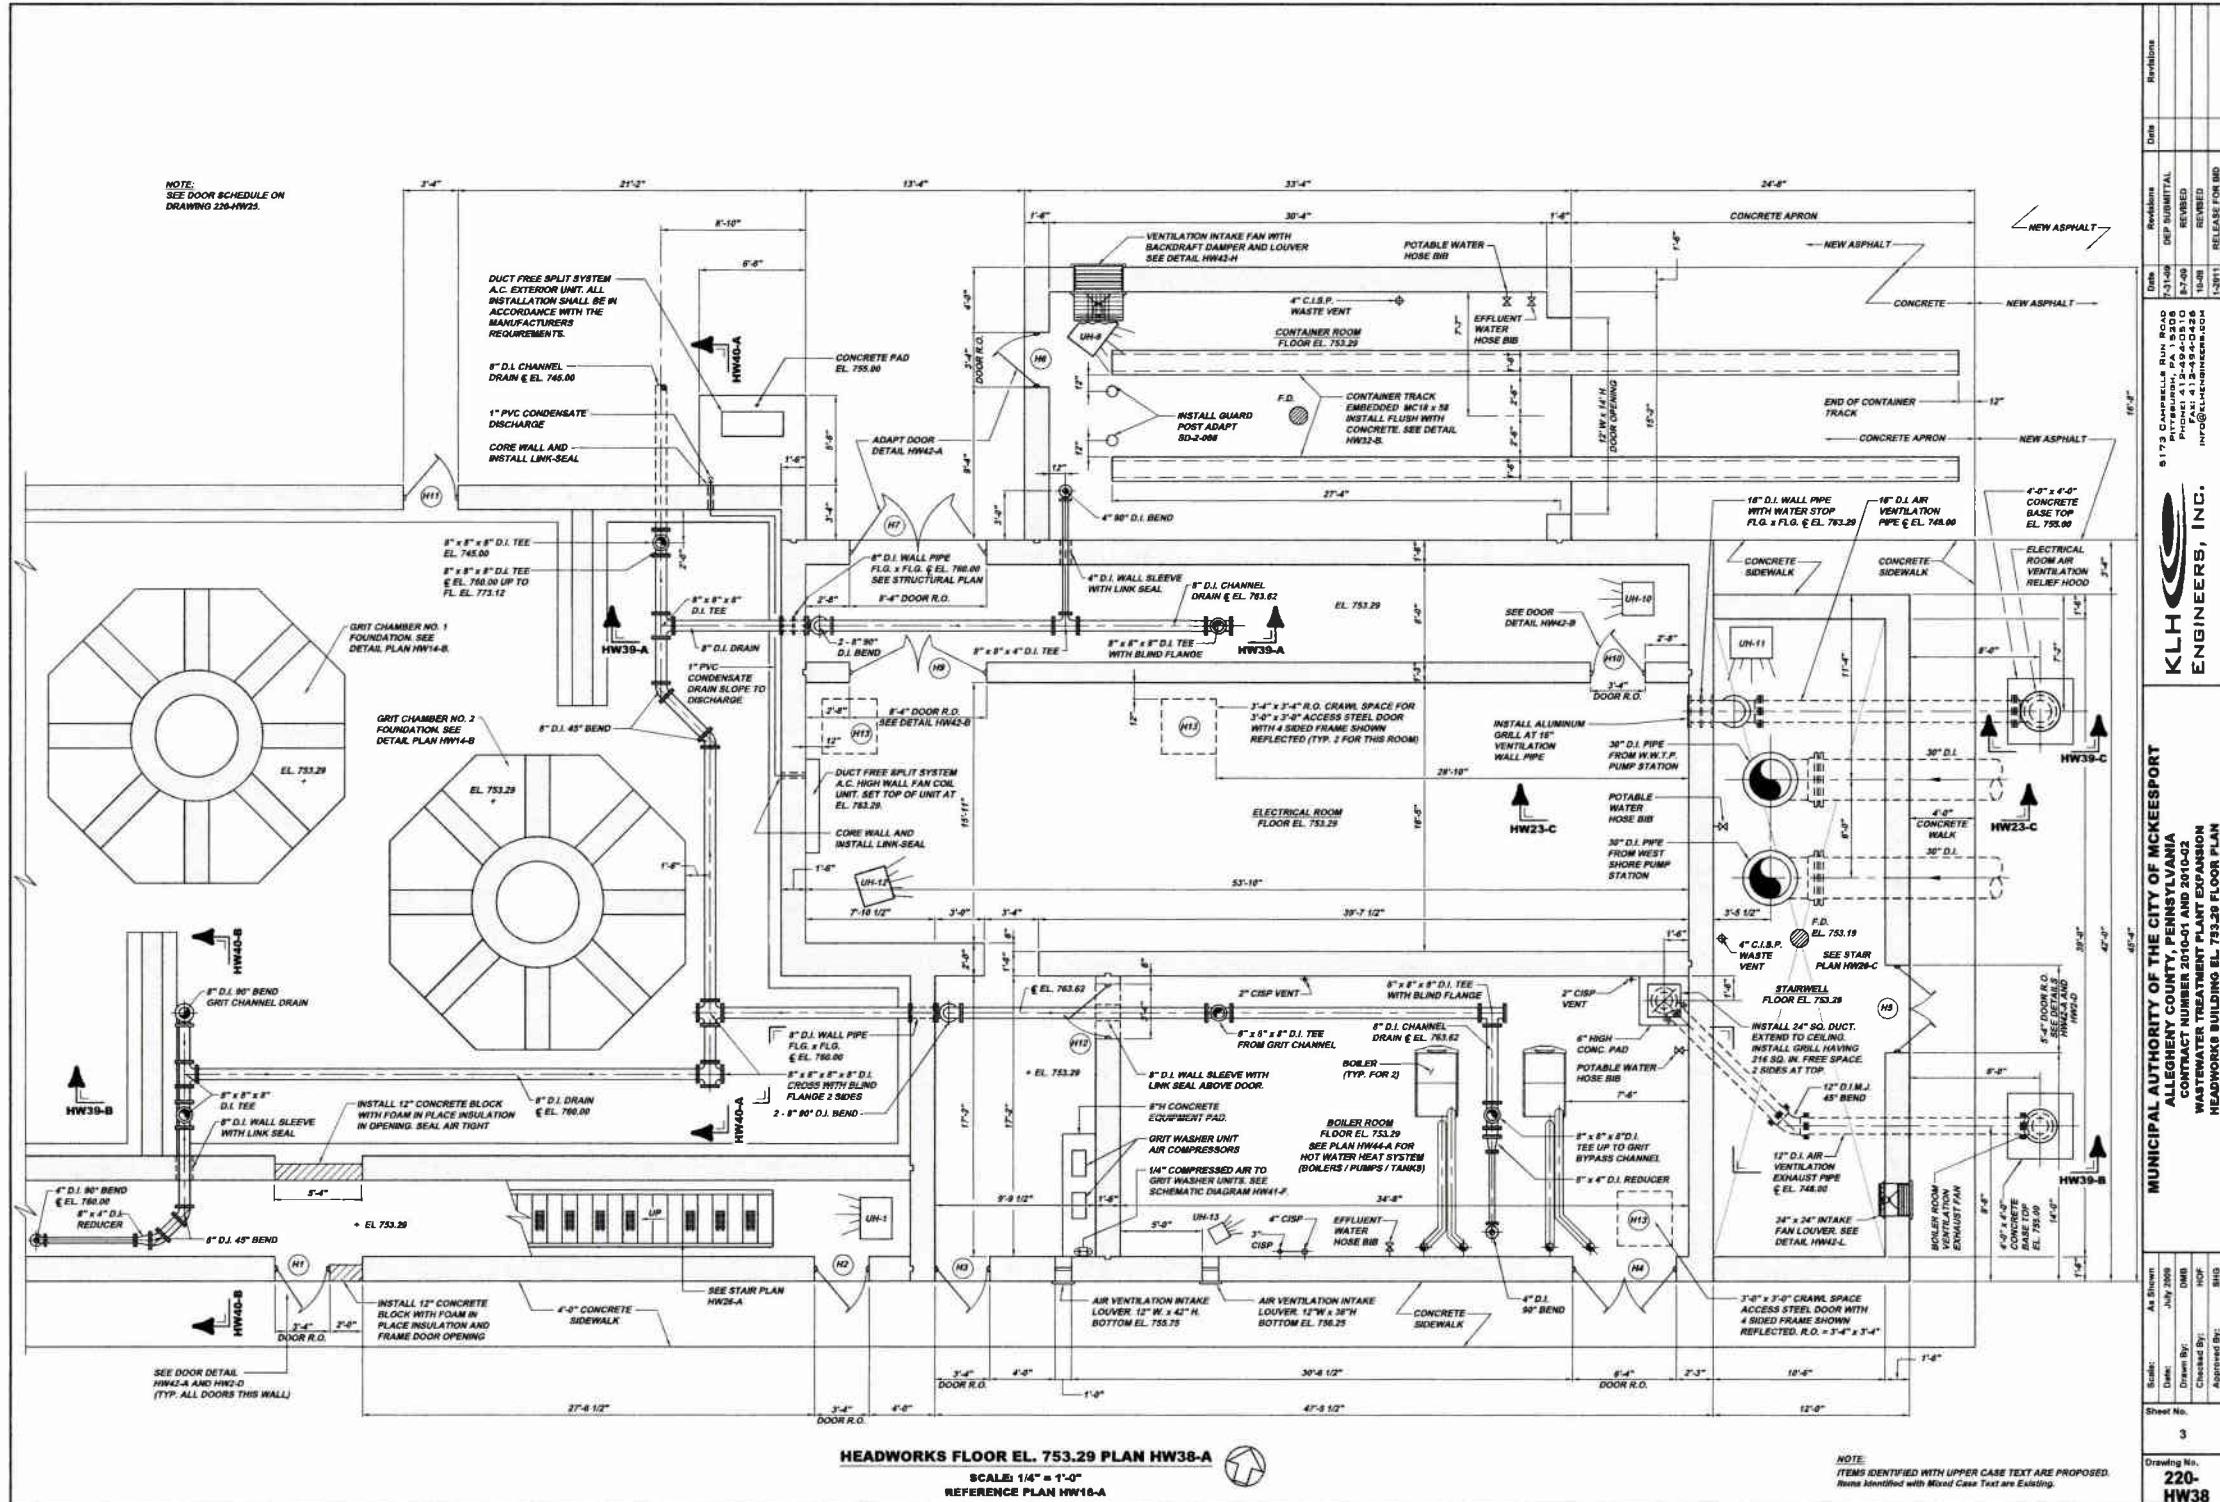


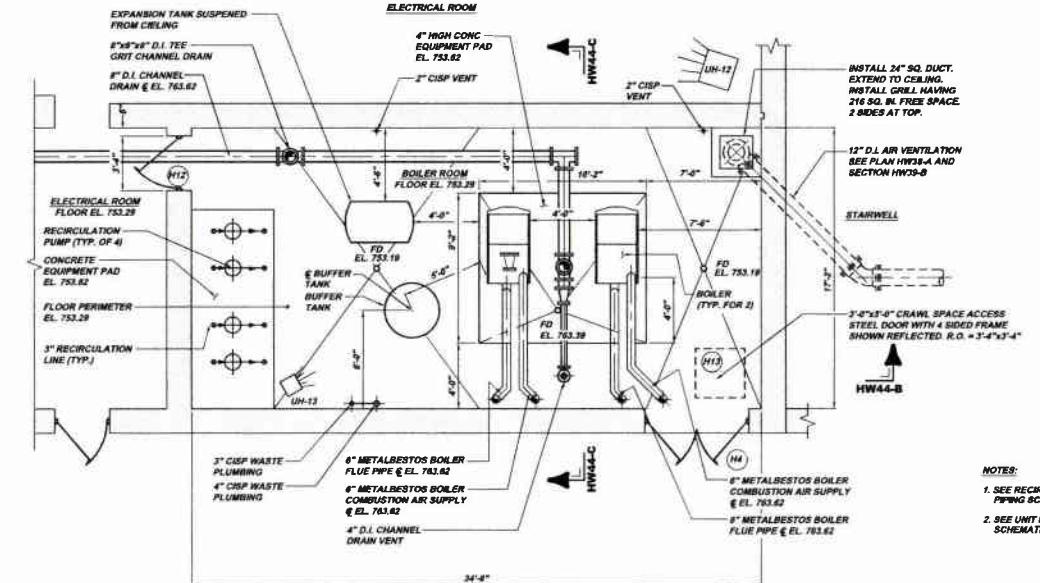

PLAN HW44-A
SCALE: 1/4" = 1'-0"
REFERENCE PLAN HW38-A

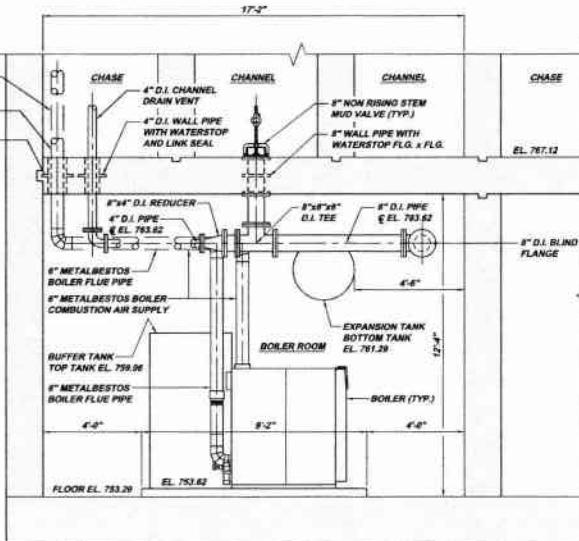

SECTION HW44-C
SCALE: 3/8" = 1'-0"
REFERENCE PLAN HW44-A

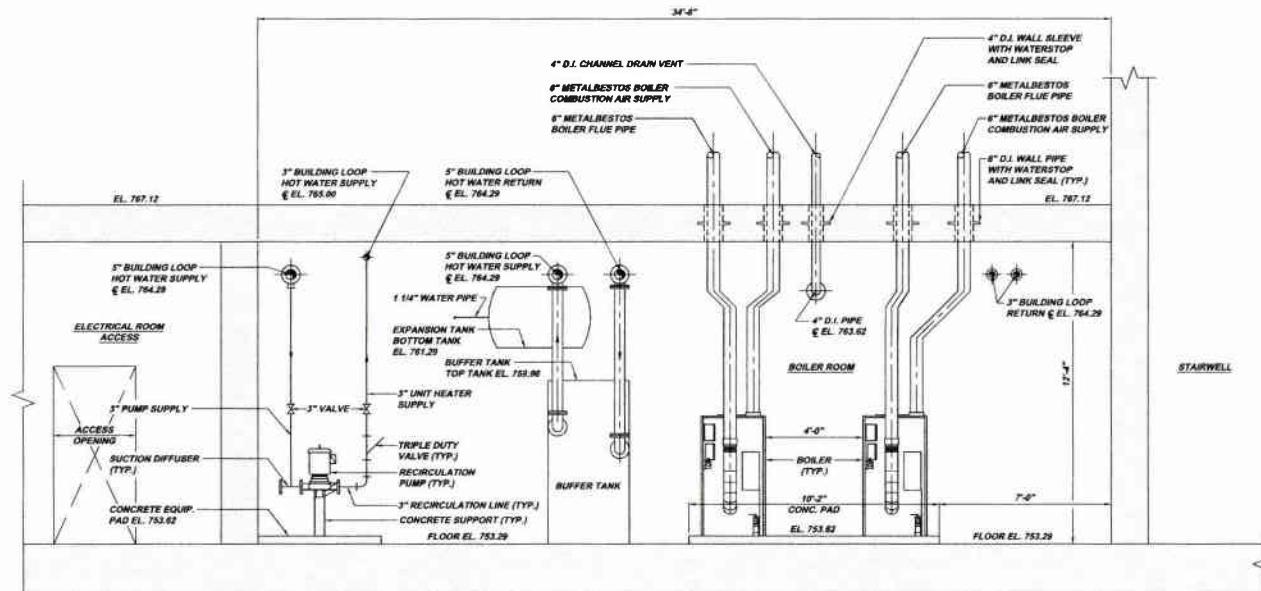

SECTION HW44-B

SCALE: 3/8" = 1'-0"

KLH ENGINEERS, INC.



KLH
ENGINEERS, INC.


PITTSBURGH, PA 15203
PH: 412-444-0215
FAX: 412-444-0216
E-MAIL: INFO@KLHENGINEERS.COM


**MUNICIPAL AUTHORITY OF THE CITY OF MCKEEESPORT
ALLENTY COUNTY, PENNSYLVANIA
CONTRACT NUMBER 2014-01 AND 2014Q2
WASTEWATER TREATMENT PLANT EXPANSION
BOILER ROOM FLOOR PLAN AND SECTION**


Date:	October 2009
Drawn By:	DMB
Checked By:	HOF
Approved By:	BHG


NOTE:
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Items Identified with Mixed Case Text are Existing.

Drawing No.
220-
HW44

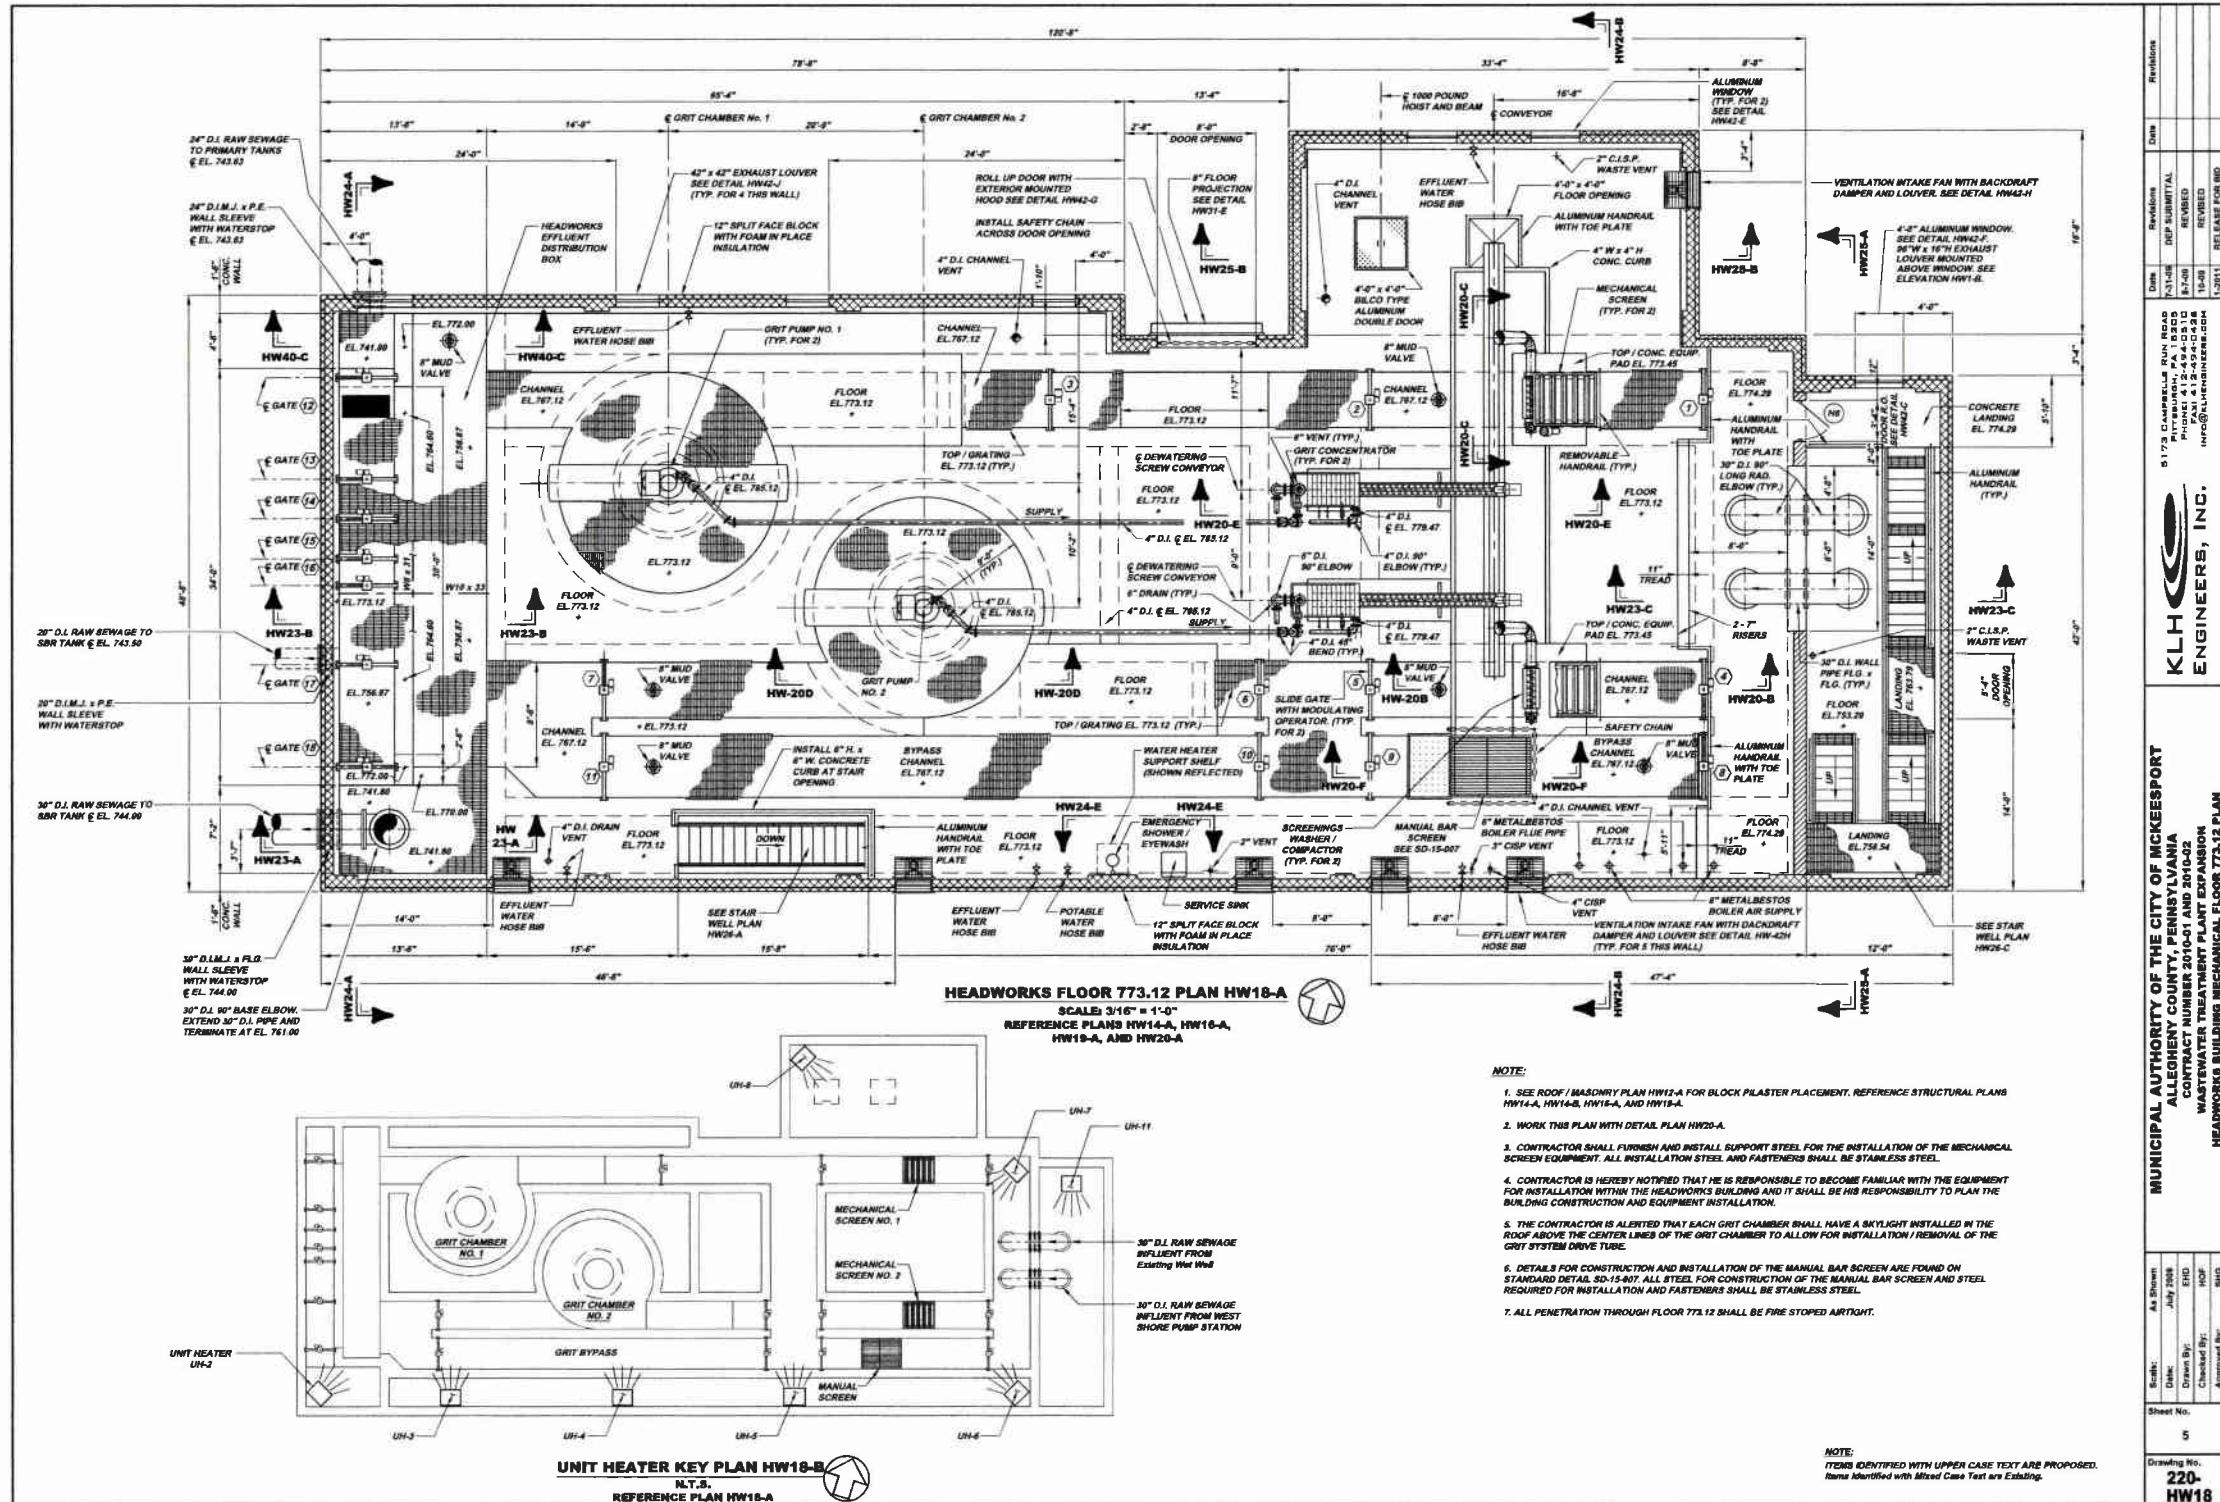

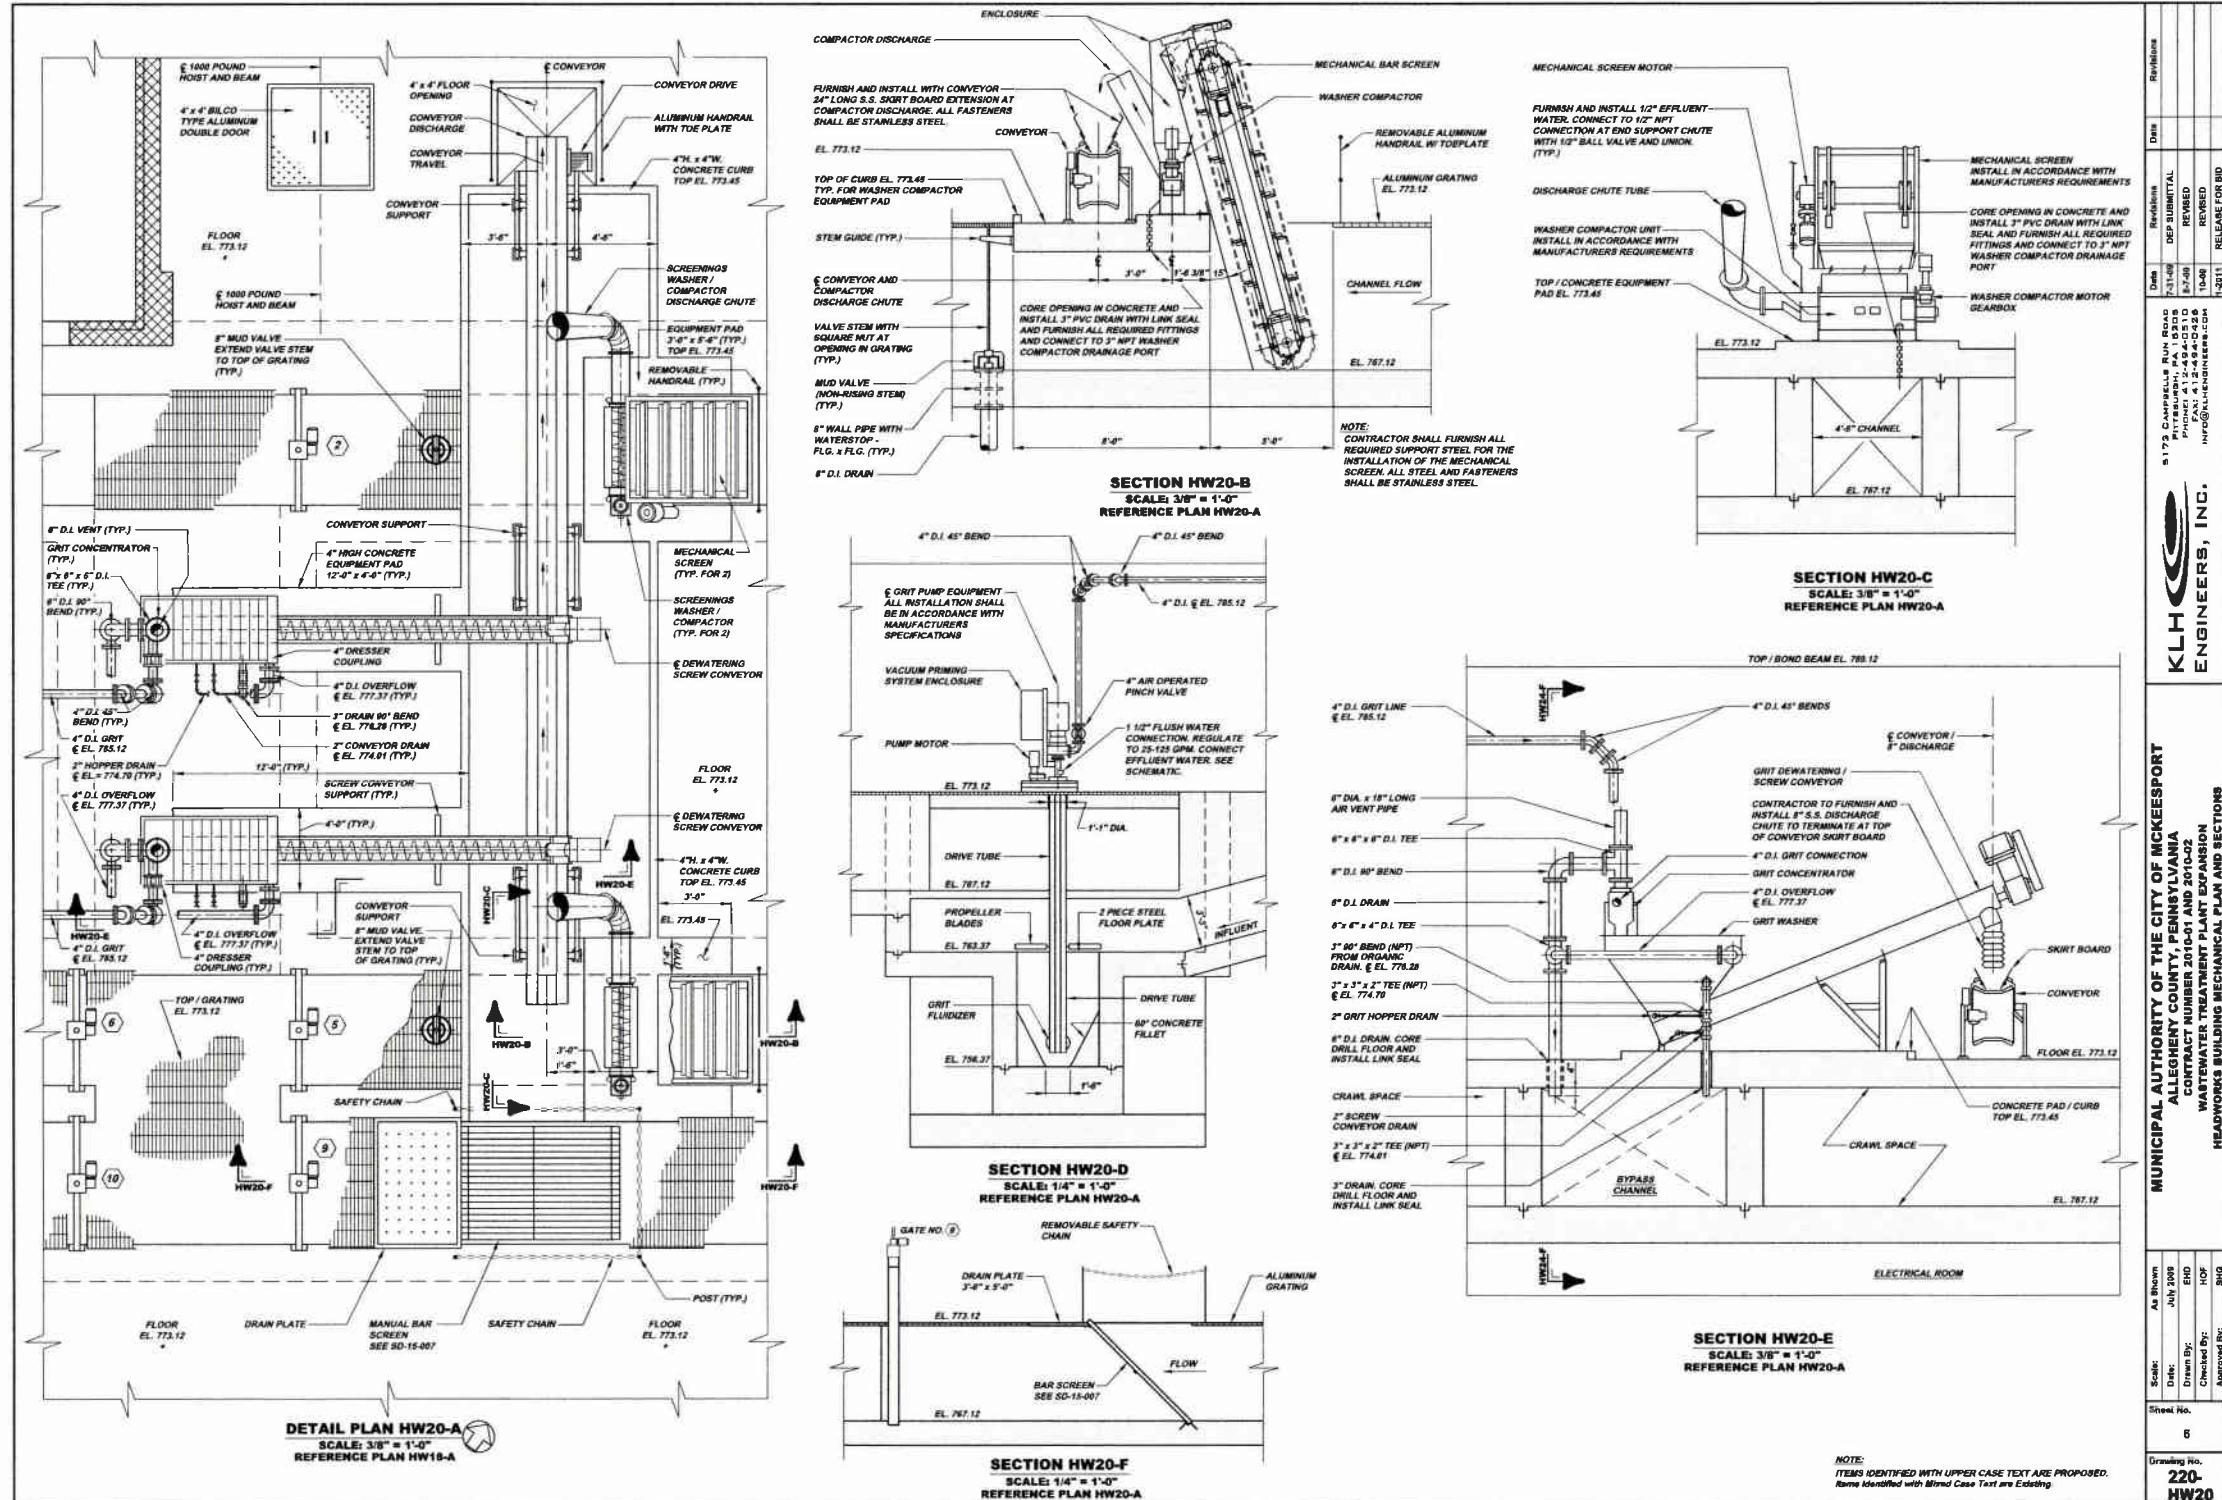


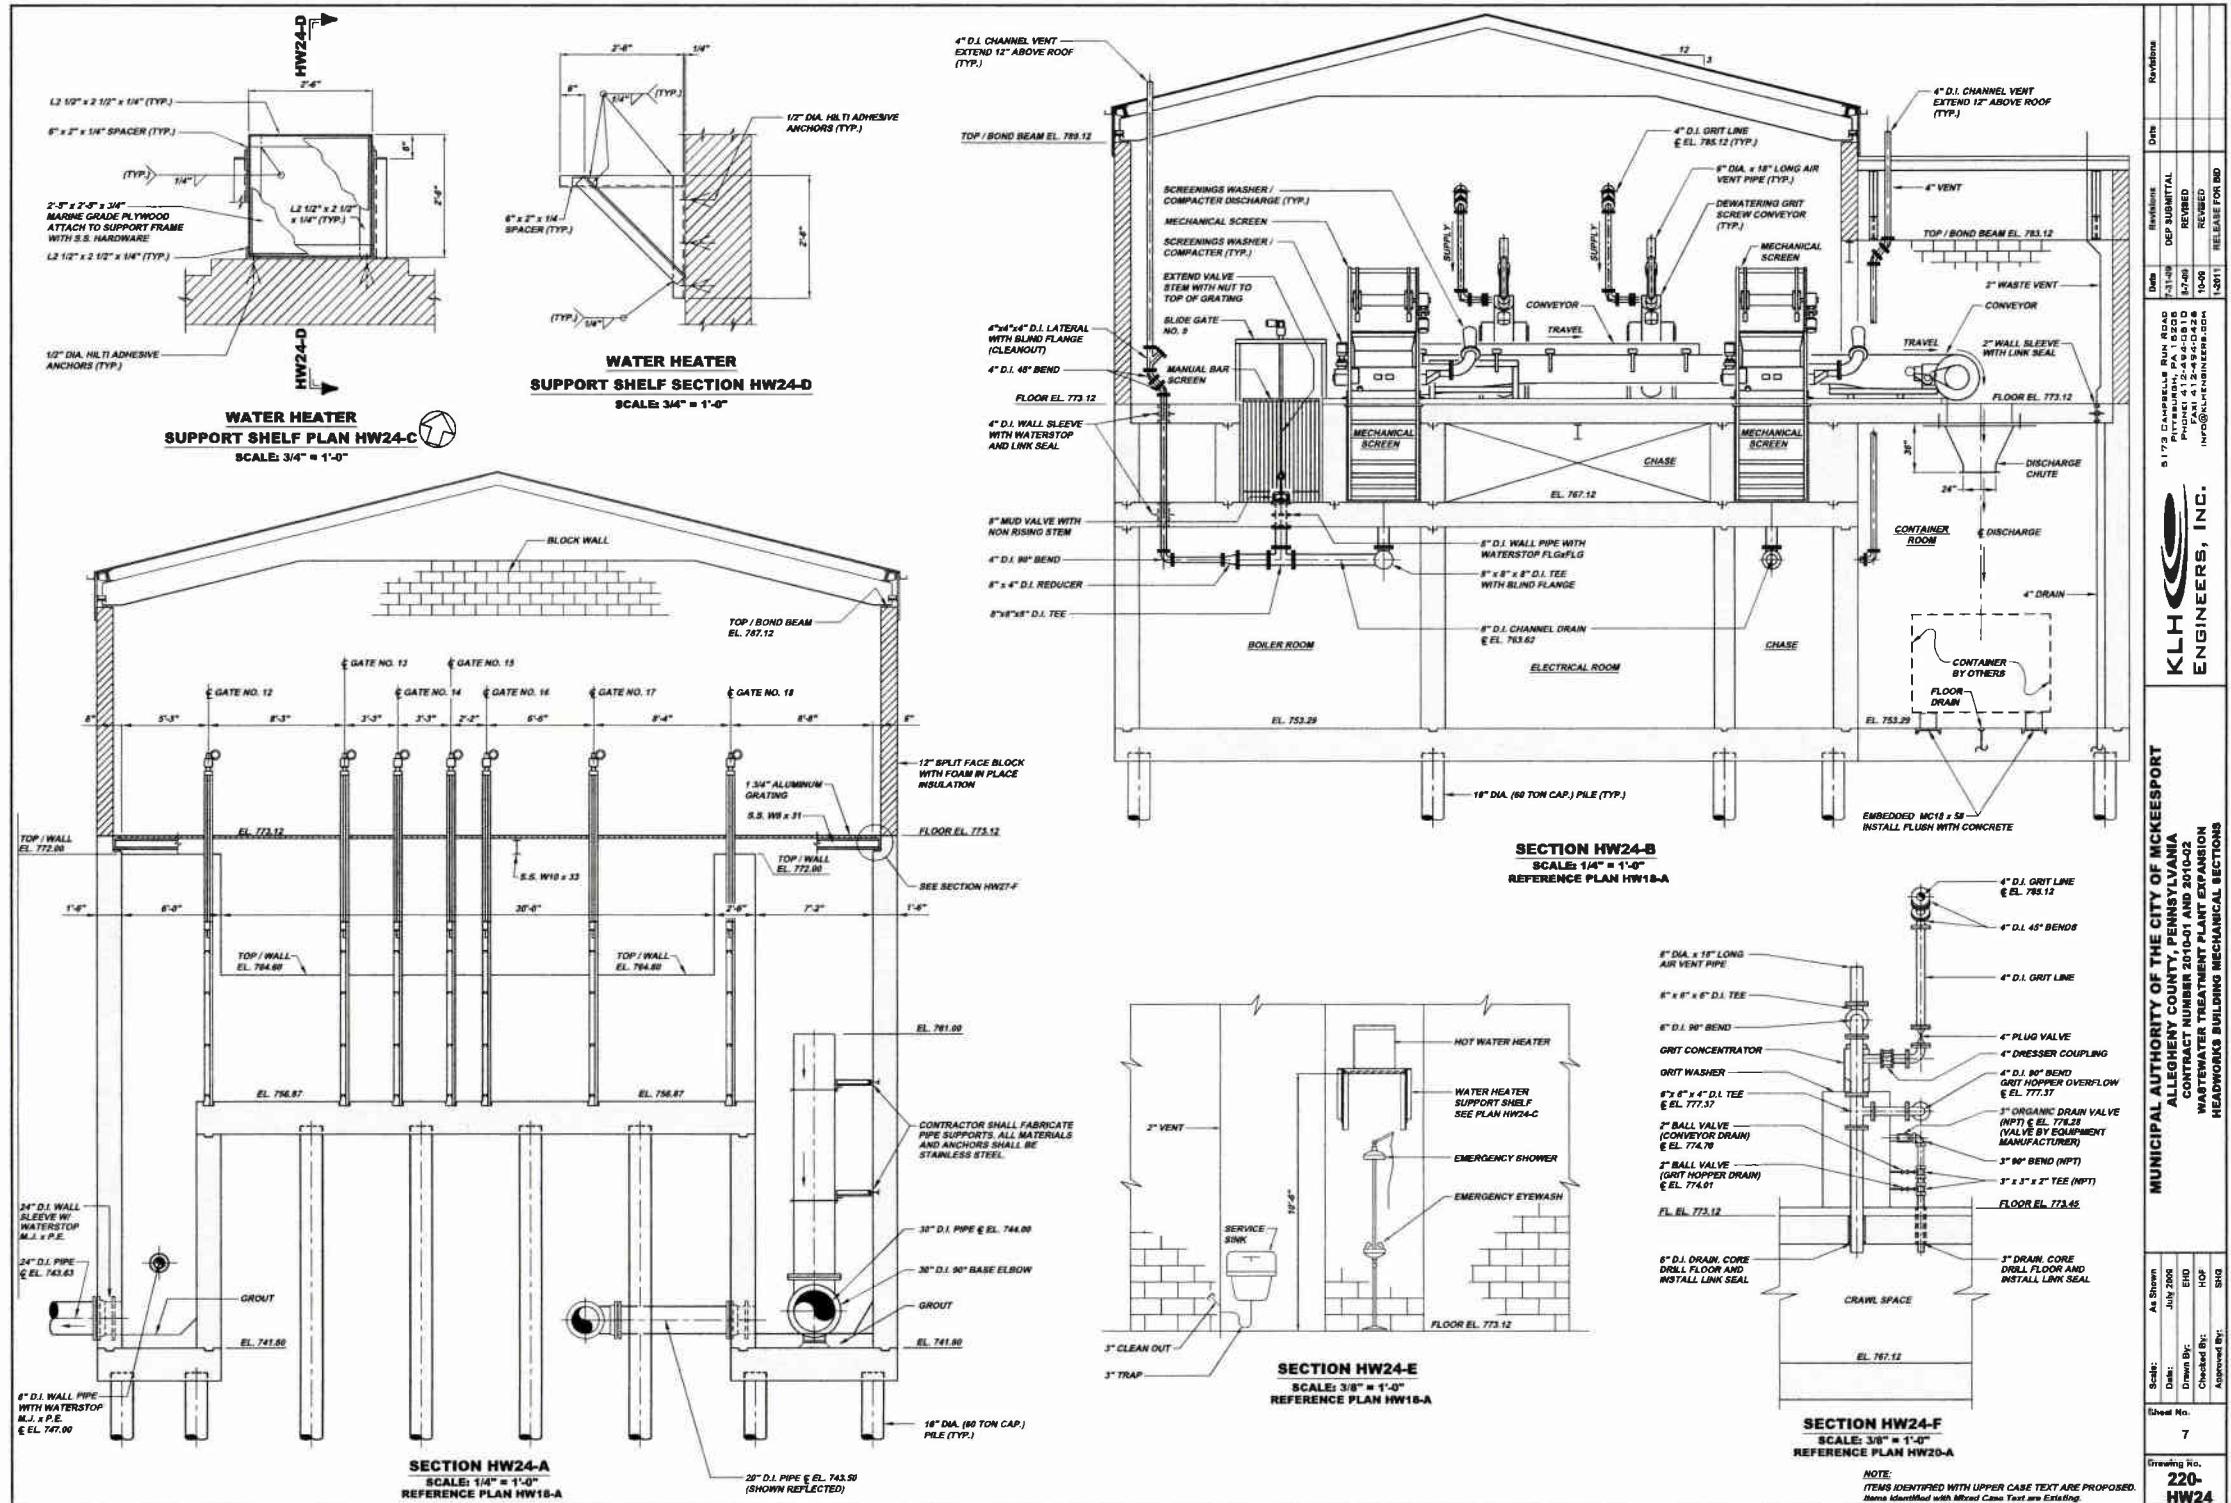

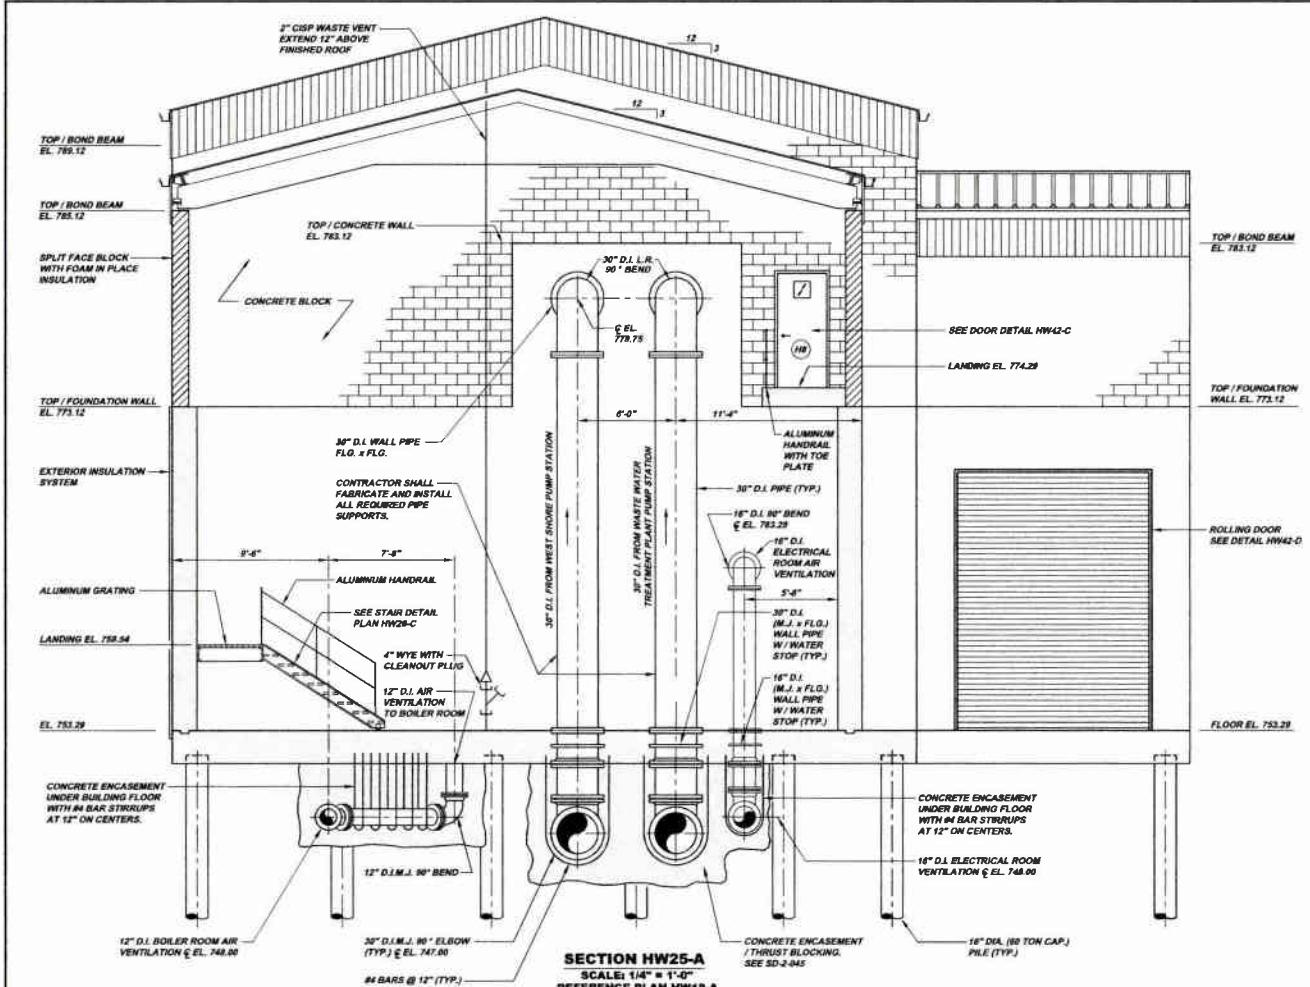

SECTION HW25-A
SCALE: 1/4" = 1'-0"
REFERENCE PLAN HW18-A

HEAT/MOISTURE BARRIER (ALL HARDWARE 100% SS FINISH)										
MARK	LOCATION	DOOR DESCRIPTION	CLIMB INSULATED ALUMINUM DOUBLE FLUSH PANEL 4'-0" x 7'-0" WITH ALUMINUM FRAME	LATCHET SERIES 1000 FINISH: SS	HINGE SERIES 1000 SS	GLOBER (1/4")	INTERGRAL SEAL (OPTIONAL) GLOBER	REINFORCED INTERGRAL WEDGE	WEATHER-STRIP (OPTIONAL) GLOBER	DOOR STOP (ROCK WOOD)
A1	EXTERIOR SOUTH WALL STAIR WELL ENTRANCE	CLIMB INSULATED ALUMINUM DOUBLE FLUSH PANEL 4'-0" x 7'-0" WITH ALUMINUM FRAME	3'-0" x 7'-0"	MORTISE LOCK EXIT DEVICE SERIES 1000 WITH ETL TEST	INCORPORATE STAINLESS STEEL CONTINUOUS TYPE (HEAVY DUTY RATED)	1400 ADA COMPLIANT EACH PANEL	42S	10" HIGH x .30"	140" SWING PERMITTED SEAL 10" VERTICAL	—
A2	EXTERIOR SOUTH WALL STAIR ACCESS	CLIMB INSULATED ALUMINUM DOUBLE FLUSH PANEL 4'-0" x 7'-0" WITH ALUMINUM FRAME	3'-0" x 7'-0"	MORTISE LOCK EXIT DEVICE SERIES 1000 WITH ETL TEST	INCORPORATE STAINLESS STEEL CONTINUOUS TYPE (HEAVY DUTY RATED)	1400 ADA COMPLIANT EACH PANEL	42S	10" HIGH x .30"	140" SWING PERMITTED SEAL 10" VERTICAL	—
A3	EXTERIOR SOUTH WALL ELECTRIC ROOM ENTRANCE	CLIMB INSULATED ALUMINUM DOUBLE FLUSH PANEL 4'-0" x 7'-0" WITH ALUMINUM FRAME	3'-0" x 7'-0"	VERTICAL ROX EXIT DEVICE SERIES 1000 WITH ETL TEST EACH PANEL	INCORPORATE STAINLESS STEEL CONTINUOUS TYPE (HEAVY DUTY RATED)	1400 ADA COMPLIANT EACH PANEL	42S	10" HIGH x .30"	140" SWING PERMITTED SEAL 10" VERTICAL	—
A4	EXTERIOR SOUTH WALL BOILER ROOM ACCESS	CLIMB INSULATED ALUMINUM DOUBLE FLUSH PANEL 4'-0" x 7'-0" WITH ALUMINUM FRAME	3'-0" x 7'-0"	VERTICAL ROX EXIT DEVICE SERIES 1000 WITH ETL TEST EACH PANEL	INCORPORATE STAINLESS STEEL CONTINUOUS TYPE (HEAVY DUTY RATED)	1400 ADA COMPLIANT EACH PANEL	42S	10" HIGH x .30"	140" SWING PERMITTED SEAL 10" VERTICAL 140" SWING ASTRAIGAL	—
A5	EXTERIOR SOUTH WALL STAIR WELL ACCESS	CLIMB INSULATED ALUMINUM DOUBLE HOLLOW GLASS WITH ALUMINUM FRAME DOOR PANEL 4'-0" x 7'-0" EACH PANEL	3'-0" x 7'-0"	VERTICAL ROX EXIT DEVICE SERIES 1000 WITH ETL TEST EACH PANEL	INCORPORATE STAINLESS STEEL CONTINUOUS TYPE (HEAVY DUTY RATED)	1400 ADA COMPLIANT EACH PANEL	42S	10" HIGH x .30"	140" SWING PERMITTED SEAL 10" VERTICAL 140" SWING ASTRAIGAL	—
B1	EXTERIOR CONTAMINATED ROOM ACCESS	CLIMB INSULATED ALUMINUM DOUBLE HOLLOW GLASS WITH ALUMINUM FRAME	3'-0" x 7'-0"	MORTISE LOCK EXIT DEVICE SERIES 1000 WITH ETL TEST	INCORPORATE STAINLESS STEEL CONTINUOUS TYPE (HEAVY DUTY RATED)	1400 ADA COMPLIANT EACH PANEL	42S	10" HIGH x .30"	140" SWING PERMITTED SEAL 10" VERTICAL	—
B2	EXTERIOR CONTAMINATED ROOM ACCESS	CLIMB INSULATED ALUMINUM DOUBLE HOLLOW GLASS WITH ALUMINUM FRAME	3'-0" x 7'-0"	VERTICAL ROX EXIT DEVICE SERIES 1000 WITH ETL TEST EACH PANEL	INCORPORATE STAINLESS STEEL CONTINUOUS TYPE (HEAVY DUTY RATED)	1400 ADA COMPLIANT EACH PANEL	42S	10" HIGH x .30"	140" SWING PERMITTED SEAL 10" VERTICAL 140" SWING ASTRAIGAL	—
C1	EXTERIOR WALL ELECTRIC ROOM ENTRANCE	CLIMB INSULATED ALUMINUM DOUBLE DOOR ALUMINUM FRAME; EACH DOOR CUTAWAY HOLLOW GLASS	3'-0" x 7'-0"	MORTISE LOCK EXIT DEVICE SERIES 1000 WITH ETL TEST	INCORPORATE STAINLESS STEEL CONTINUOUS TYPE (HEAVY DUTY RATED)	1400 ADA COMPLIANT EACH PANEL	42S	10" HIGH x .30"	140" SWING PERMITTED SEAL 10" VERTICAL	—

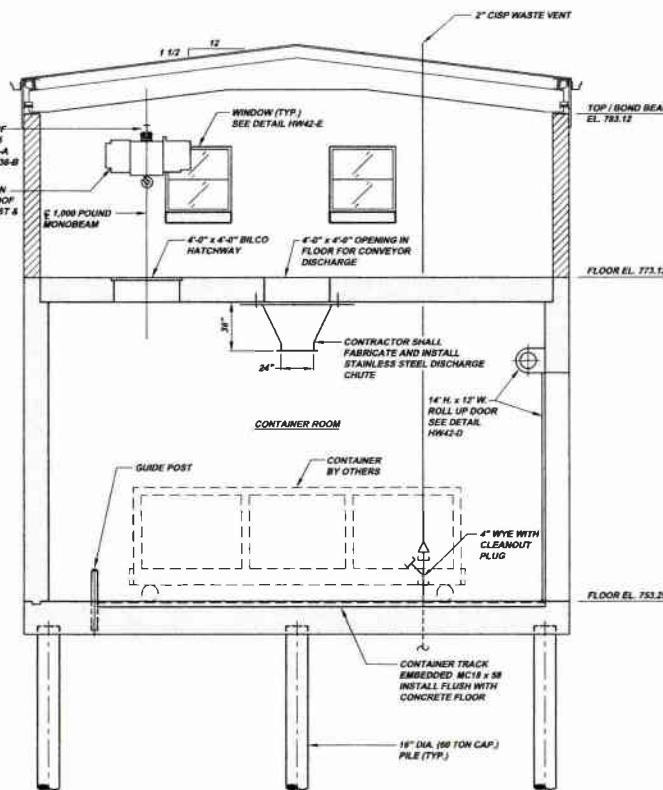

SECTION HW25-B
SCALE: 1/4" = 1'-0"
REFERENCE PLAN HW1B-A




HEADDOORS DOOR SCHEDULE (ALL HARDWARE US 32 FINISH)										
MARK	LOCATION	DOOR DESCRIPTION	DIMENSIONS (WIDE X HIGH OPENINGS)	LOCKSET (STANDARD FRONT SIDE)	HANDLE (FRONT SIDE)	CLOSER (SIDE)	THREE-SIDE PRIMER COATED	REINFORCING PLATE HIDDEN		
HB	INTERIOR HEADDOORS ROOF ACCESS AT SOUTH STAIRS	CECO CORP INSULATED METAL DOUBLE DOOR, 1 1/2" - HR FIRE RATED 1 1/2" x 7' PINDOW WITH 1/4" WIRE GLASS	7'x4" x 7'x4"	MORTISE LOCK EXT DEVICE SERIES 9190 WITH STL PRIME	HAGER BB 1101	1400 ADA COMPLIANT	—	10" HIGH x .65"	HR 8A PERIMETER SEAL	471
HW	INTERIOR ELECTRIC ROOM ACCESS	CECO CORP INSULATED METAL DOUBLE DOOR, 1 1/2" - HR FIRE RATED 1 1/2" x 7' PINDOW WITH 1/4" WIRE GLASS	8'x4" x 8'x4"	VERTICAL ROO EXIT DEVICE SERIES 9190 WITH STL PRIME EACH PAGE	HAGER BB 1101	1400 ADA COMPLIANT EACH PAGE	—	10" HIGH x .65"	HR 8A PERIMETER SEAL 140 SERIE ASTRAGAL	471
H4	INTERIOR ELECTRIC ROOM ACCESS	CECO CORP INSULATED METAL DOOR 1 1/2" - HR FIRE RATED 1 1/2" x 7' PINDOW WITH 1/4" WIRE GLASS	8'x4" x 8'x4"	MORTISE LOCK EXT DEVICE SERIES 9190 WITH STL PRIME	HAGER BB 1101	1400 ADA COMPLIANT	—	10" HIGH x .65"	HR 8A PERIMETER SEAL	471
H5	ESTERIOR NORTH HALL FOUNDATION ACCESS	CLINE INSULATED ALUMINUM DOOR, 1 1/2" - HR FIRE RATED 1 1/2" x 7' PINDOW WITH 1/4" WIRE GLASS	7'x4" x 7'x4"	MORTISE LOCK EXIT DEVICE SERIES 9190 WITH STL PRIME PAGE	MCKEEHENY STAINLESS STEEL CONCEALED HEAVY DUTY PAGE	1400 ADA COMPLIANT EACH PAGE	4D	10" HIGH x .65"	HR 8A PERIMETER SEAL 101 VDSR AWPSP	—
H12	INTERIOR BEDROOM ACCESS	CECO METAL DOOR 1 1/2" - HR FIRE RATED 1 1/2" x 7' PINDOW WITH 1/4" WIRE GLASS	7'x4" x 7'x4"	REINFORCE LOCK EXT DEVICE SERIES 9190 WITH STL PRIME	HAGER BB 1101	1400 ADA COMPLIANT	—	10" HIGH x .65"	HR 8A PERIMETER SEAL	471
H13	ELECTRIC ROOM CHASE ACCESS (3 REEDS)	CECO CORP INSULATED METAL DOOR 1 1/2" - HR FIRE RATED 1 1/2" x 7' PINDOW WITH 1/4" WIRE GLASS	7'x4" x 7'x4"	PASSAGE LOCKSET EXT CENTER STRIKE BY FRAME EXECUTION AND FINISH SERIES 9190 LBL	HAGER 1250 4 1/2" x 4 1/2" (REEDS) SCREW TYPE PRIME COATED	—	—	—	HR 8A PERIMETER SEAL	—
H14	CHASE ACCESS	CECO CORP INSULATED METAL DOOR 1 1/2" - HR FIRE RATED 1 1/2" x 7' PINDOW WITH 1/4" WIRE GLASS	7'x4" x 7'x4"	PASSAGE LOCKSET EXT CENTER STRIKE BY FRAME EXECUTION AND FINISH SERIES 9190 LBL	HAGER 1250 4 1/2" x 4 1/2" (REEDS) SCREW TYPE PRIME COATED	—	—	—	HR 8A PERIMETER SEAL	—

NOTE: ITEMS IDENTIFIED WITH UPPER CASE TEXT ARE PROPOSED.
Items identified with Mixed Case Text are Existing.

MUNICIPAL AUTHORITY OF THE CITY OF MCKEEESPORT
ALLENTOWN COUNTY, PENNSYLVANIA 16102
CONTRACT NUMBER 2016-01 AND 2010-02
WASTEWATER TREATMENT PLANT EXPANSION
HEADWORKS BUILDING MECHANICAL SECTION B

KLH


KLH ENGINEERS, INC.

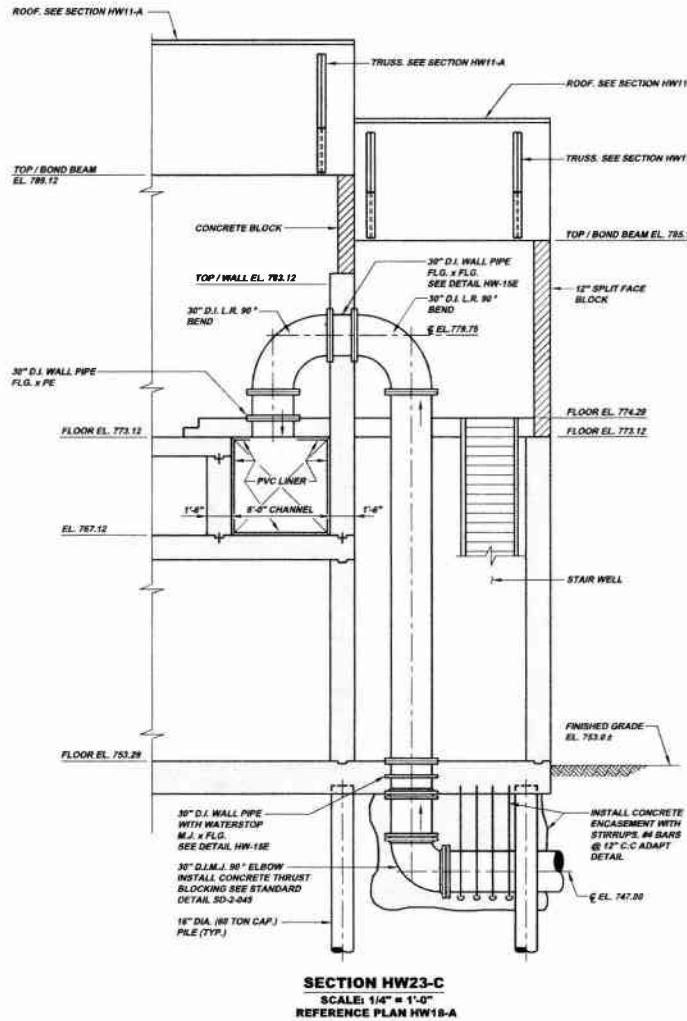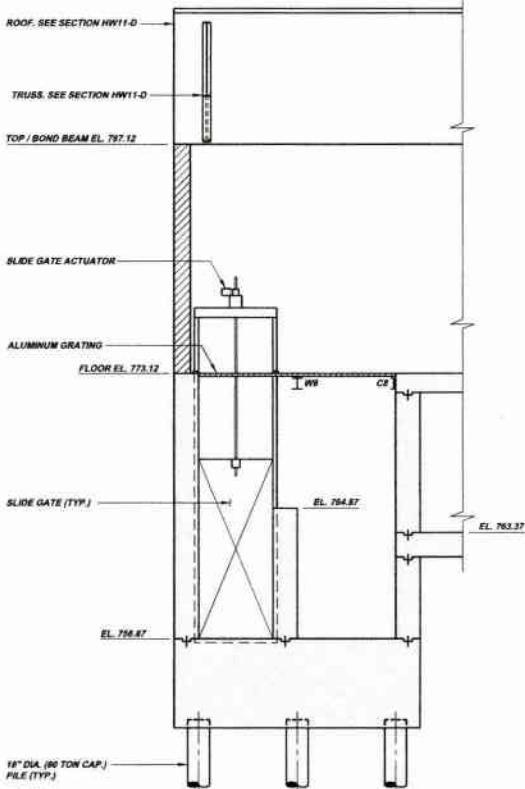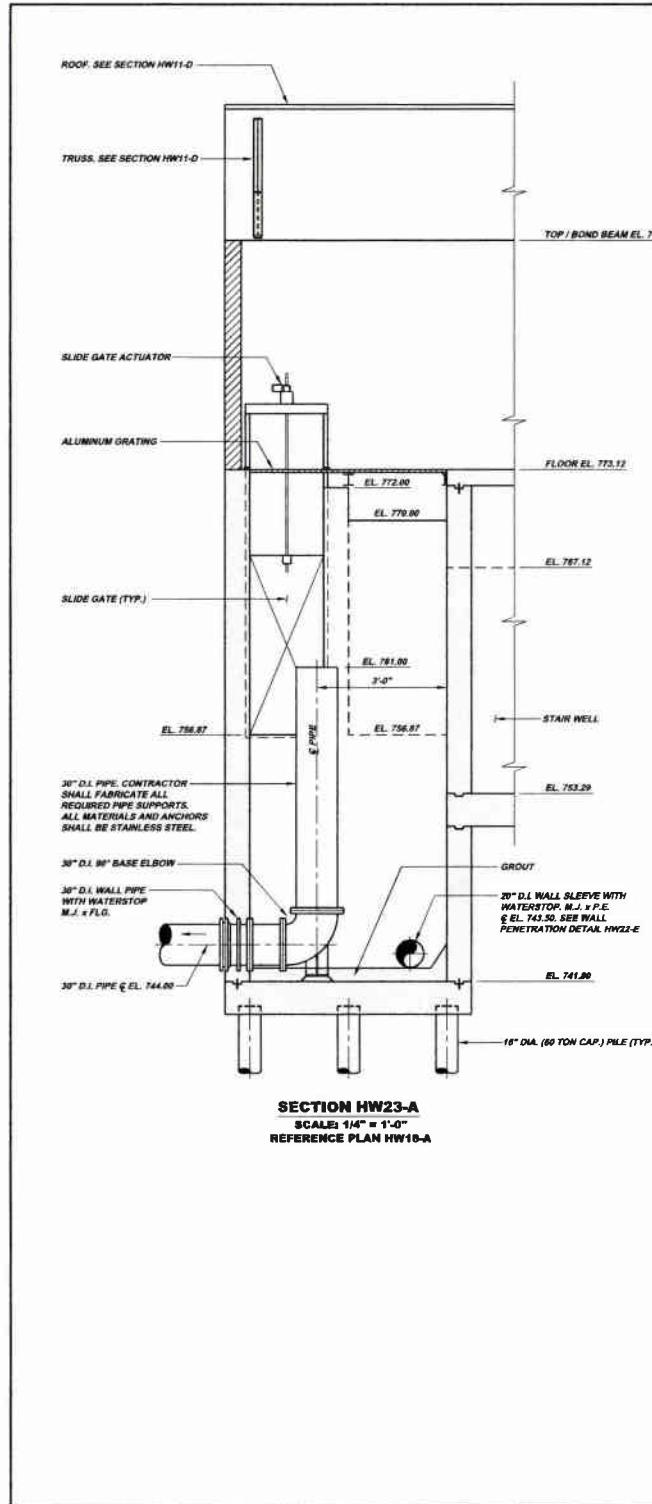













MUNICIPAL AUTHORITY OF THE CITY OF MCKEEESPORT ALLENTOWN COUNTY, PENNSYLVANIA CONTRACT NUMBER 2010-01 AND 2010-02 WASTEWATER TREATMENT PLANT EXPANSION HEADWORKS BUILDING MECHANICAL SECTION		Revisions	Date	Revisions	Date
S172 Campbells Run Road Pittsburgh, PA 15236 TEL: 412-292-0430 FAX: 412-292-0436 INFO@KLHENGINEERS.COM					
7/17/08	DRP SUBMITTAL				
7/17/08	REVISED				
7/17/08	REVISED				
7/17/08	REVISED				
7/17/08	RELEASE FOR BID				


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ITEMS IDENTIFIED WITH UPPER CASE TEXT ARE PROPOSED.
Items Identified with Mixed Case Text are Existing.


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Drawing No.
220-HW23

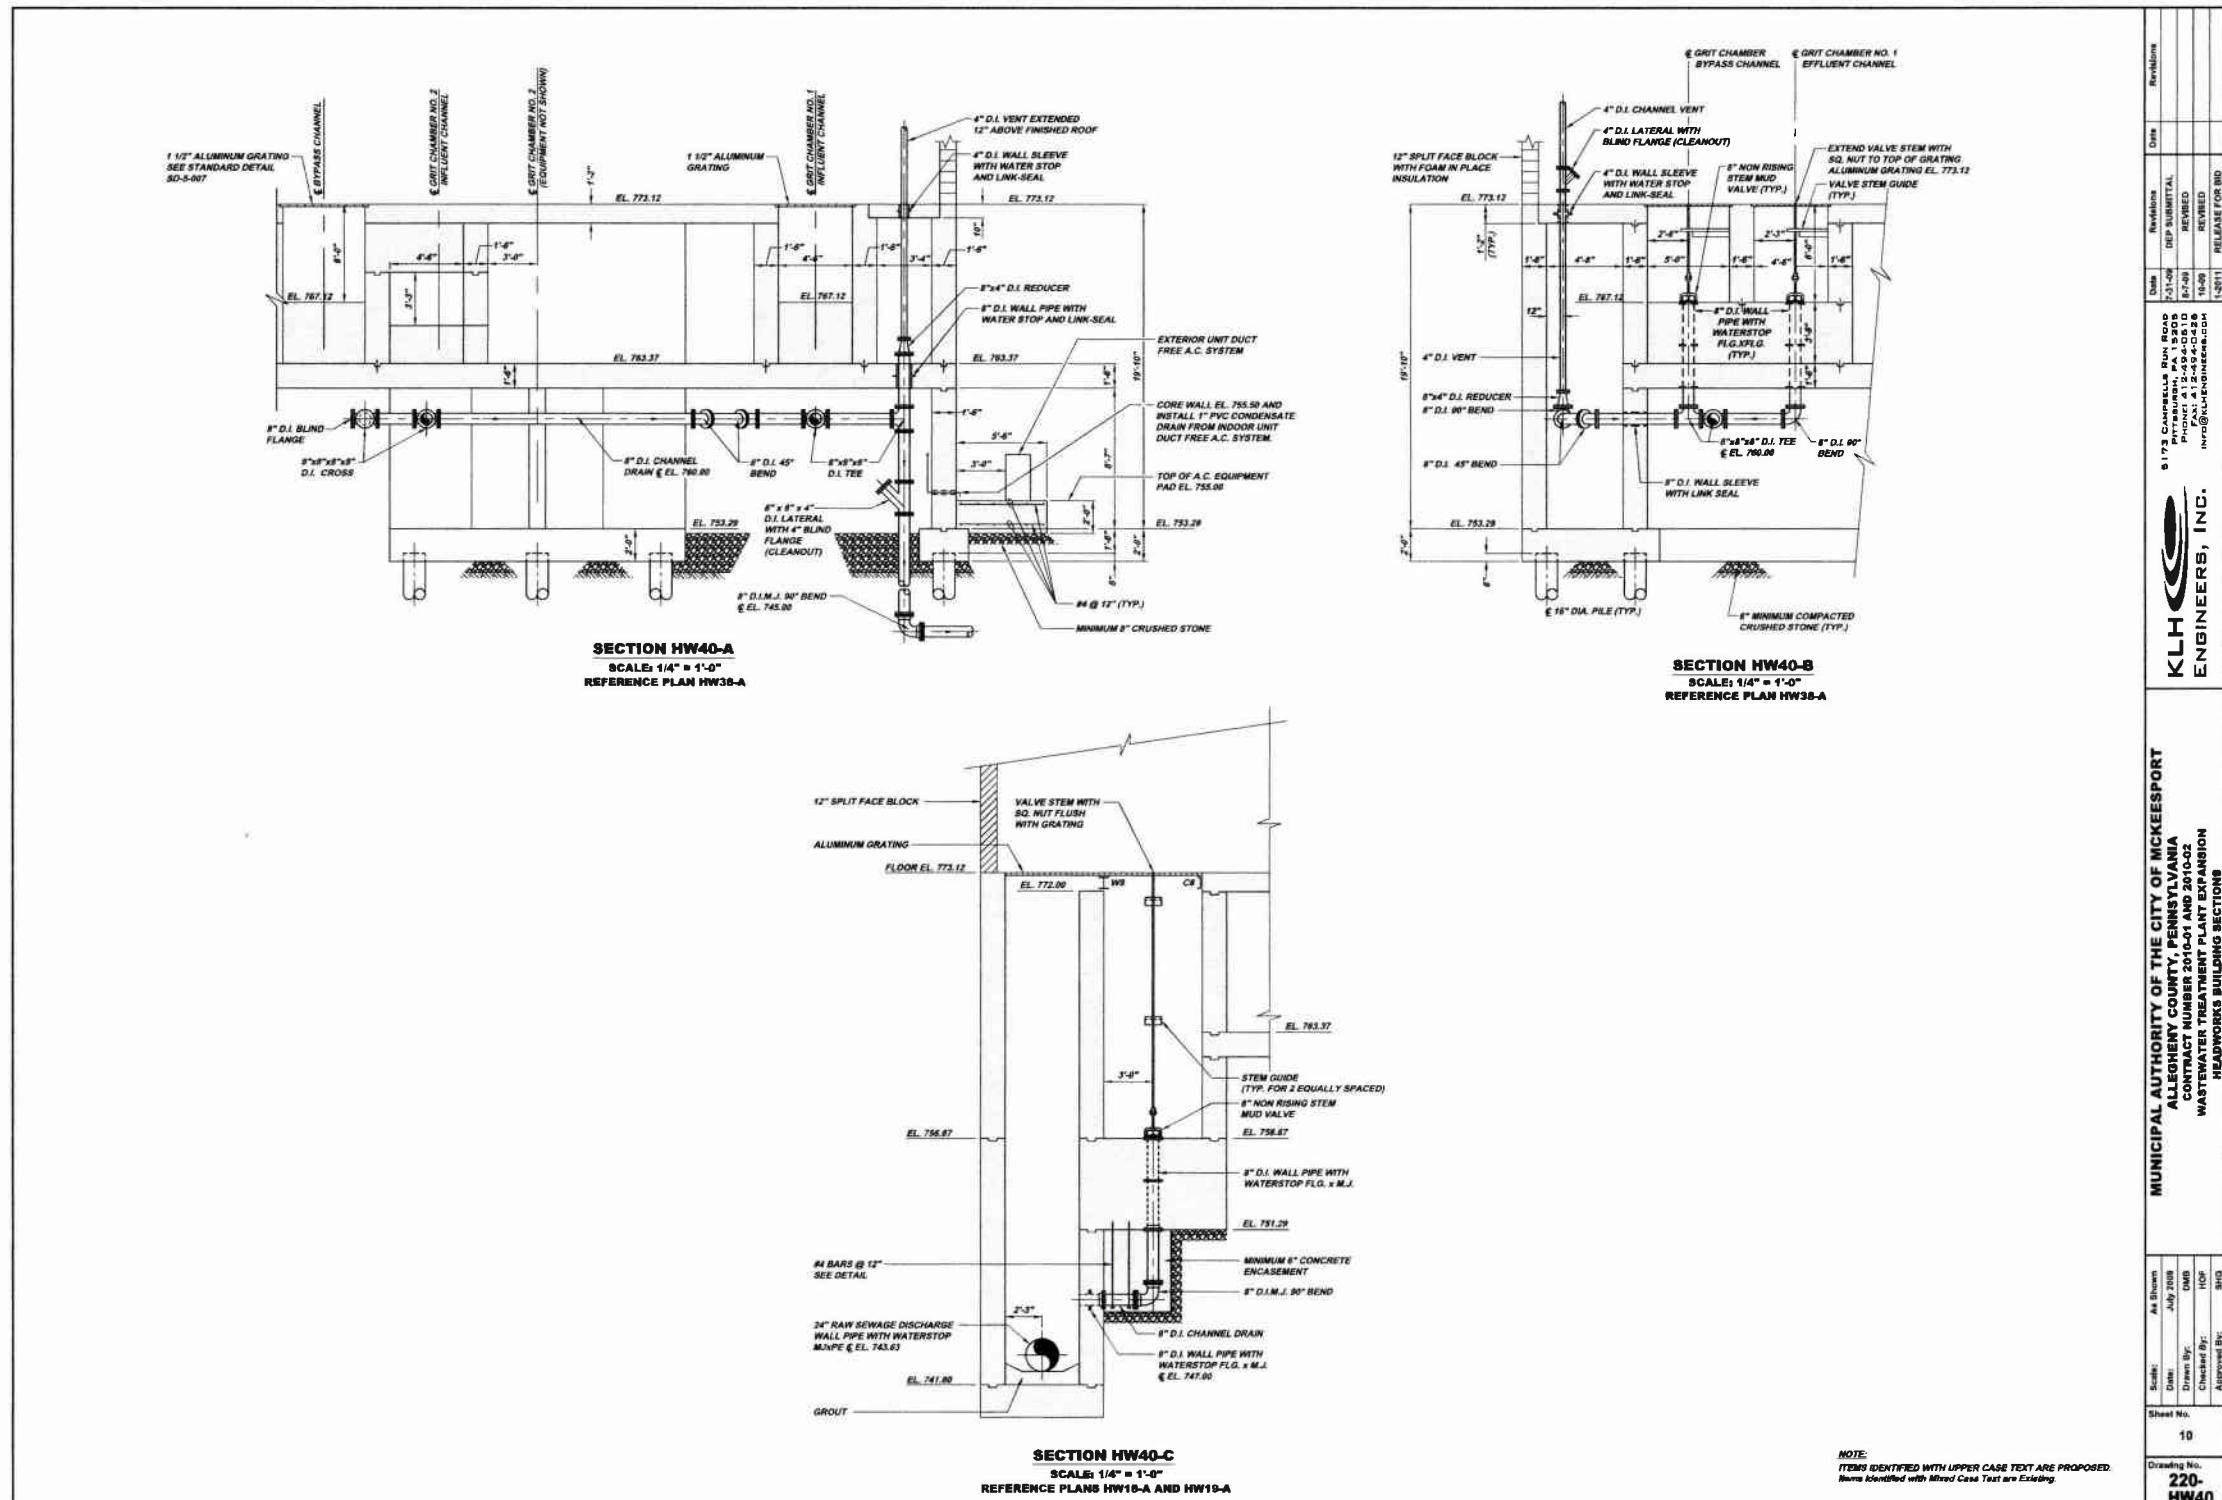


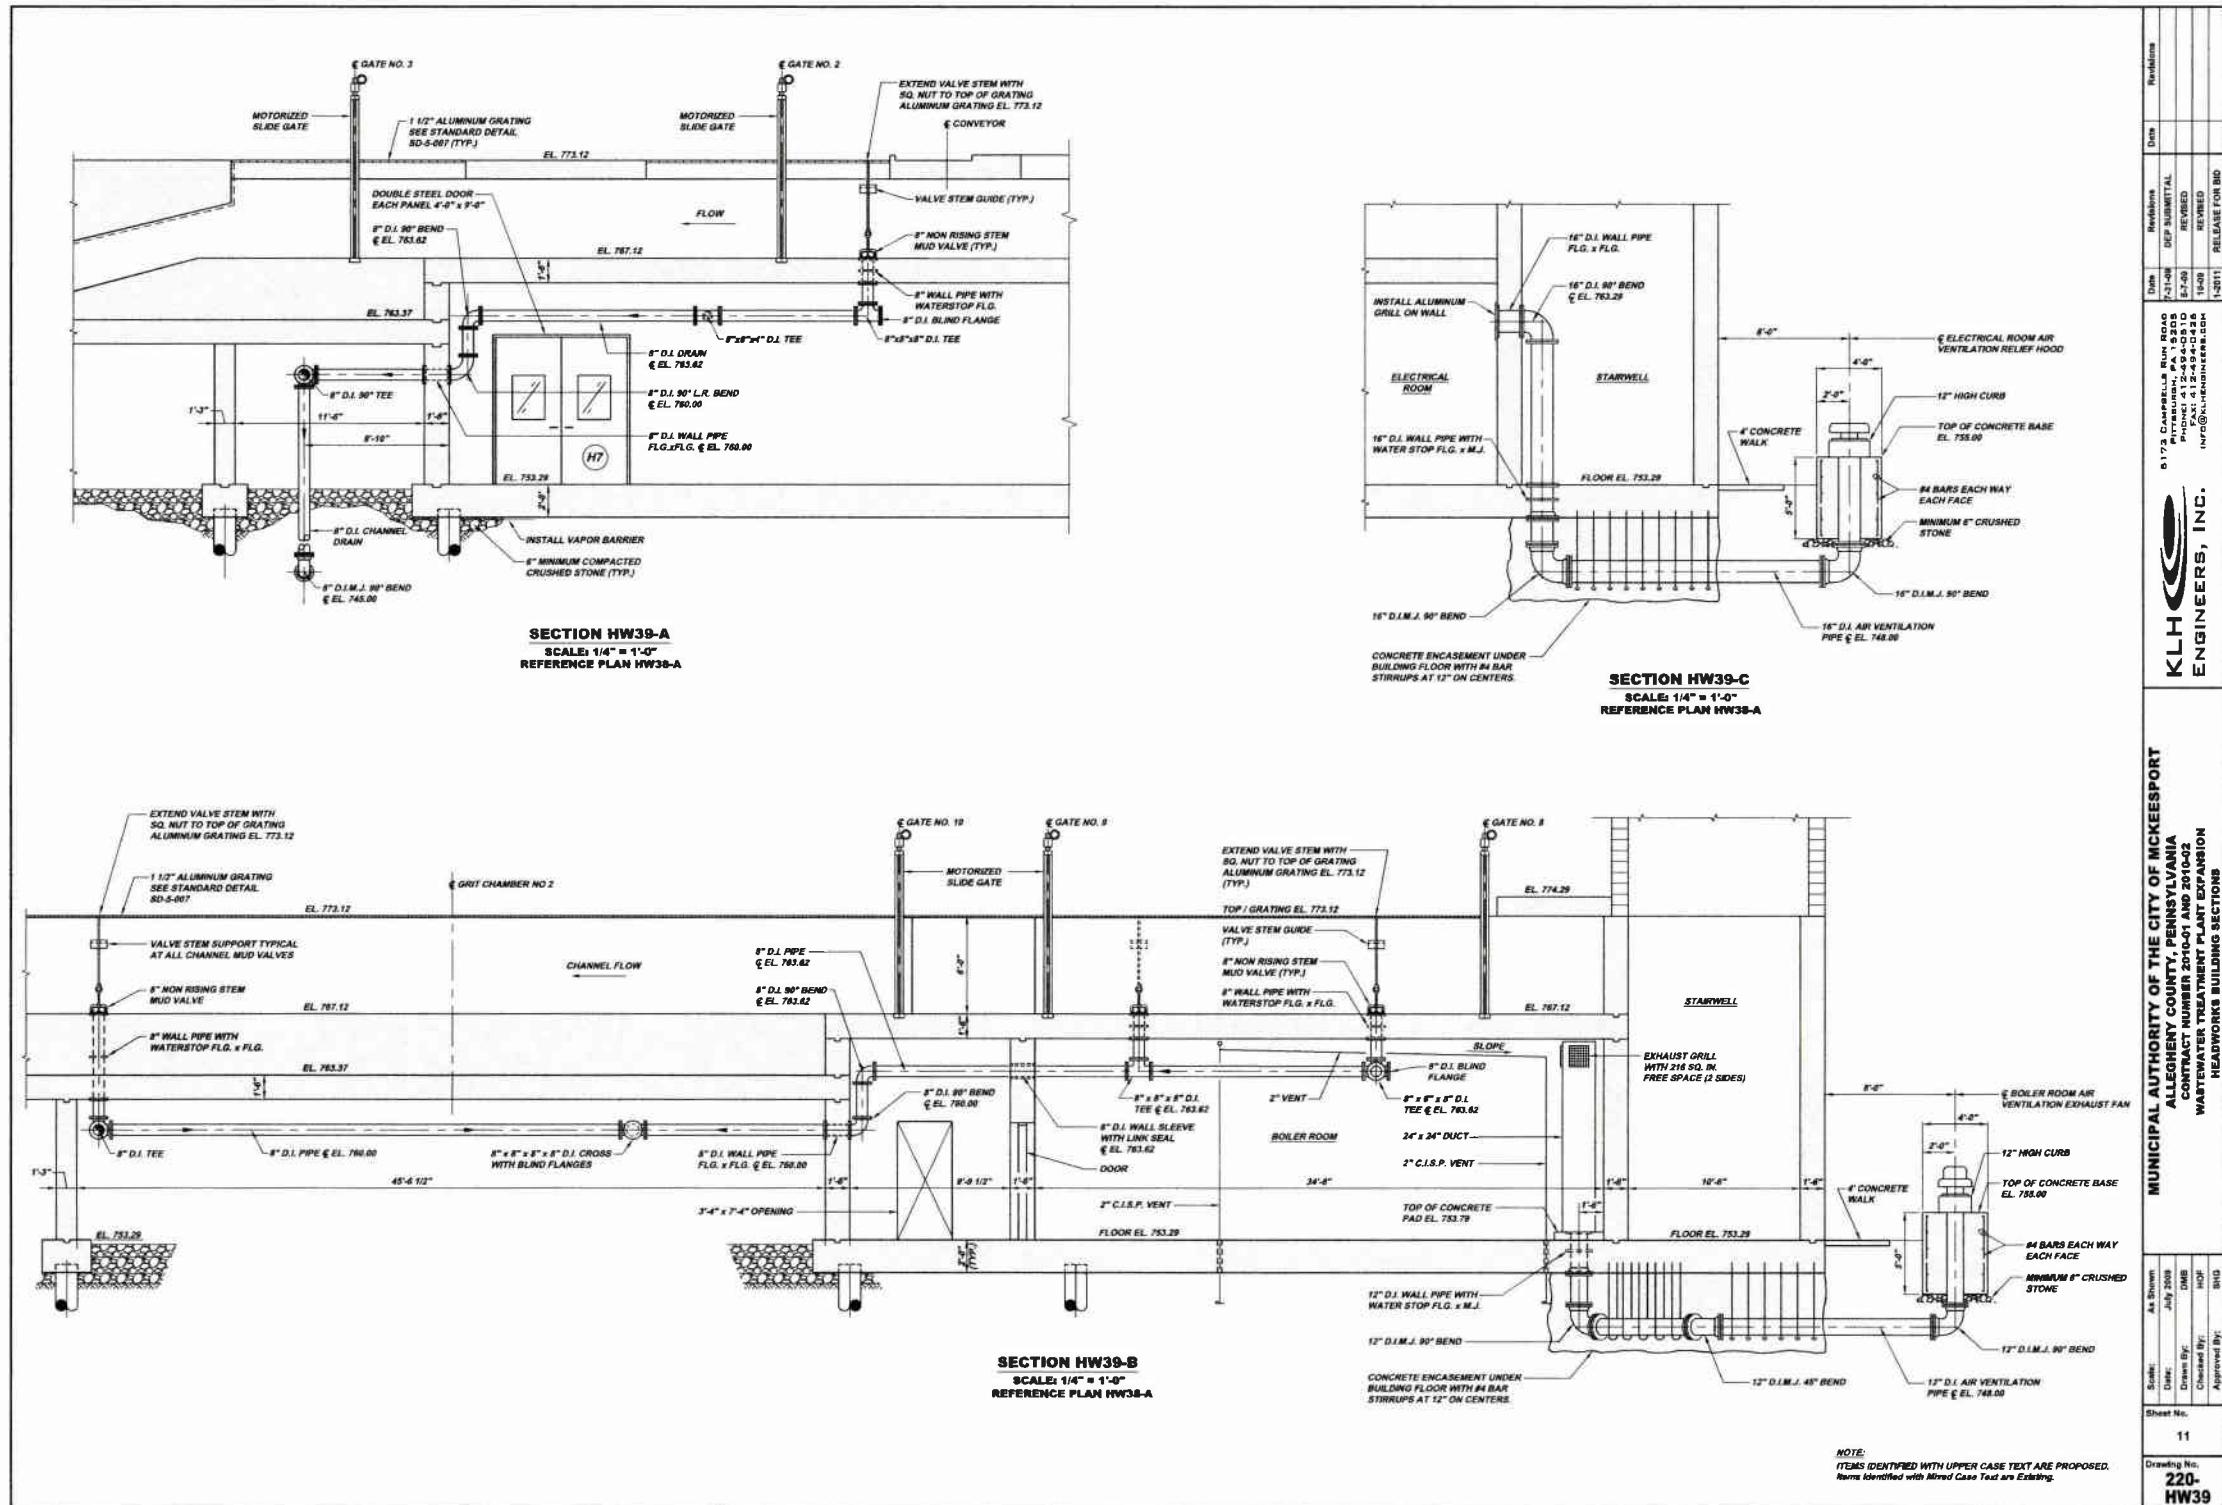


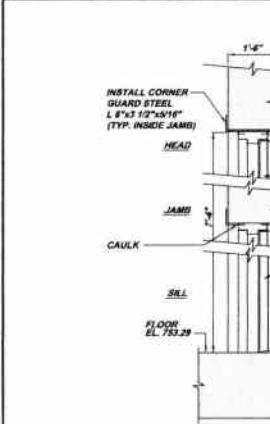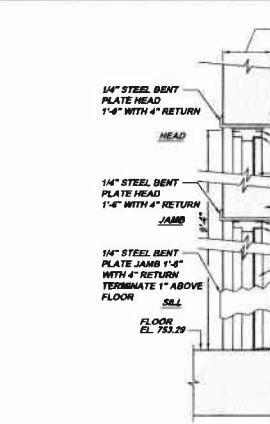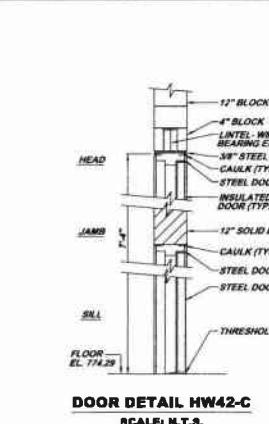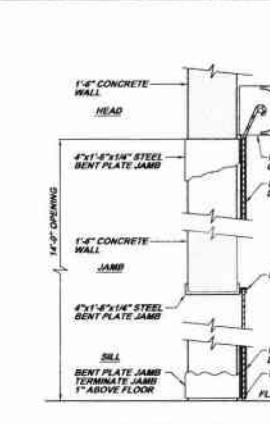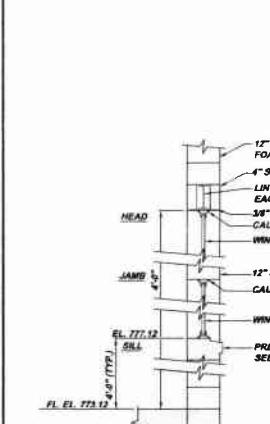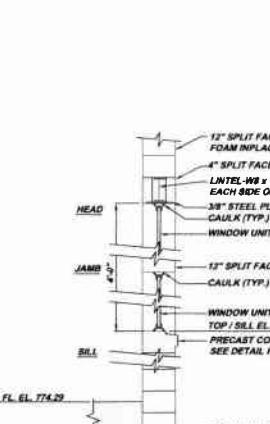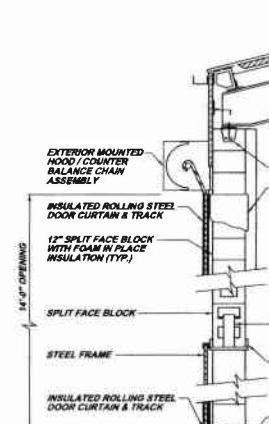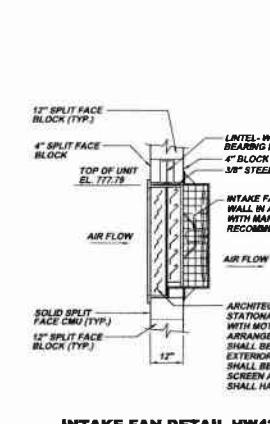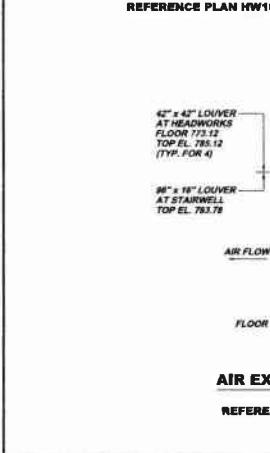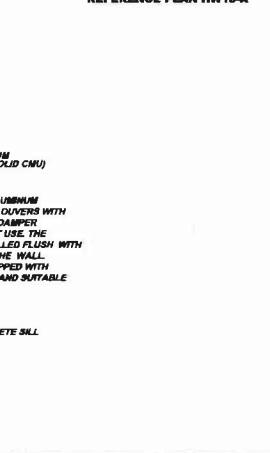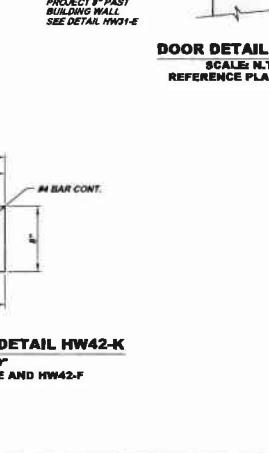 <p>DOOR DETAIL HW42-A SCALE: N.T.S. REFERENCE ELEVATION HW1-A, HW1-B, HW2-A AND ELEVATION HW2-B</p>	 <p>DOOR DETAIL HW42-B SCALE: N.T.S. REFERENCE PLAN HW38-A</p>	 <p>DOOR DETAIL HW42-C SCALE: N.T.S. REFERENCE PLAN HW18-A</p>	 <p>DOOR DETAIL HW42-D SCALE: N.T.S. REFERENCE ELEVATION HW2-A</p>				
 <p>WINDOW DETAIL HW42-E SCALE: N.T.S. REFERENCE PLAN HW18-A</p>	 <p>WINDOW DETAIL HW42-F SCALE: N.T.S. REFERENCE PLAN HW18-A</p>	 <p>DOOR DETAIL HW42-G SCALE: N.T.S. REFERENCE PLAN HW18-A</p>	 <p>INTAKE FAN DETAIL HW42-H SCALE: N.T.S. REFERENCE PLAN HW18-A</p>				
 <p>AIR EXHAUST LOUVER DETAIL HW42-J SCALE: N.T.S. REFERENCE PLAN HW18-A AND ELEVATION HW1-B</p>	 <p>PREFAST CONCRETE SILL DETAIL HW42-K SCALE: 1 1/2'-1'0" REFERENCE DETAIL HW42-E AND HW42-F</p>	 <p>INTAKE FAN DETAIL HW42-L SCALE: N.T.S. REFERENCE PLAN HW18-A</p>	<table border="1" style="width: 100%; border-collapse: collapse;"> <thead> <tr> <th style="text-align: left; padding-bottom: 5px;">MUNICIPAL AUTHORITY OF THE CITY OF MCKEESPORT ALLENTOWN COUNTY, PENNSYLVANIA CONTRACT NUMBER 2010-01 AND 2010-02 WASTEWATER TREATMENT PLANT EXPANSION HEADWORKS BUILDING DETAILS</th> </tr> </thead> <tbody> <tr> <td style="padding-top: 5px; vertical-align: top;"> <p>Sheet No.: 12 Drawing No.: 220- NOTE: ITEMS IDENTIFIED WITH UPPERCASE TEXT ARE PROPOSED. ITEMS IDENTIFIED WITH MIXED CASE TEXT ARE EXISTING.</p> </td> </tr> <tr> <td style="padding-top: 5px; vertical-align: top;"> <p>Scale: As Shown Date: April 2009 Drawn By: DMB Checked By: HOF Approved By: SHG</p> </td> </tr> <tr> <td style="padding-top: 5px; vertical-align: top;"> <p>Date: 7-1-09 Revolution: DEP SUBMITTAL Refined: 7-1-09 Reviewed: 7-1-09 FAX: 1-212-942-4500 INFO@KLHENGINEERS.COM Version: 1-2011 RELEASE FOR BID</p> </td> </tr> </tbody> </table>	MUNICIPAL AUTHORITY OF THE CITY OF MCKEESPORT ALLENTOWN COUNTY, PENNSYLVANIA CONTRACT NUMBER 2010-01 AND 2010-02 WASTEWATER TREATMENT PLANT EXPANSION HEADWORKS BUILDING DETAILS	<p>Sheet No.: 12 Drawing No.: 220- NOTE: ITEMS IDENTIFIED WITH UPPERCASE TEXT ARE PROPOSED. ITEMS IDENTIFIED WITH MIXED CASE TEXT ARE EXISTING.</p>	<p>Scale: As Shown Date: April 2009 Drawn By: DMB Checked By: HOF Approved By: SHG</p>	<p>Date: 7-1-09 Revolution: DEP SUBMITTAL Refined: 7-1-09 Reviewed: 7-1-09 FAX: 1-212-942-4500 INFO@KLHENGINEERS.COM Version: 1-2011 RELEASE FOR BID</p>
MUNICIPAL AUTHORITY OF THE CITY OF MCKEESPORT ALLENTOWN COUNTY, PENNSYLVANIA CONTRACT NUMBER 2010-01 AND 2010-02 WASTEWATER TREATMENT PLANT EXPANSION HEADWORKS BUILDING DETAILS							
<p>Sheet No.: 12 Drawing No.: 220- NOTE: ITEMS IDENTIFIED WITH UPPERCASE TEXT ARE PROPOSED. ITEMS IDENTIFIED WITH MIXED CASE TEXT ARE EXISTING.</p>							
<p>Scale: As Shown Date: April 2009 Drawn By: DMB Checked By: HOF Approved By: SHG</p>							
<p>Date: 7-1-09 Revolution: DEP SUBMITTAL Refined: 7-1-09 Reviewed: 7-1-09 FAX: 1-212-942-4500 INFO@KLHENGINEERS.COM Version: 1-2011 RELEASE FOR BID</p>							

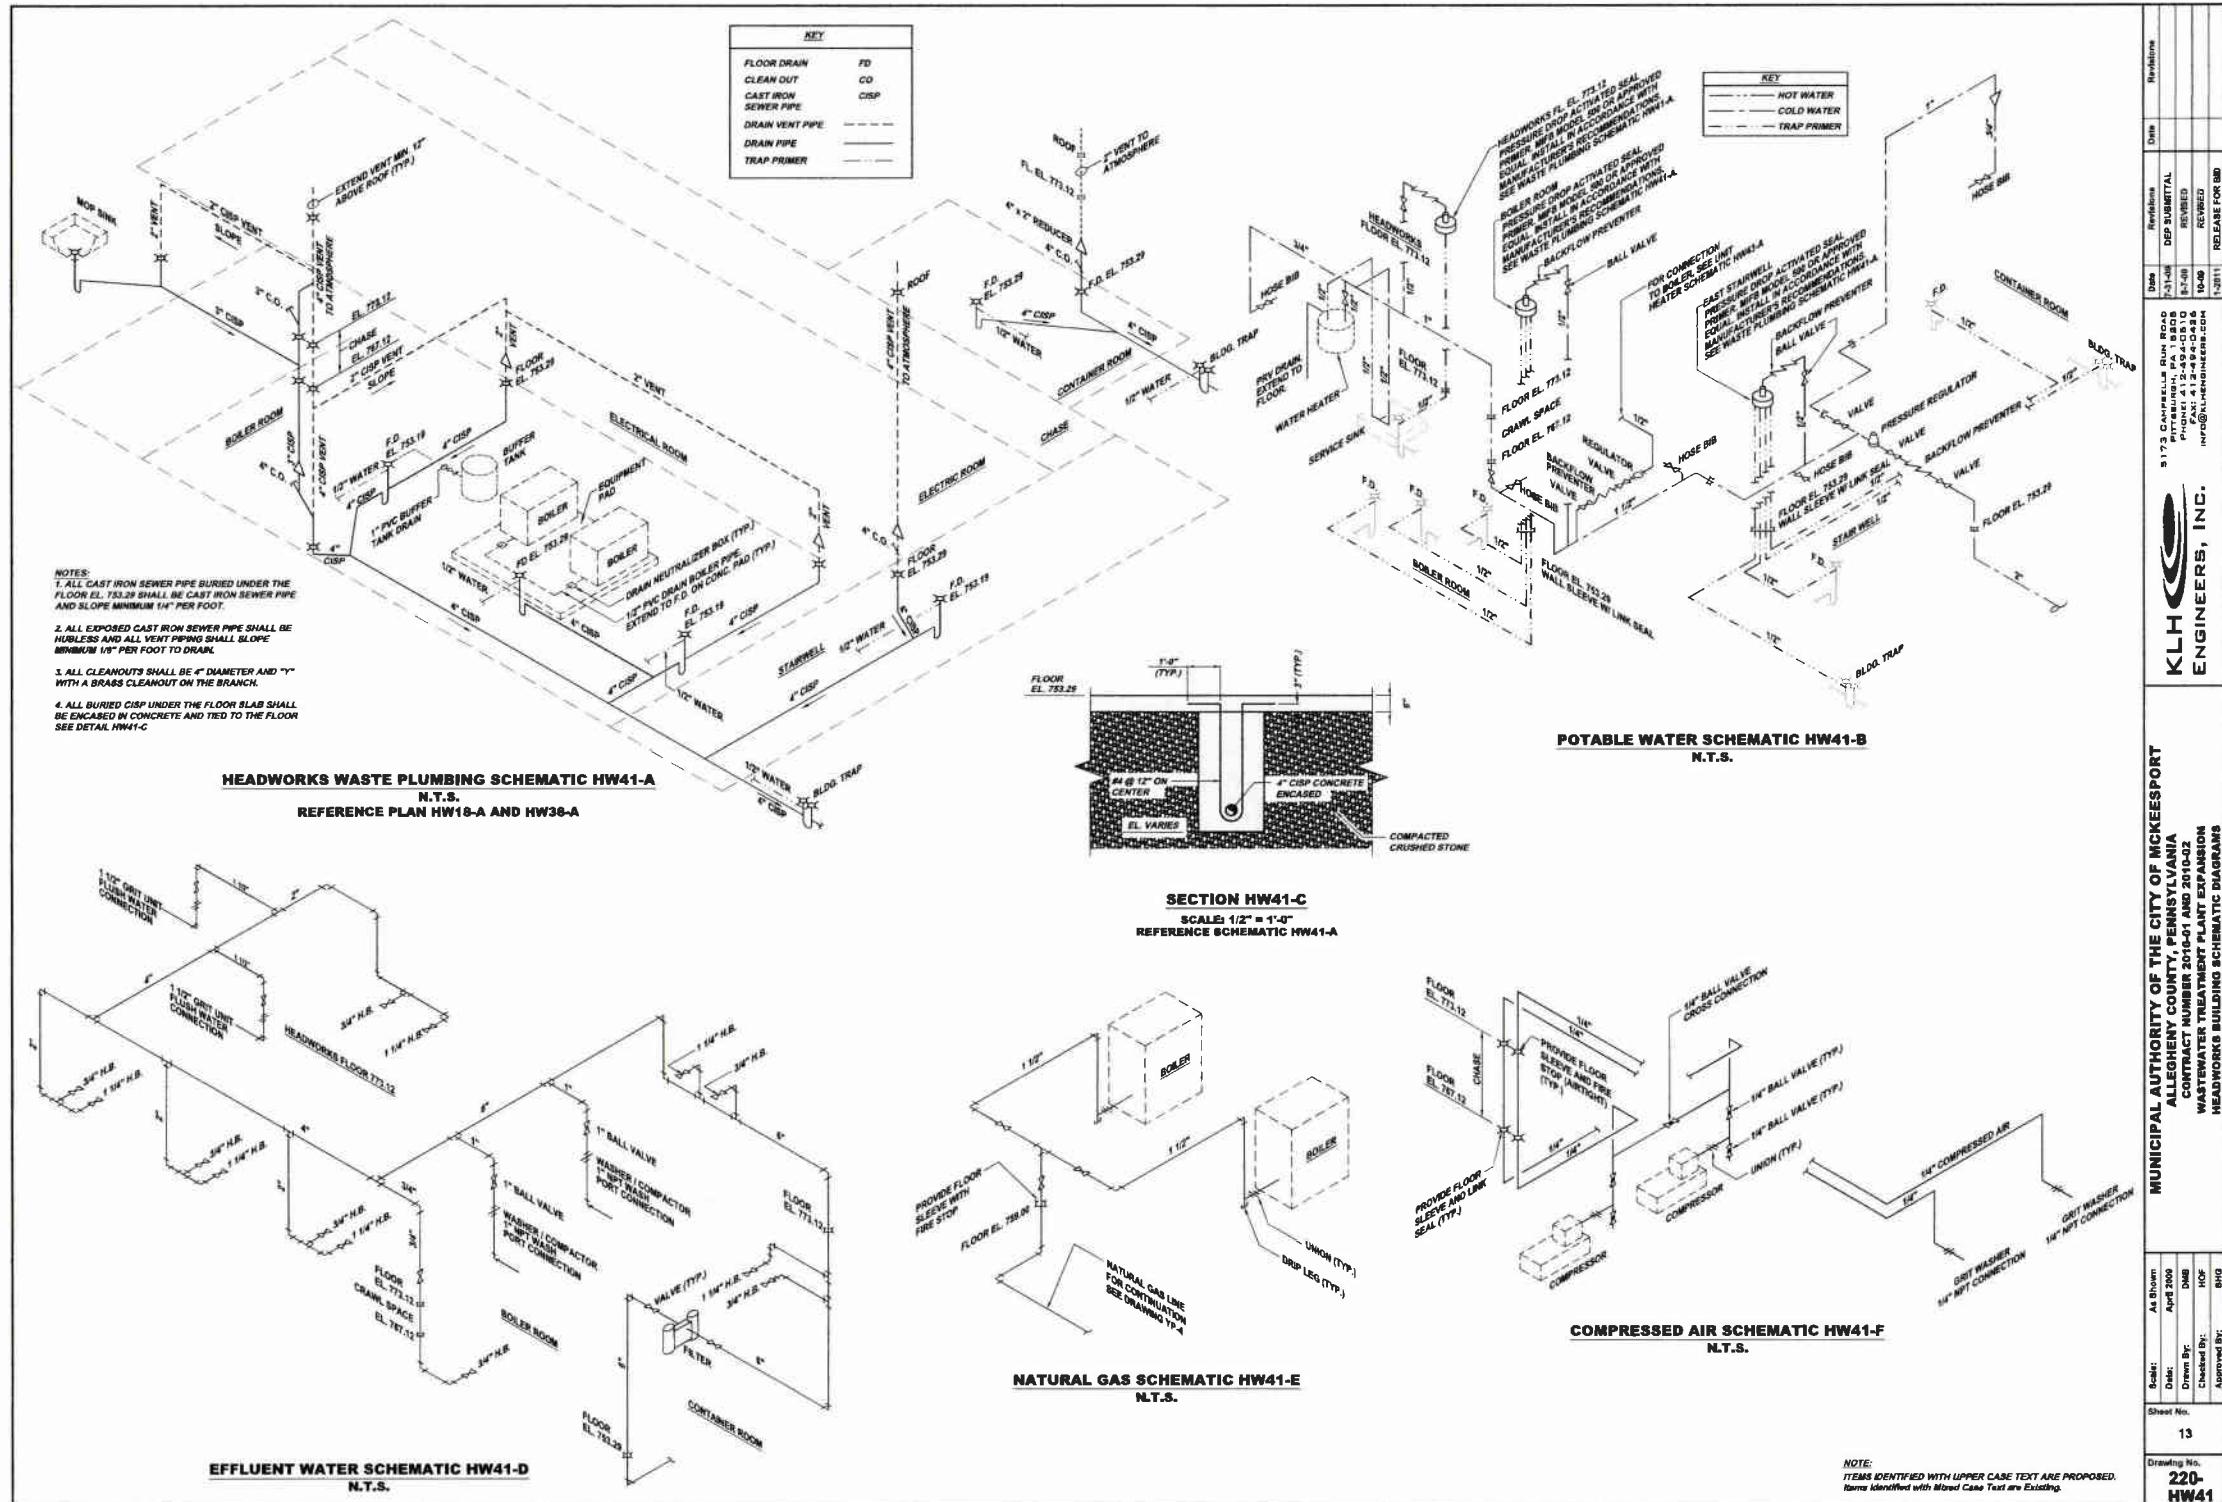


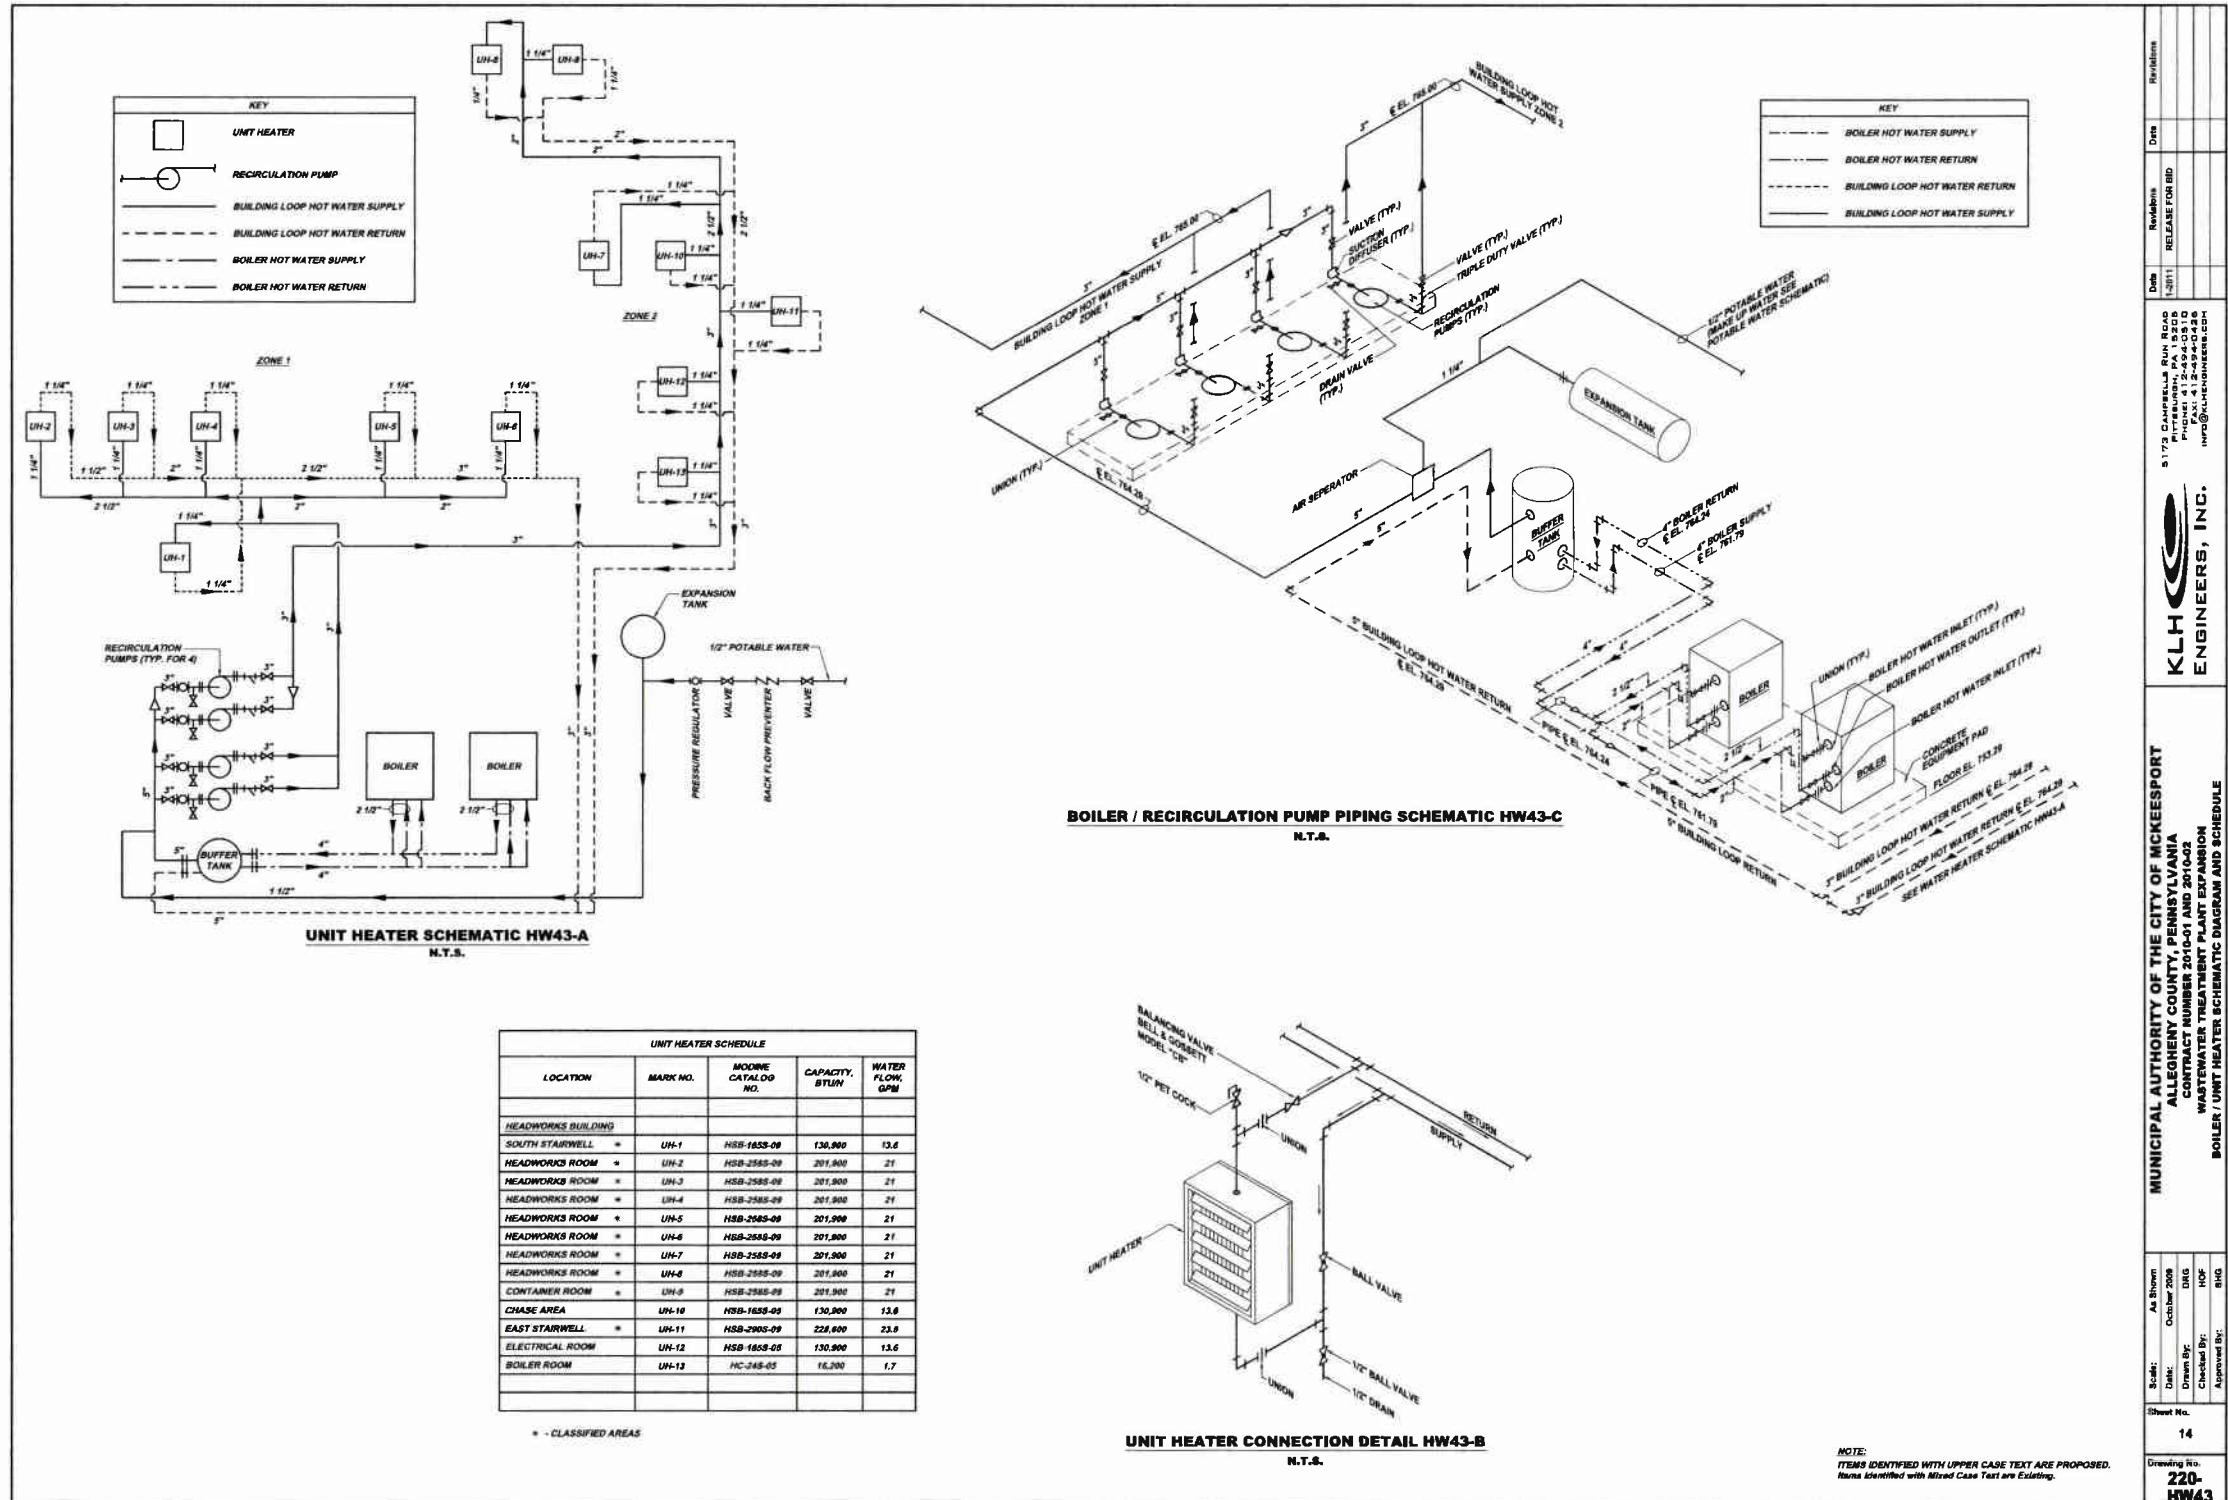

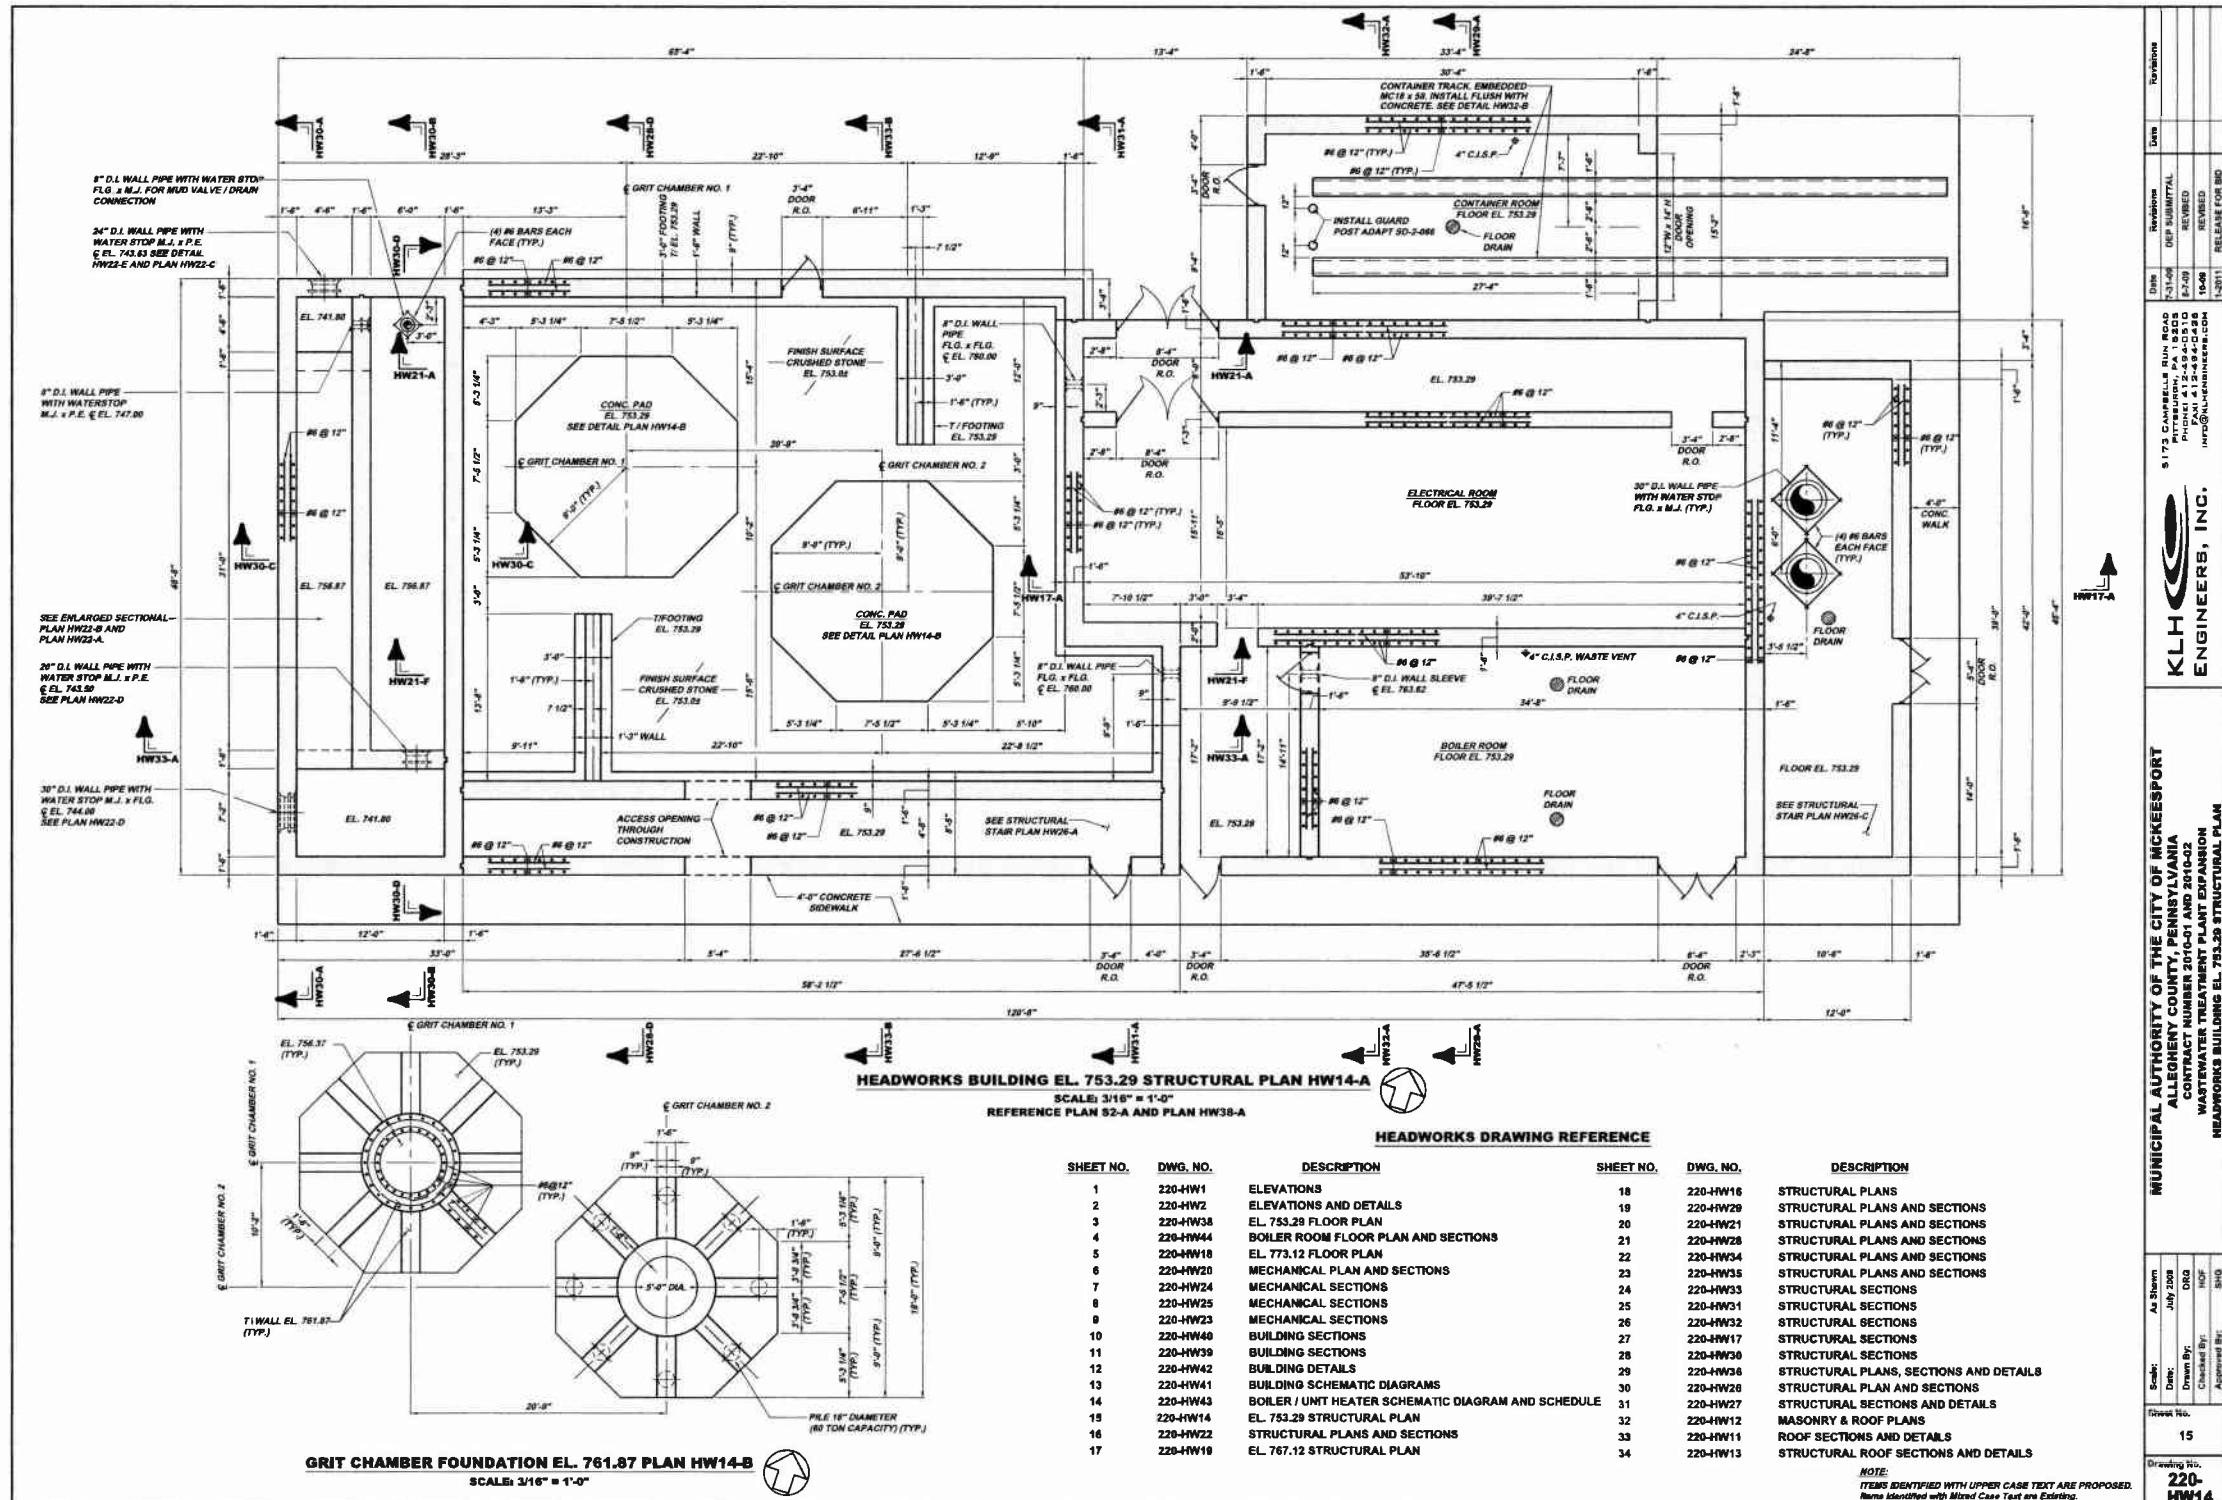


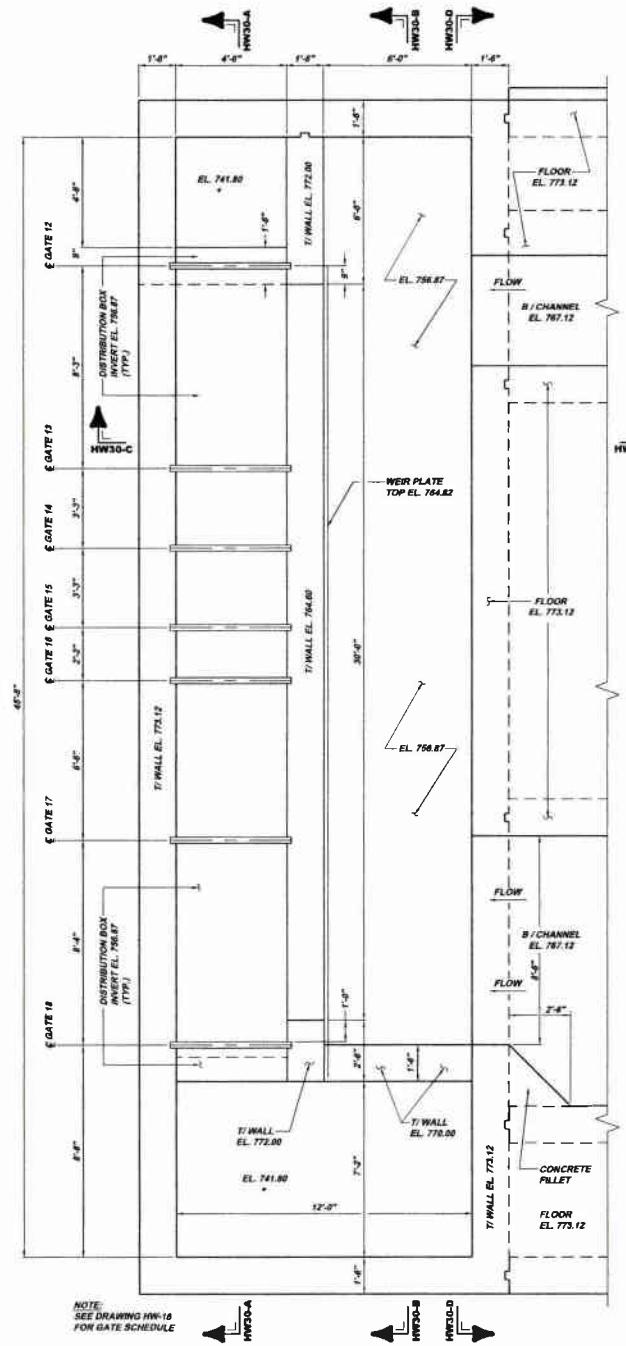


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SCALE: 3/8" = 1'-0"
REFERENCE PLAN HW16-A

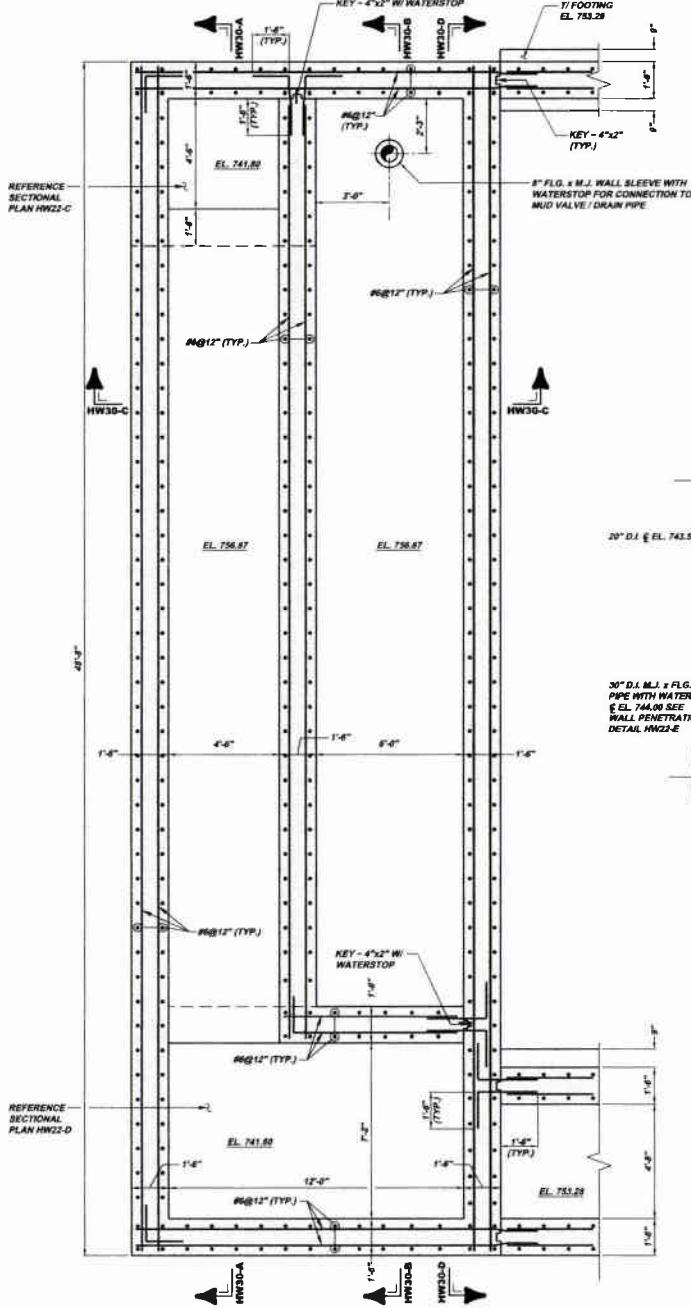


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SECTIONAL PLAN HW22-B
SCALE: 3/8" = 1'-0"
REFERENCE PLAN HW22-B

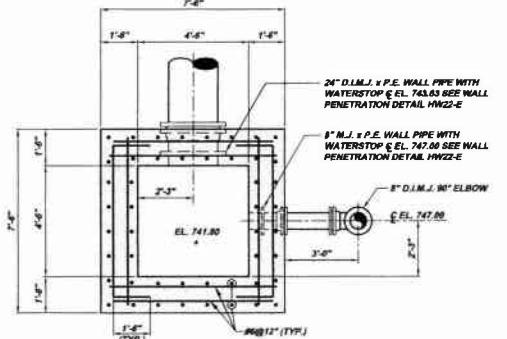

SECTIONAL PLAN HW22-C
SCALE: 3/8" = 1'-0"
REFERENCE SECTION HW30-A AND PLAN HW22-B

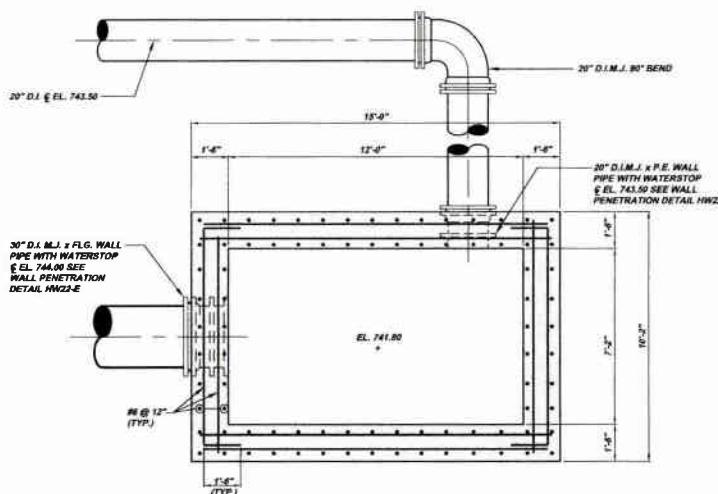



SECTIONAL PLAN HW22-D
SCALE: 3/8" = 1'-0"
REFERENCE SECTION HW30-B AND HW30-C
AND PLANS HW16-B AND HW22-D

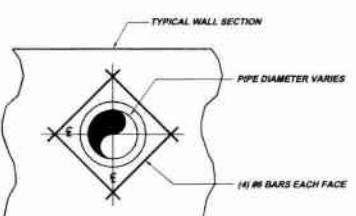


Scale:	All Shown	Revision:	
Date:	July 2000	DEP SUBMITTAL	
Drawn By:	DHB	PRINCE 11-2-98-C-0456	
Checked By:	HOF	FAIR 11-2-98-C-0456	
Approved By:	SIG	HW22-1	
Sheet No.		HEADWORKS BUILDING STRUCTURAL PLANS AND SECTIONS	
		MUNICIPAL AUTHORITY OF THE CITY OF MCKEEESPORT ALLENTOWN COUNTY, PENNSYLVANIA CONTRACT NUMBER 2010-C AND 2010-C WATER TREATMENT PLANT EXPANSION	
		KLH ENGINEERS, INC.	
		5173 Cambriaelle Run Road Pittsburgh, PA 15236 Phone: 412-961-0456 Fax: 412-961-0456 info@klhengineers.com	
		220-HW22	

NOTE:
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Items Identified with Mixed Case Text are Existing.

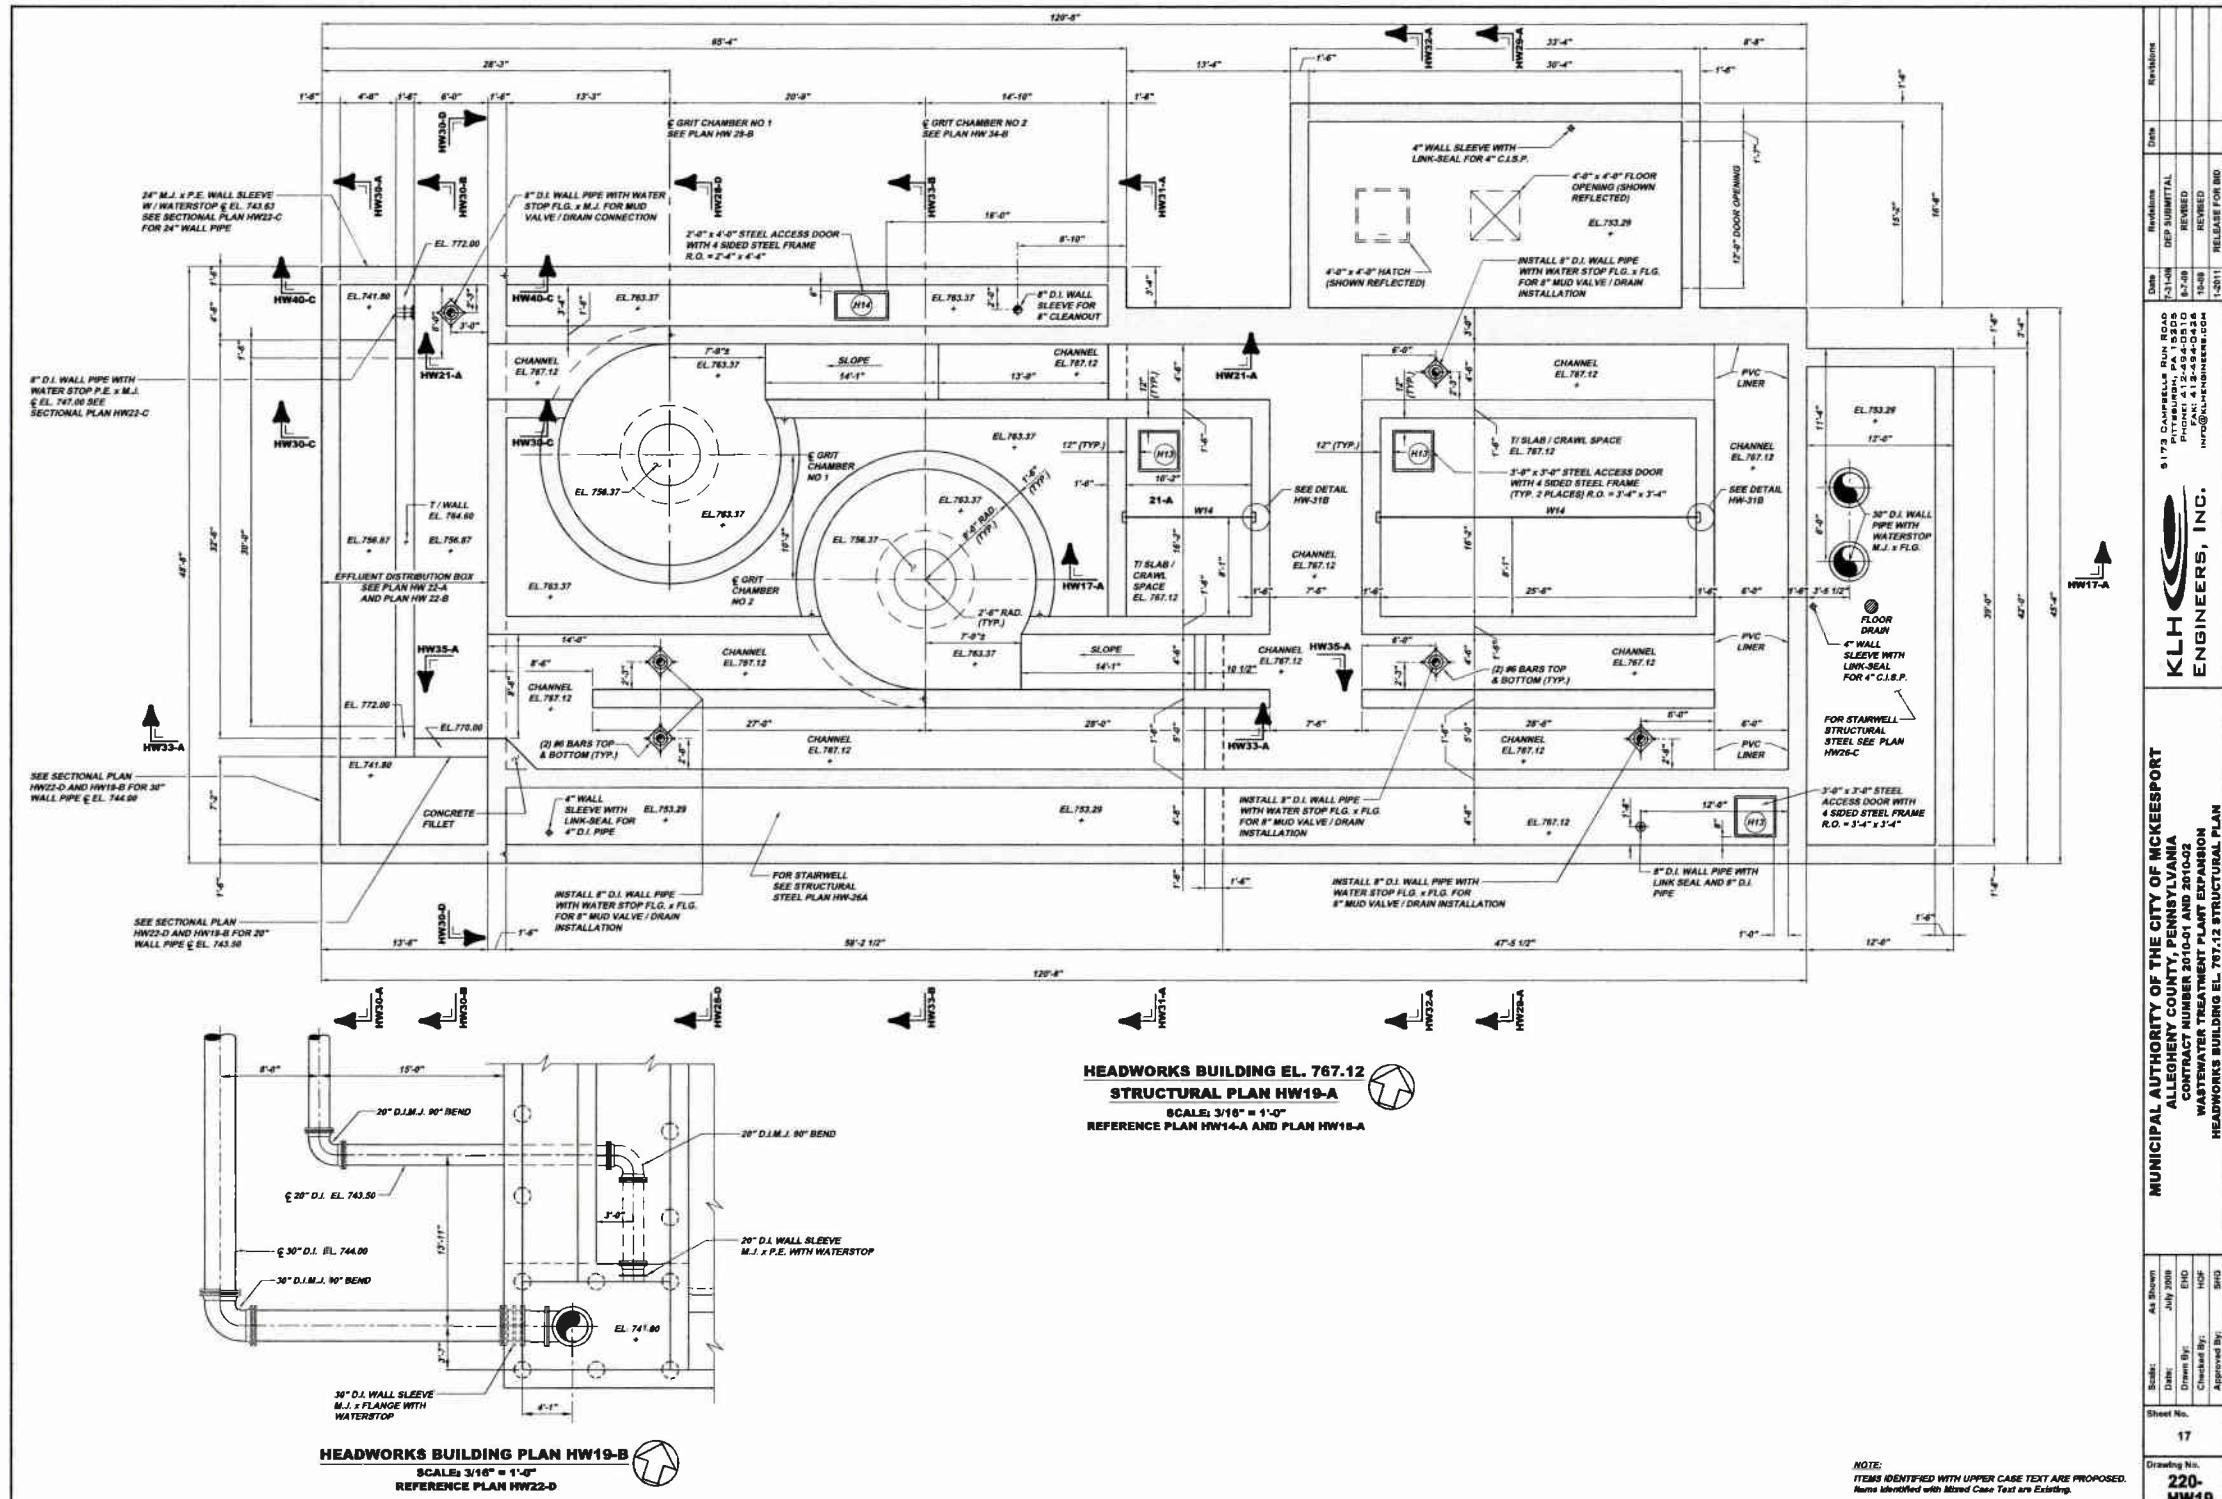


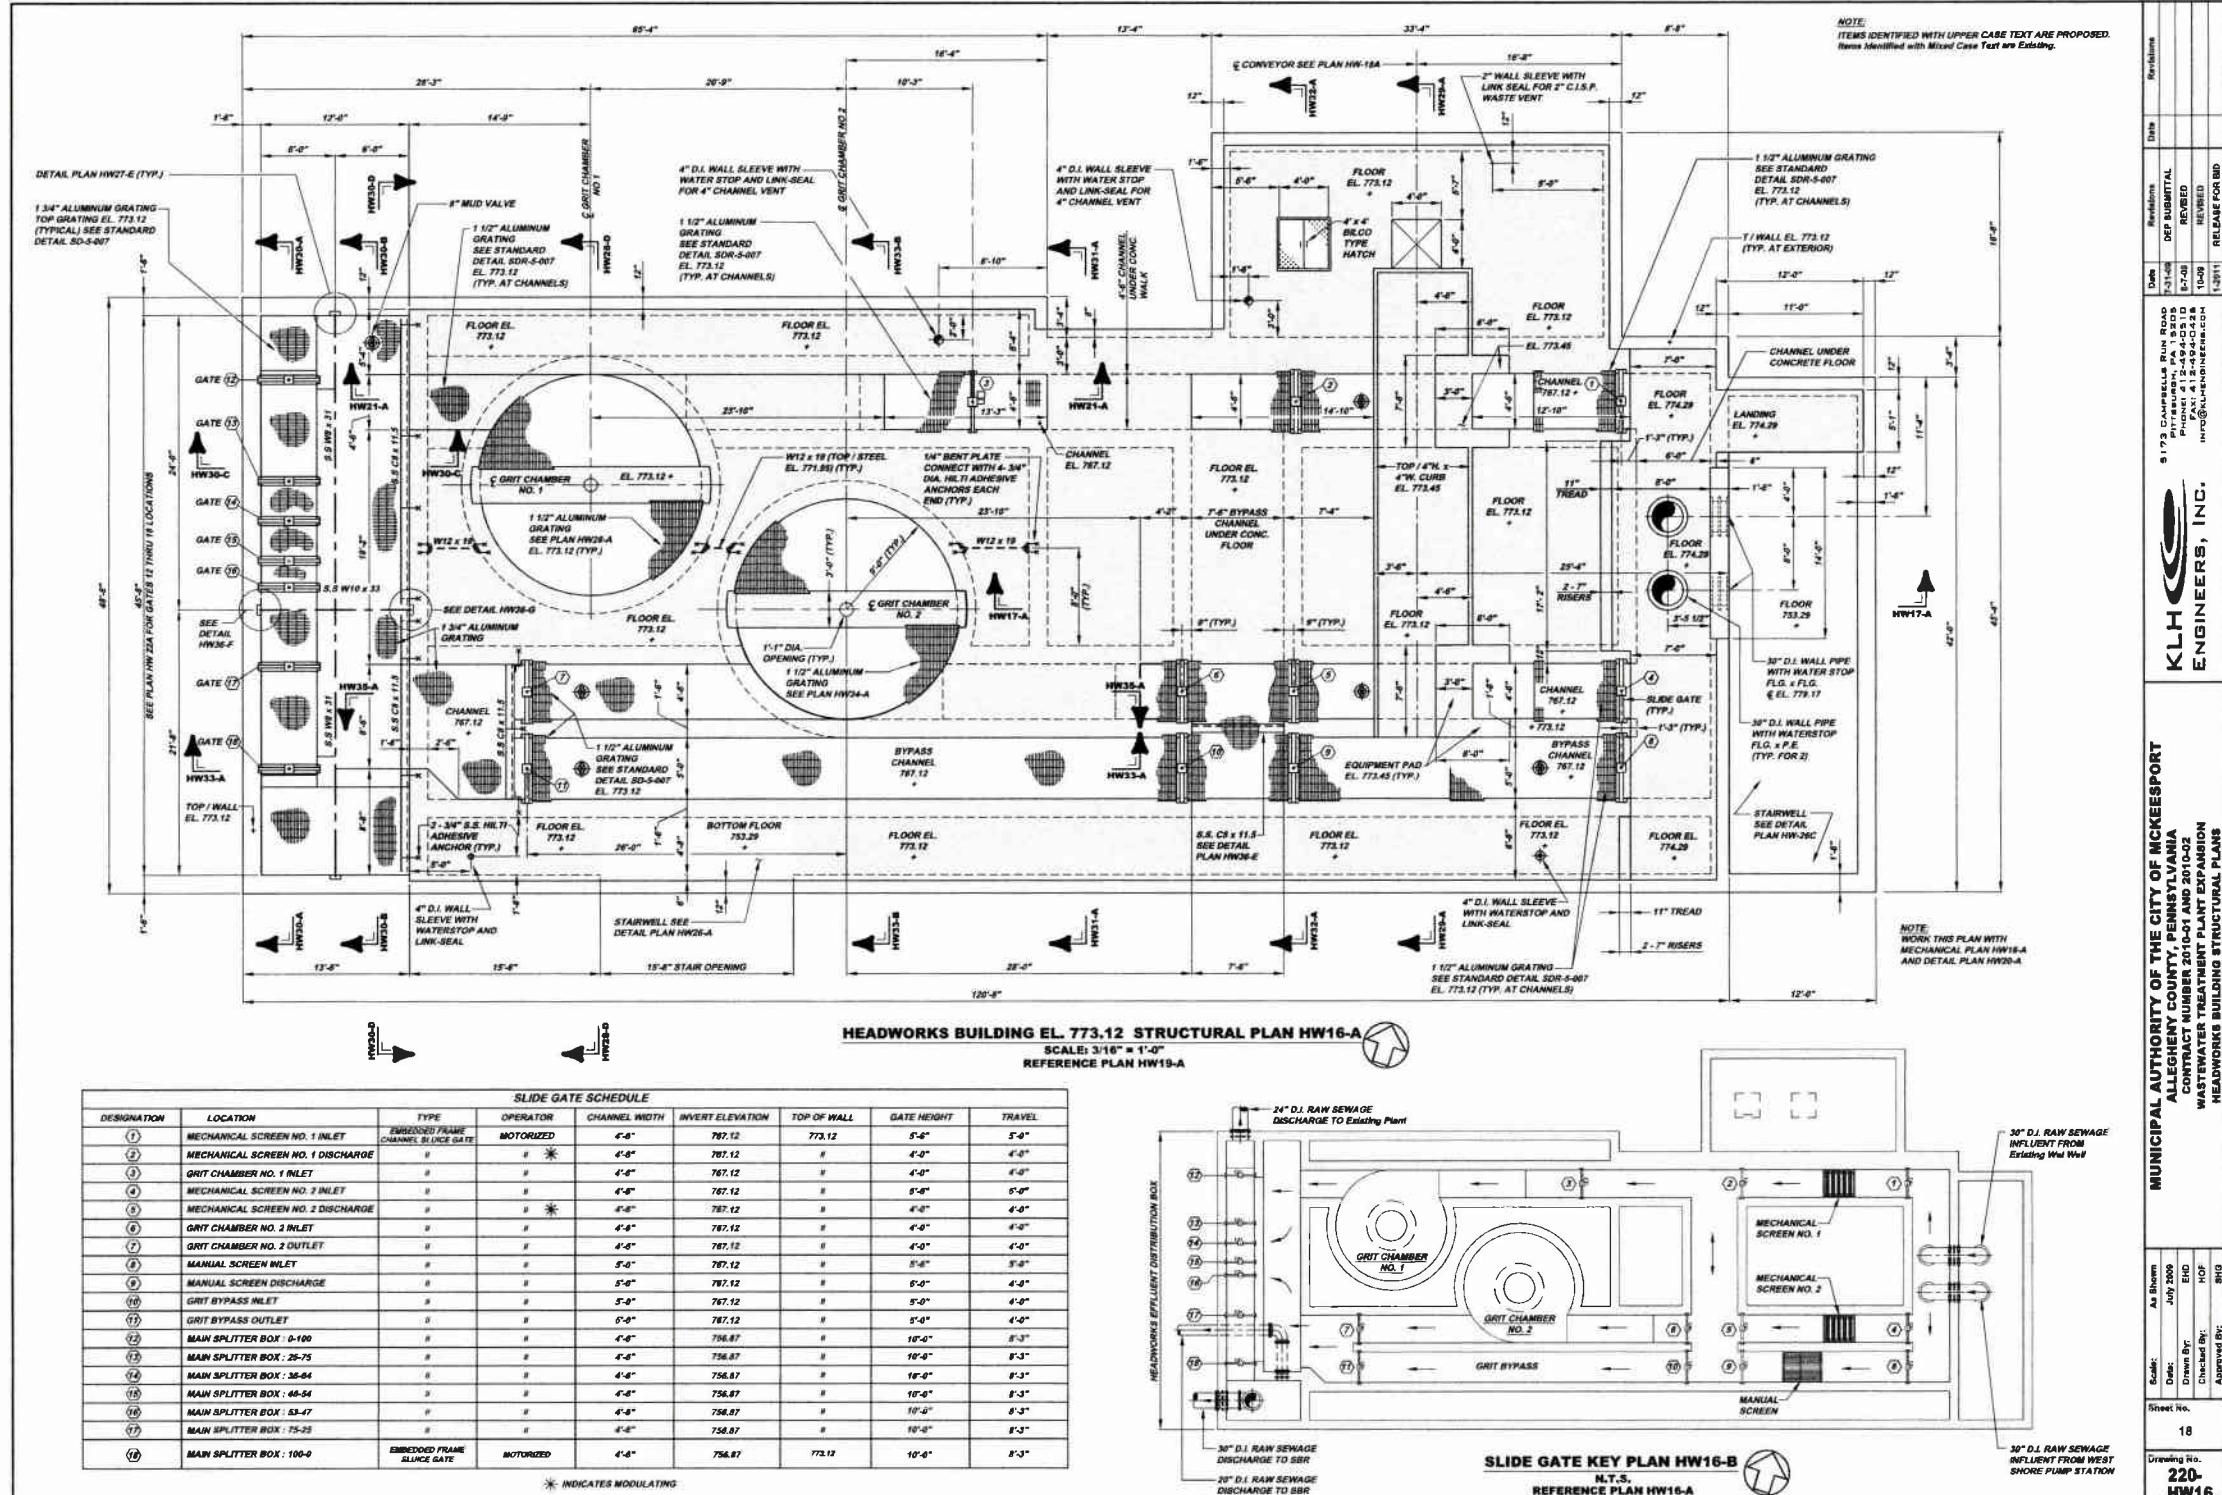

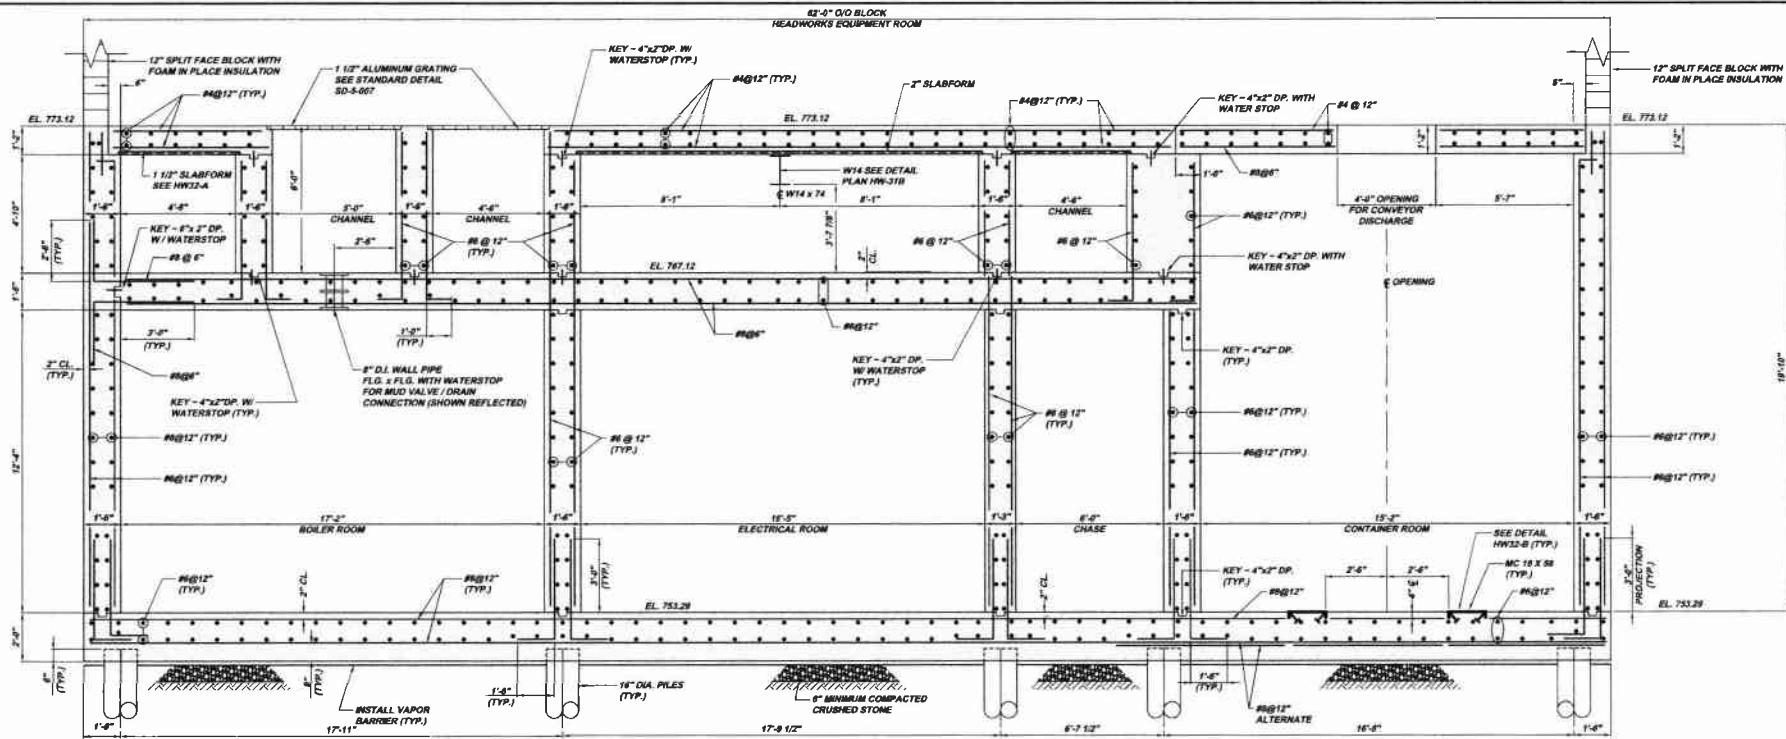

SECTION HW29-A


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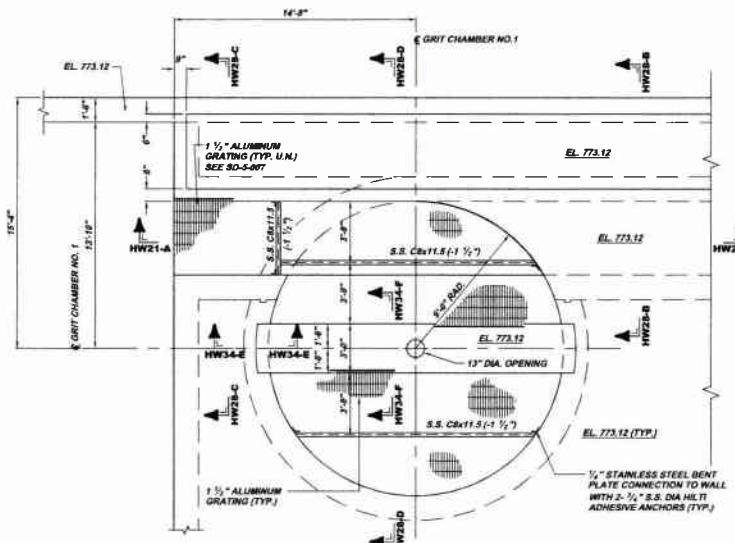


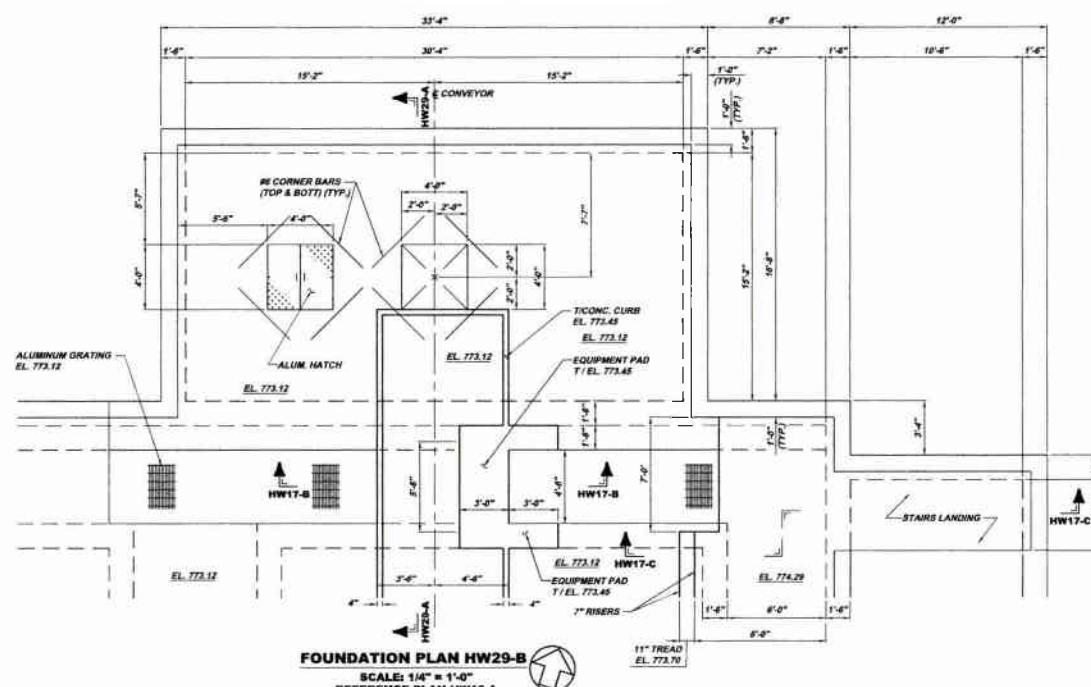**CONTRACTOR SHALL FURNISH AND INSTALL
ENSIFORM 200 WHEELING FORM DECK (18 GA.) OR
QUAL AT ALL LOCATIONS IDENTIFYING 2" SLABFORM
AND TENSALFORM 150 WHEELING FORM DECK (20 GA.)
OR EQUAL AT ALL LOCATIONS IDENTIFYING 1 1/2"
SLABFORM. ALL SLABFORM SHALL BE GALVANIZED.**

**MUNICIPAL AUTHORITY OF THE CITY OF MCKEESESPORT
ALLENTOWN COUNTY, PENNSYLVANIA**
CONTRACT NUMBER 2010-01 AND 2010-02
WASTEWATER TREATMENT PLANT EXPANSION
HEADWORKS BUILDING, STRUCTURAL PLANS AND SECTIONS

Drawing No. 220- HW29		MUNICIPAL AUTHORITY OF THE CITY OF MCKEESEPORT ALLENTOWN COUNTY, PENNSYLVANIA CONTRACT NUMBER: 01-01 AND 2011-02 WASTEWATER TREATMENT PLANT EXPANSION HEADWORKS BUILDING, PLANT EXPANSION AND SECTORS 8		KLH  ENGINEERS, INC.	
Scale: Sheet No. 19	As Shown Date: Drawn By: Checked By: Approved By:	1/10/2010 P.M. 10:00 AM HOF HOF BHG	5173 CAMPBELL RUN ROAD MYRTLEDALE, PA 18059 PHONE: 412-344-0200 FAX: 412-344-0201 E-MAIL: info@klhengineering.com	Date: 08/08/09 SUBMITTAL REVISED REVIEWED RELEASE FOR BID	Revisions None




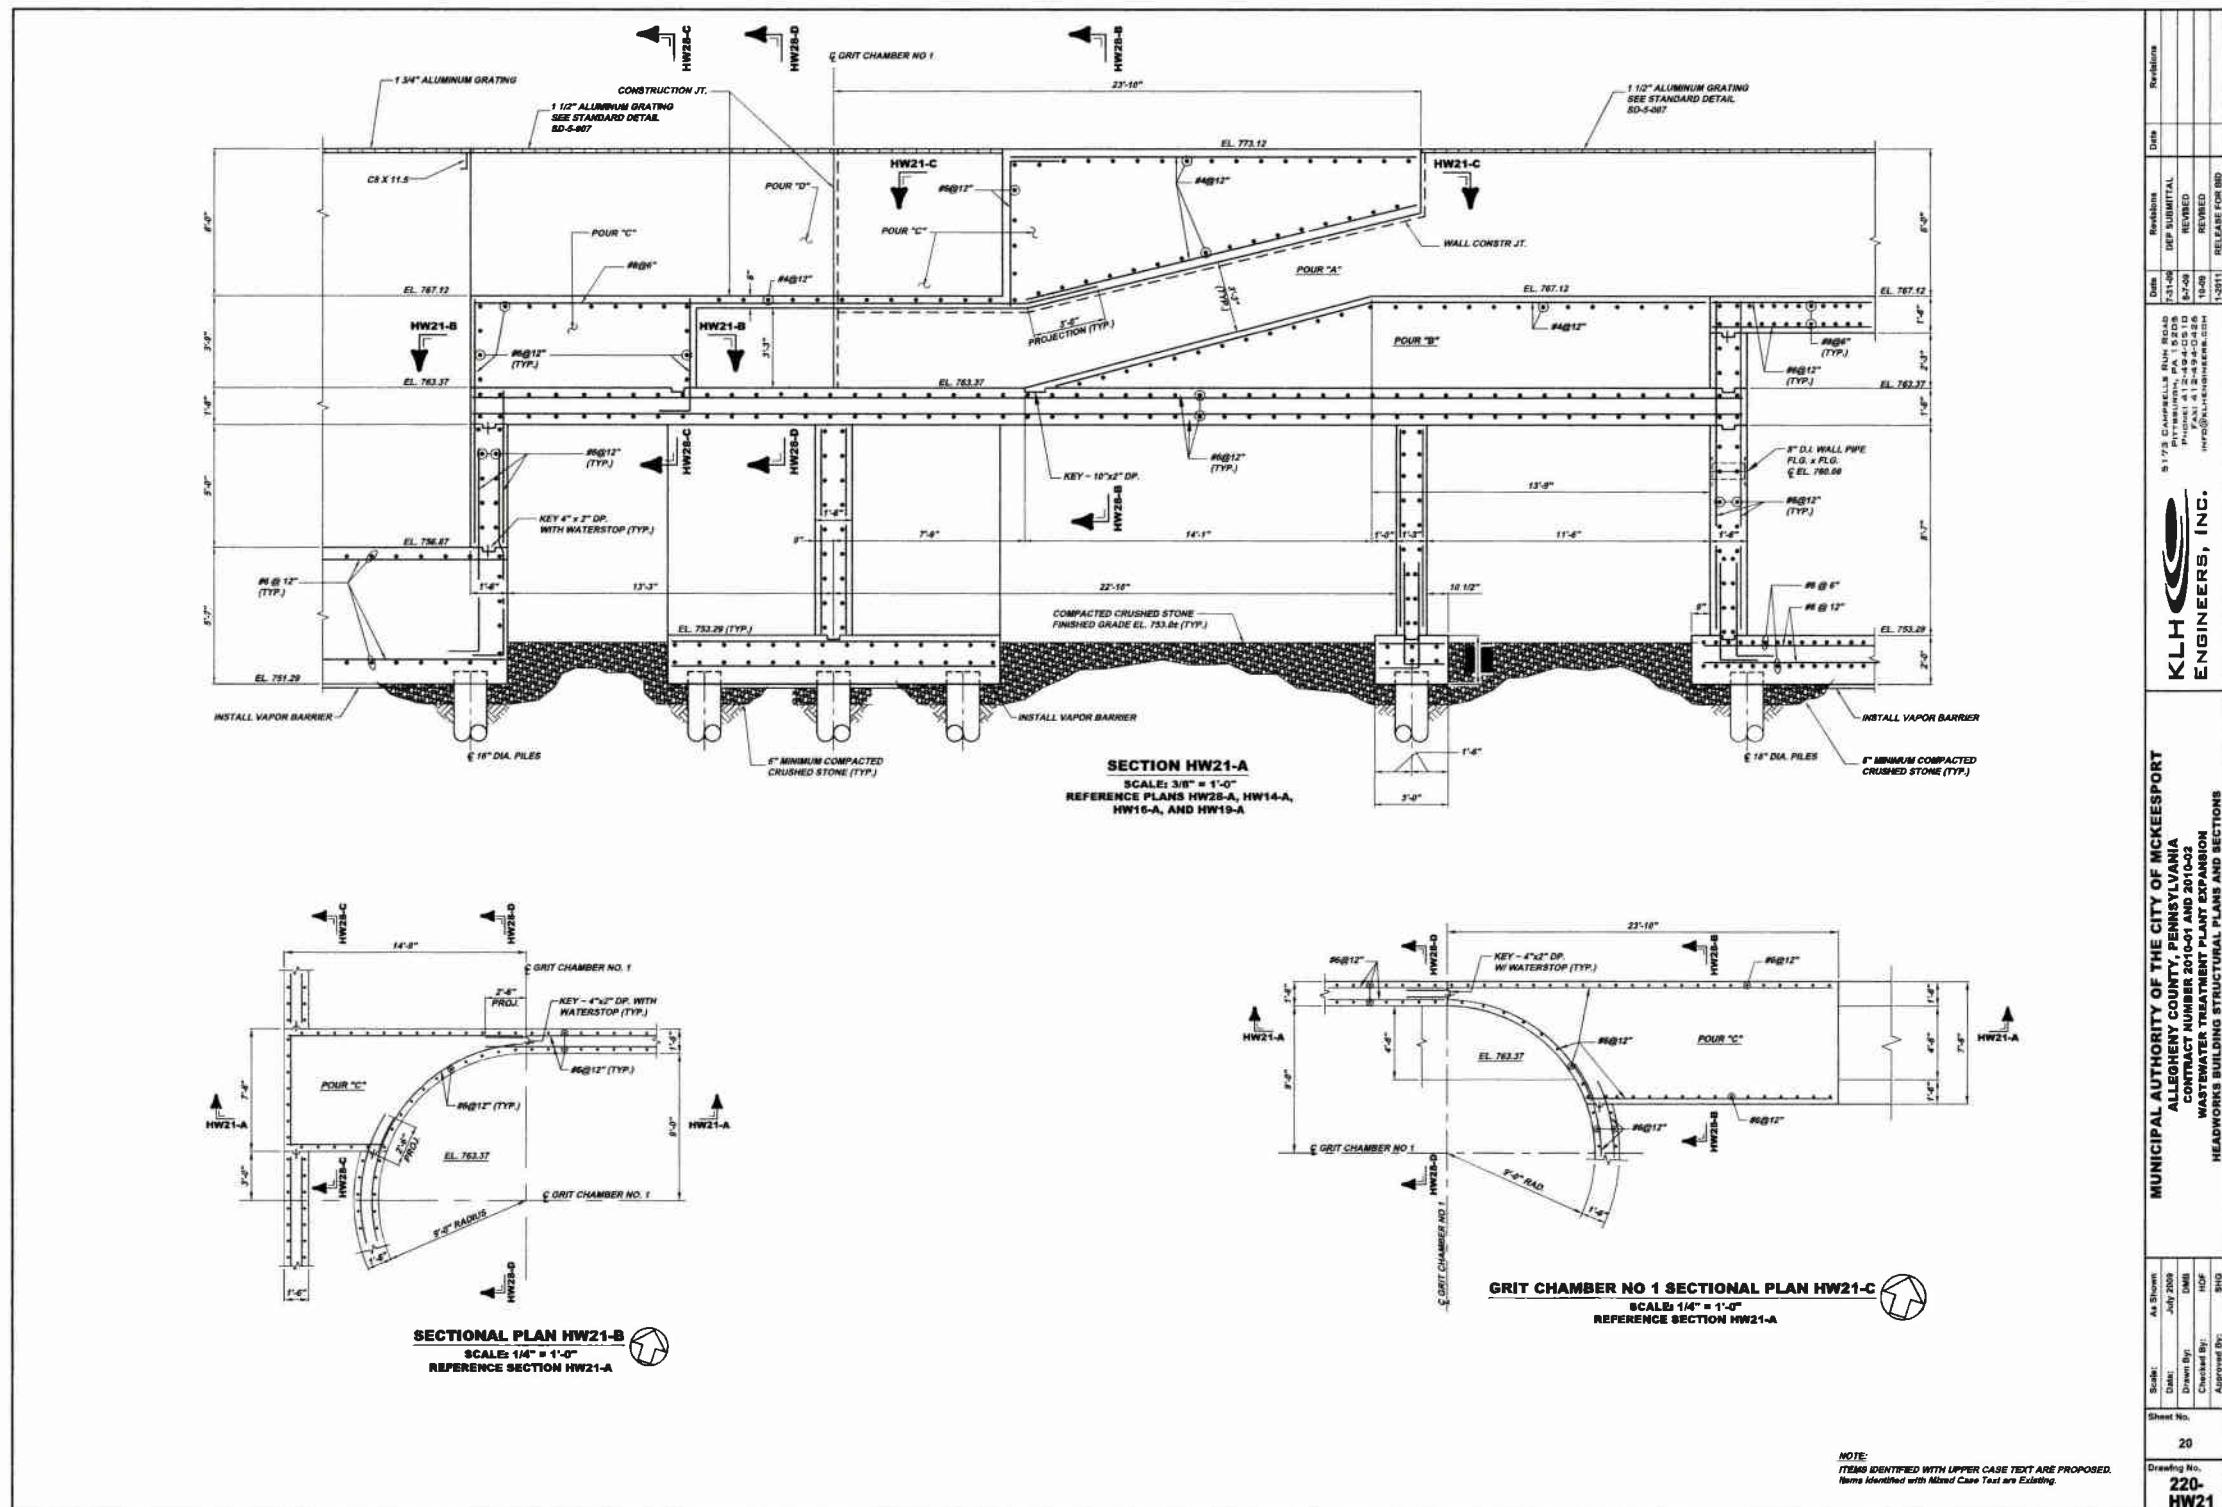


GRIT CHAMBER NO. 1 PLAN HW28-A

SCALE: 1/4" = 1'-0"
REFERENCE PLAN HW16-A




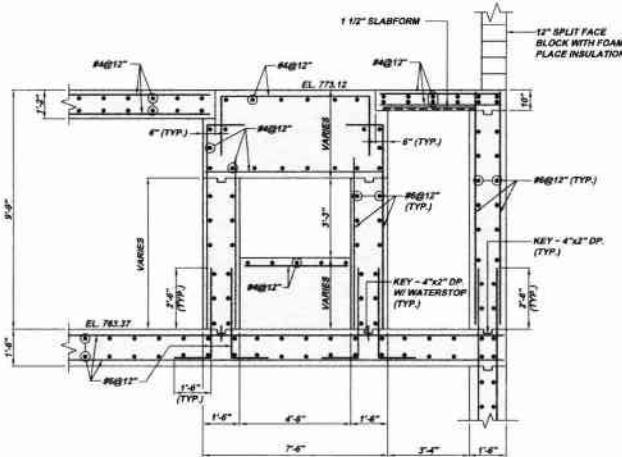

SECTION HW28-B

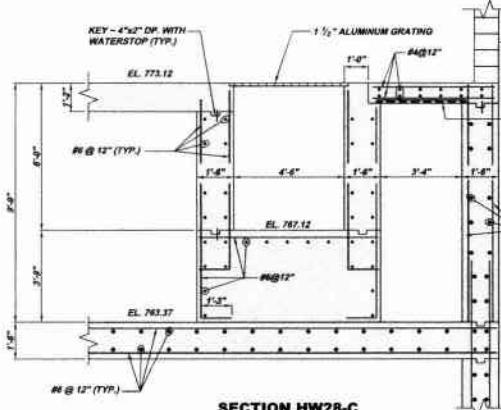

SECTION HW28-C
SCALE: 3/8" = 1'-0"
REFERENCE PLAN HW28-A

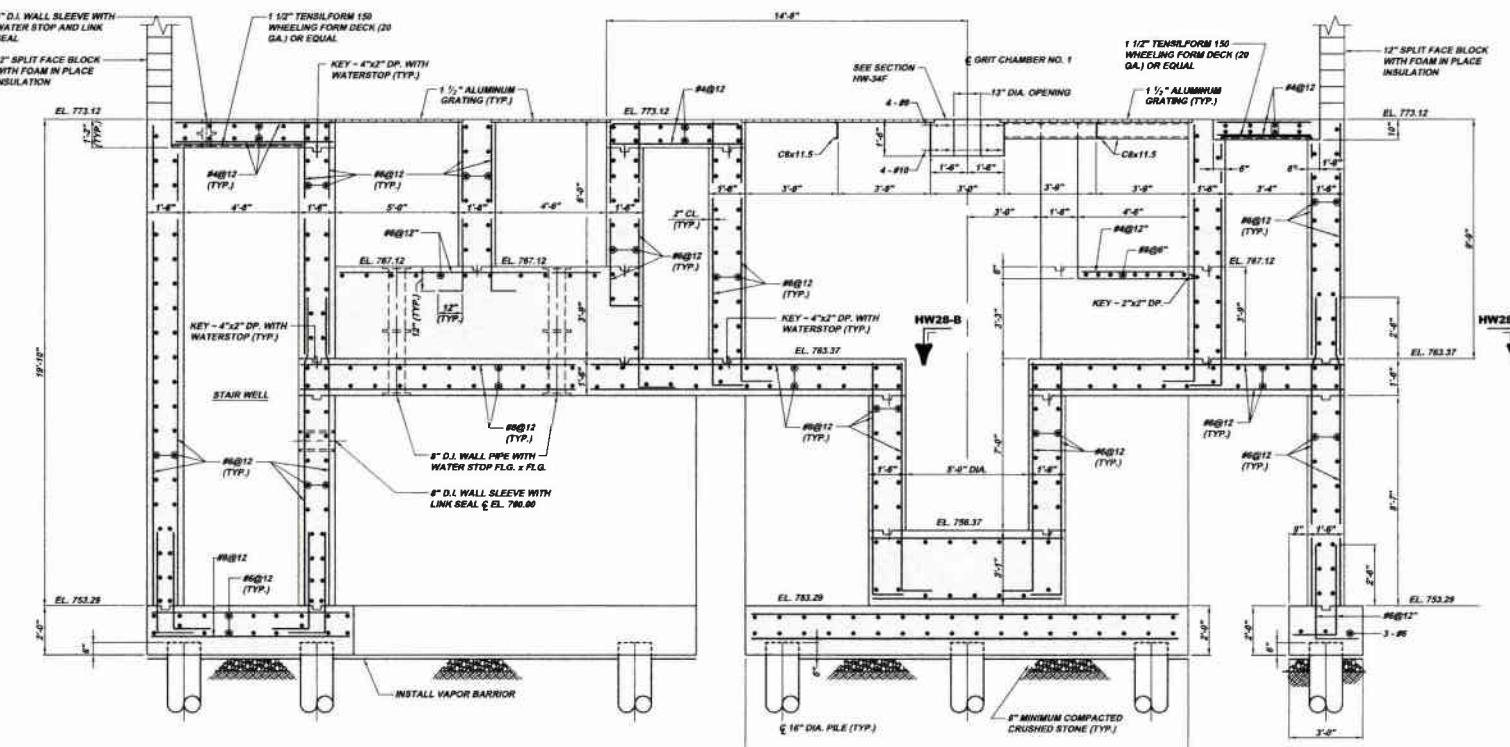


SECTION HW28-D
SCALE: 3/8" = 1'-0"
**REFERENCE PLANS HW28-A,
HW14-A, HW16-A & HW19-A**

**CONTRACTOR SHALL FURNISH AND INSTALL
TENSILFORM 200 WHEELING FORM DECK
18 GA.) OR EQUAL AT ALL LOCATIONS
IDENTIFYING 2" SLABFORM AND TENSILFORM
50 WHEELING FORM DECK (20 GA) OR EQUAL
AT LOCATIONS IDENTIFYING 1 1/2" SLABFORM.
SLABFORM SHALL BE GALVANIZED DECKING**


MUNICIPAL AUTHORITY OF THE CITY OF MCKEESPORT
ALLENTOWN COUNTY, PENNSYLVANIA
CONTRACT NUMBER 2010-01 AND 2010-02
WASTEWATER TREATMENT PLANT EXPANSION
HEADWORKS BUILDING STRUCTURAL PLANS AND SECTIONS

S 173 CAMPBELLE RUN ROAD
PITTSBURGH, PA 15205
PHONE: 412-344-0220
EMAIL: INFO@CAMPBELLERUN.COM


**ALKI
ENGINEERS, INC.**

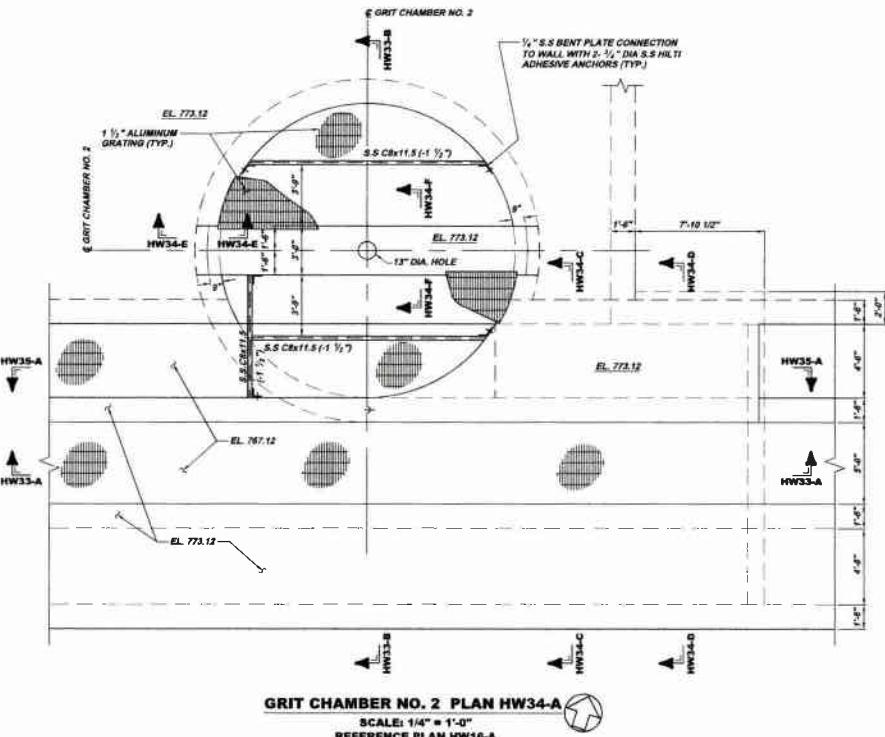


GRIT CHAMBER NO. 2 PLAN HW34-A

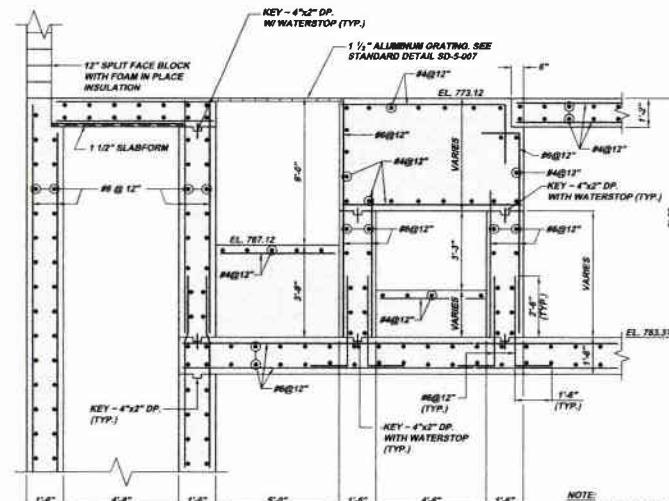


SECTION HW34-C
SCALE: 3/8" = 1'-0"
REFERENCE PLAN HW34-A & HW34-B

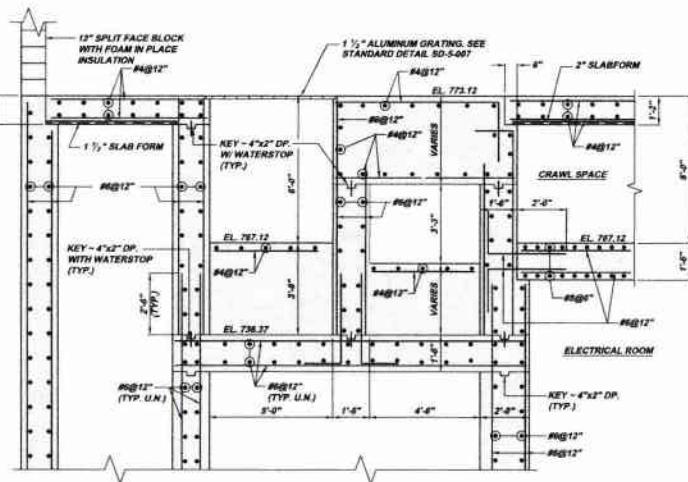

SECTION HW34-D
SCALE: 3/8" = 1'-0"
REFERENCE PLAN HW34-A & HW34-B

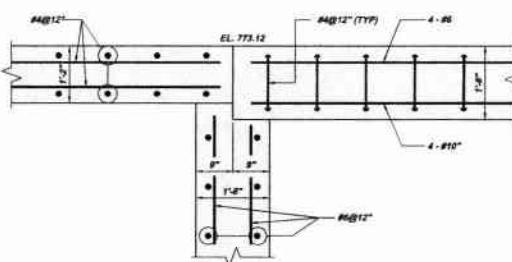

SECTION HW34-E
SCALE: 3/4" = 1'-0"

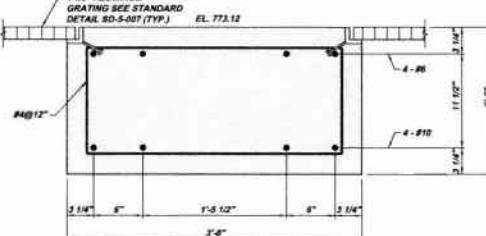

SECTION HW34-F
SCALE: 1 1/2" = 1'-0"
REFERENCE PLAN HW2B-A & HW34-A

