


EMPIRE ACCESS JACKSON STREET


W 75°41'40.79" N 41°25'10.56"
120± LF NEW 96 CT FIBER CABLE WITHIN 1-1/4" AERIAL INTERDUCT

JACKSON ST CROSSING
SCRANTON, PA
LACKAWANNA COUNTY

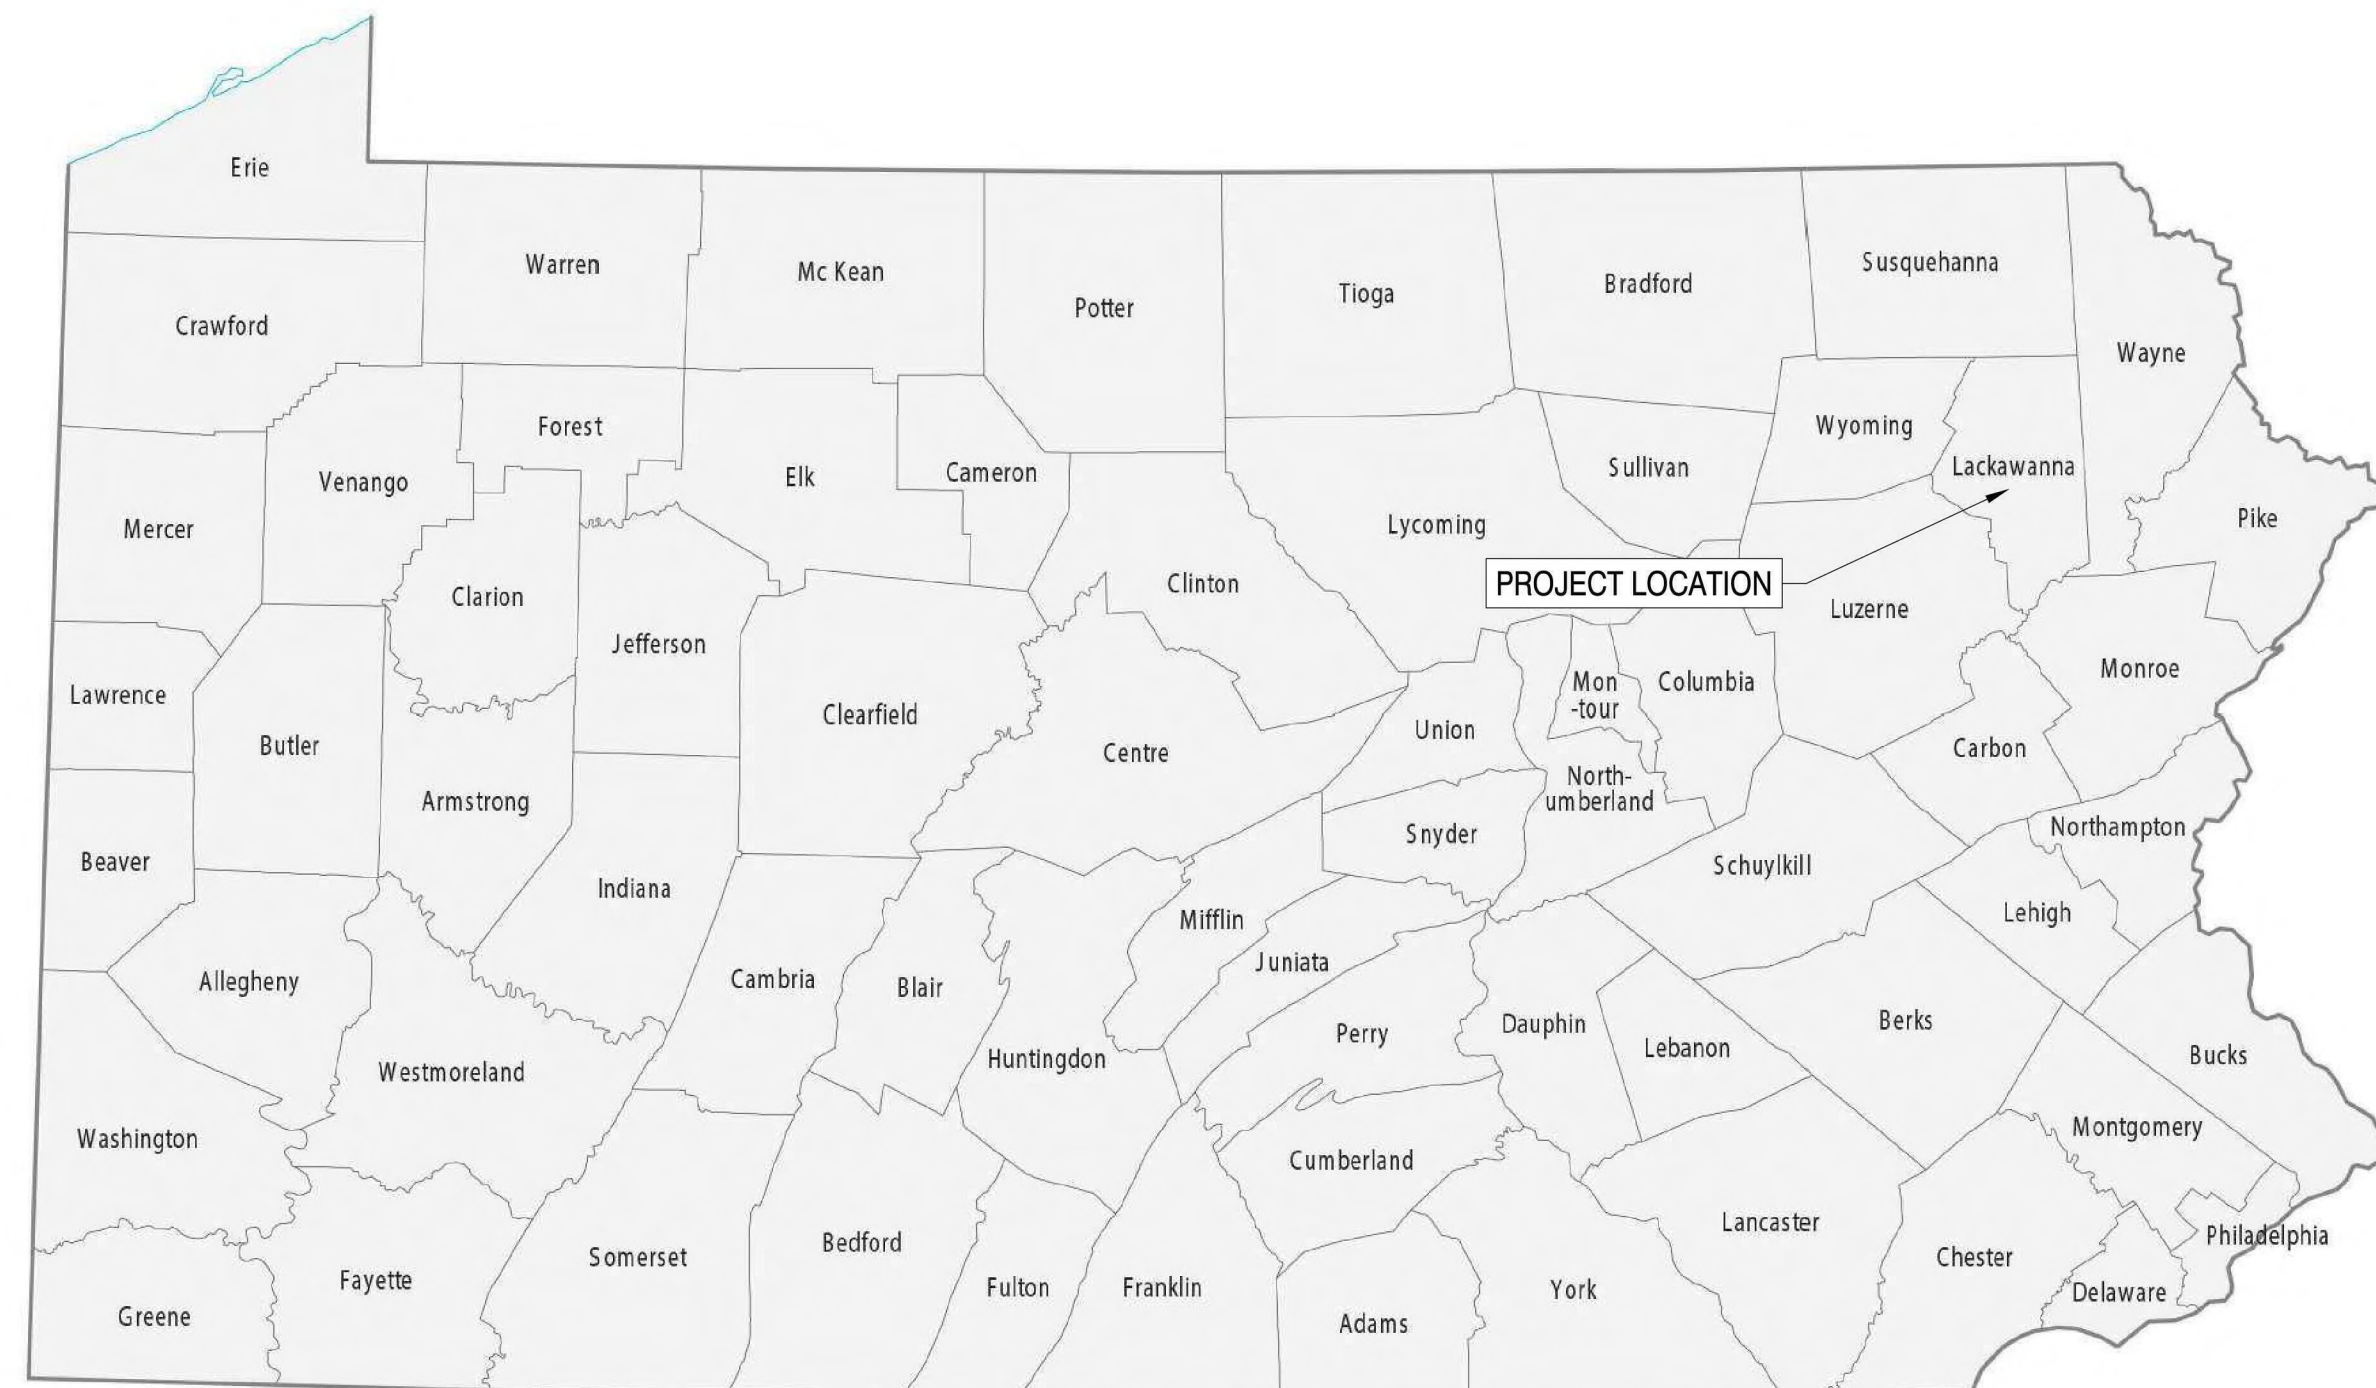

SHEET INDEX

1. C-001 - COVER
2. C-101 - JACKSON ST PLAN AND PROFILE

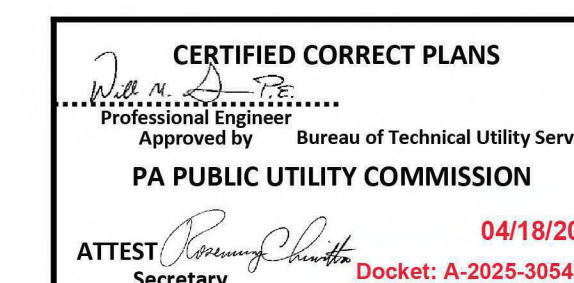

CONSULTANT TEAM:
AIROSMITH
AIROSMITH DEVELOPMENT
AIROSMITH ENGINEERING
318 WEST AVE.
SARATOGA SPRINGS, NY 12866
P-71878

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DRAWINGS ISSUED FOR:

REV.	DATE	DRAWN	DESCRIPTION	QA/QC
0	2025.01.03	AB	PERMIT PLANS	SC
1	2025.01.21	AB	PERMIT PLANS	SC
2	2025.3.19	ARW	DOT COMMENTS	HS/SC

PROJECT INFORMATION:
**JACKSON STREET
CITY OF SCRANTON
LACKAWANNA COUNTY, PA**

120± LF NEW 96 CT
FIBER CABLE WITHIN
1-1/4" AERIAL INTERDUCT

SHEET TITLE:
COVER SHEET


SHEET NUMBER: **C-001** REVISION: **2**



CONSULTANT TEAM:
AIROSMITH
 AIROSMITH DEVELOPMENT
 AIROSMITH ENGINEERING
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PROJECT INFORMATION:
JACKSON STREET
 CITY OF SCRANTON
 LACKAWANNA COUNTY, PA
 120± LF NEW 96 CT
 FIBER CABLE WITHIN
 1-1/4" AERIAL INTERDUCT

SHEET TITLE:
**PLAN
 AND PROFILE**

SHEET NUMBER: **C-101** REVISION: **2**

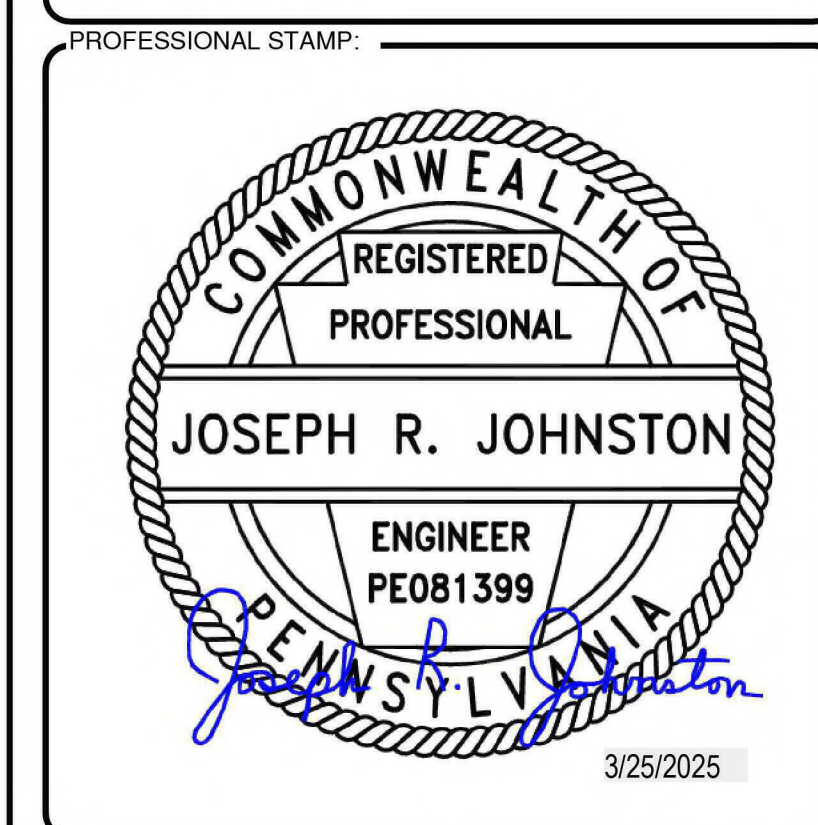LEGEND

GV	⊗	GAS VALVE
CO	⊙	CLEANOUT
HH	■	HAND HOLE
GM	⊘	GAS METER
LP	⊙	LIGHT STANDARD
DS	⊘	DRAINAGE STRUCT.
HYD.	⊙	FIRE HYDRANT
WV	⊙	WATER VALVE
I.P. 1/16"	⊙	EXISTING IRON PIPE
UP	⊙	UTILITY POLE
PL	---	PROPERTY LINE
---	---	EASEMENT LINE
---	---	CENTERLINE
---	---	SUBLOT LINE
---	---	ROW LINE
---	---	FENCE
---	---	TREE
---	---	EDGE OF WOODS
---	---	BRUSH LINE
---	---	NEW BUILD IN ROW
---	---	NEW BUILD OUTSIDE ROW

PROJECT INFORMATION


THIS PROJECT CONSISTS OF 120± LF OF NEW 96 CT FIBER WITHIN 1-1/4" AERIAL INTERDUCT.

SURVEY DATA

DELINEATION OF RIGHT OF WAY AND BASE MAPPING OBTAINED FROM SURVEY COMPLETED BY NORTHEAST TOWER SURVEYING, INC. DATED 12/18/2024.



UTILITY QUALITY LEVEL: QL-C

NOTE:
 THE LOCATION, SIZES, AND ELEVATIONS OF EXISTING UTILITIES ARE BASED ON INFORMATION COMPILED FROM FIELD WORK, RECORD DRAWINGS AND INFORMATION FURNISHED BY VARIOUS UTILITY COMPANIES WITH FIELD EDITING WHERE NECESSARY AND POSSIBLE. THE ACCURACY OF THIS INFORMATION IS NOT GUARANTEED AND SHALL BE VERIFIED BY THE CONTRACTOR.

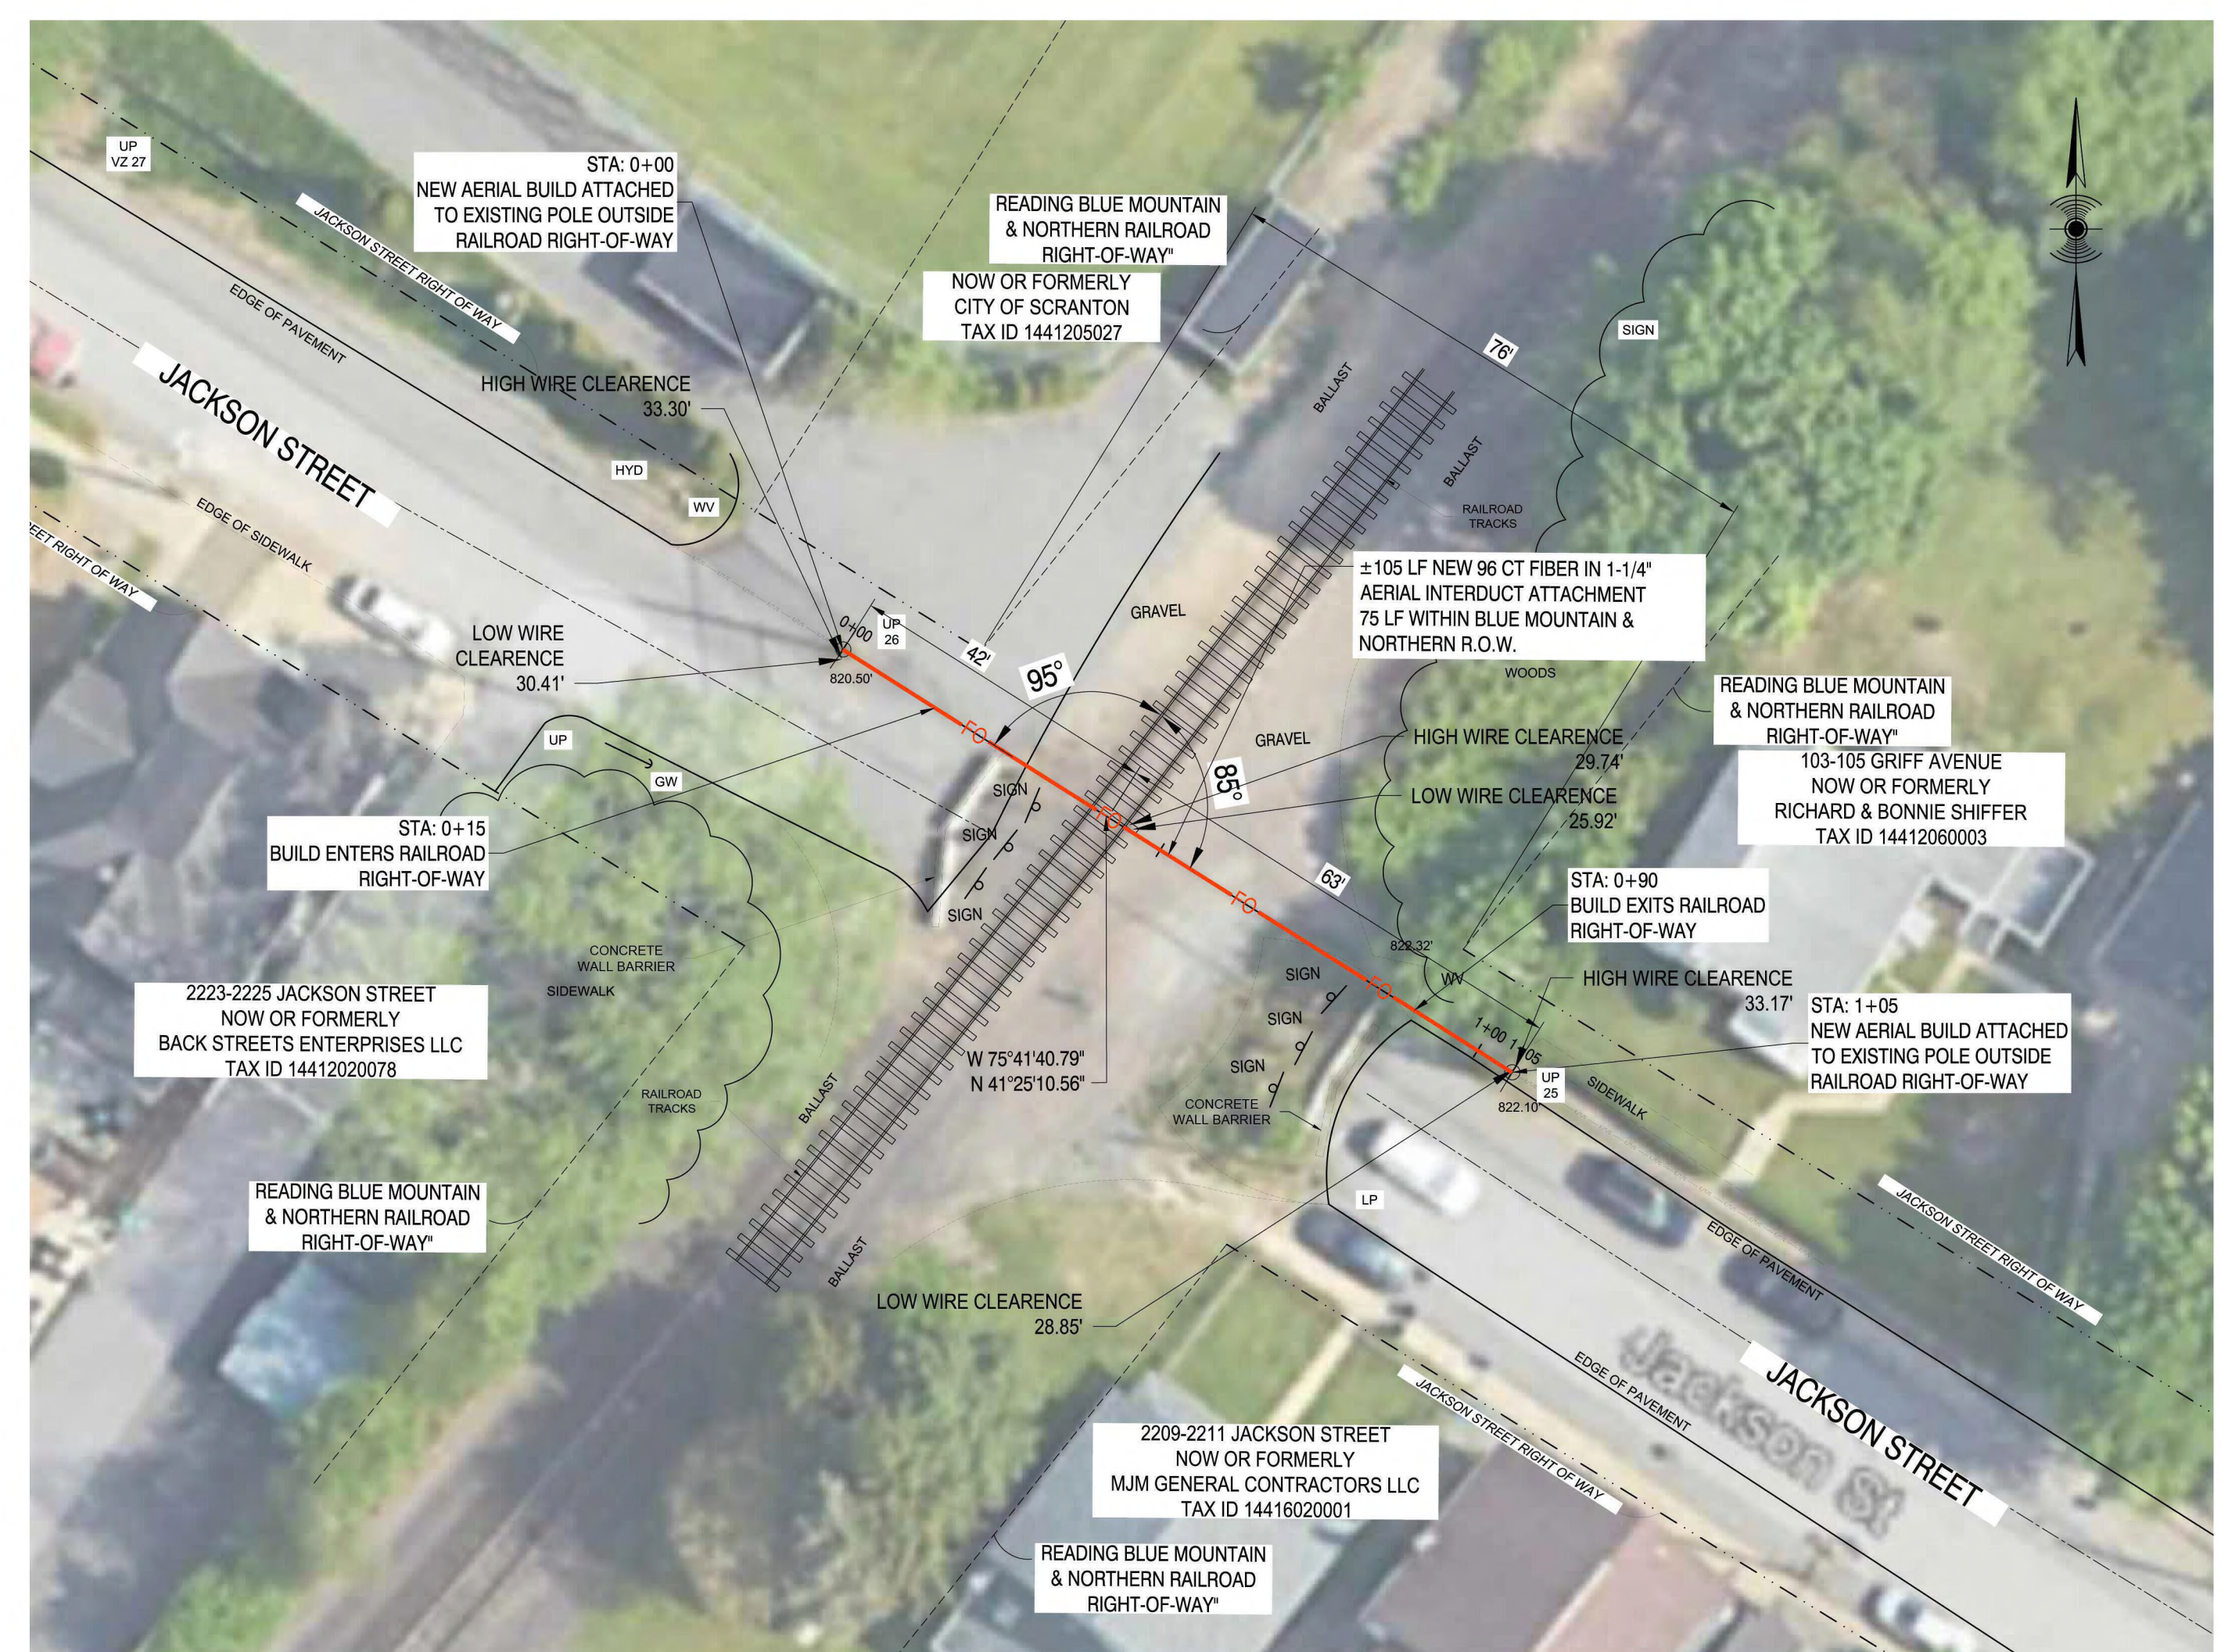

JACKSON STREET - PLAN

SCALE: 1" = 20'

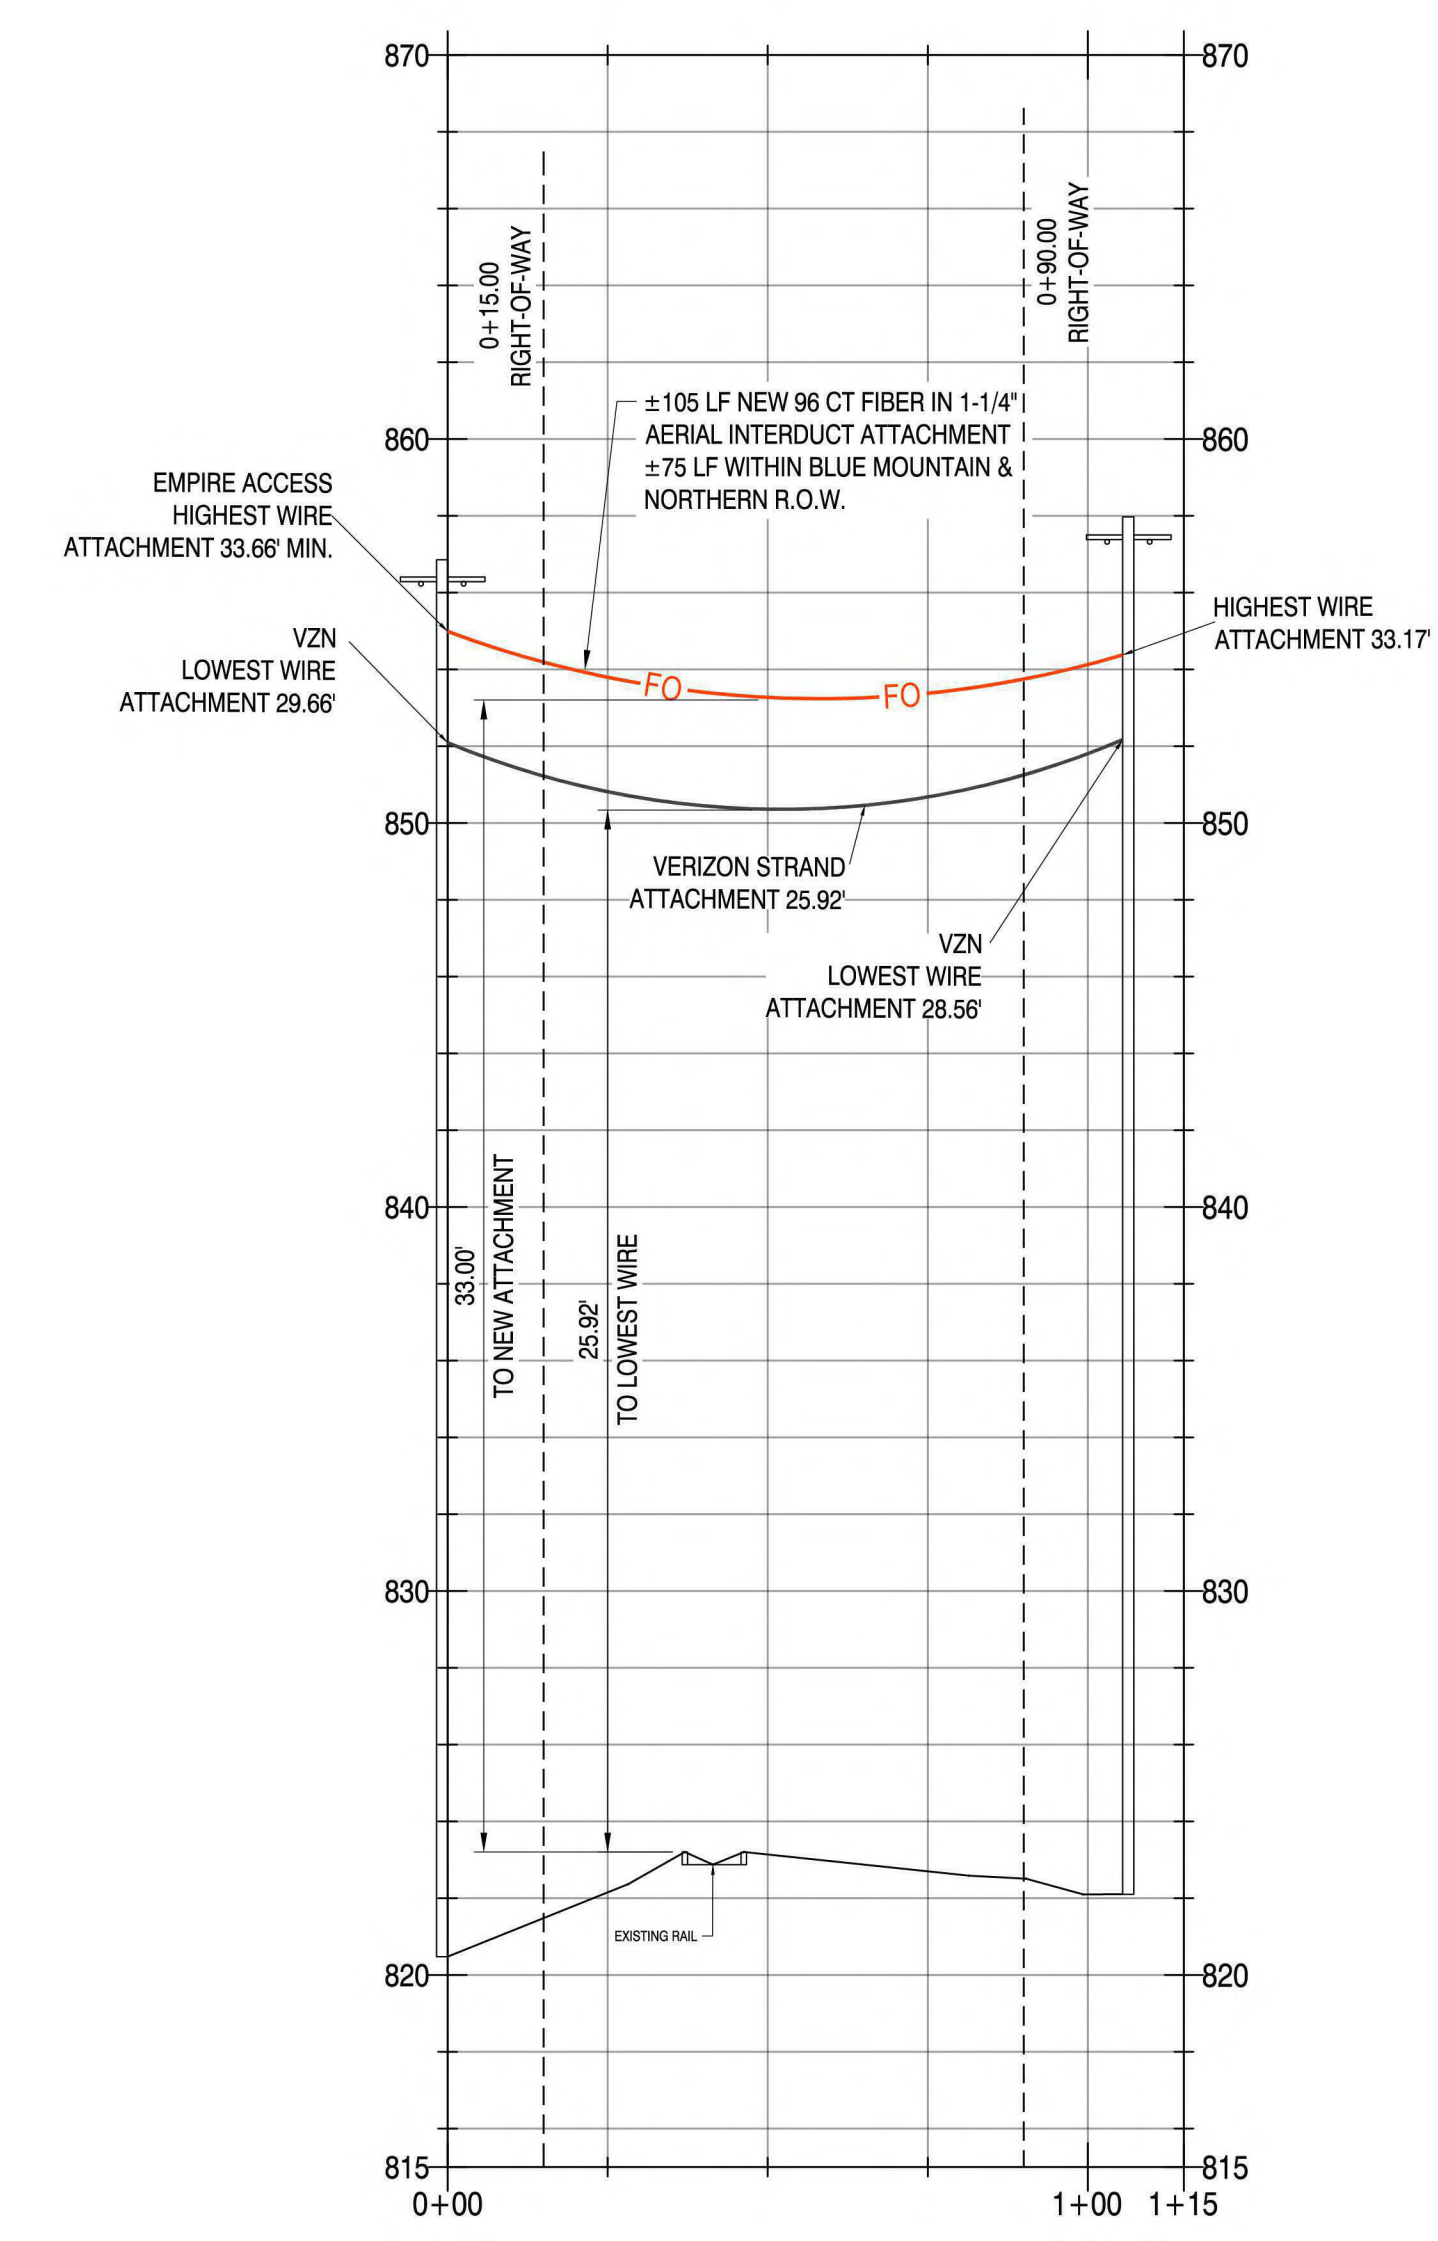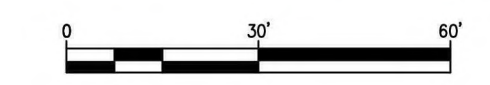

JACKSON STREET - PROFILE

SCALE: HORIZONTAL: 1" = 30'
 VERTICAL: 1" = 5'

